


Window Legend:	
#	Egress Window
*	Secure By design
OB	Obscure Glazing
SGP	Solid Glazed Panel
EVC	Electric Vehicle Charger
MJ	Movement Joint
BB	Bat box
SB	Swift box



REAR ELEVATION

SCALE 1:50

Window Legend:	
#	Egress Window
*	Secure By design
OB	Obscure Glazing
SGP	Solid Glazed Panel
EVC	Electric Vehicle Charger

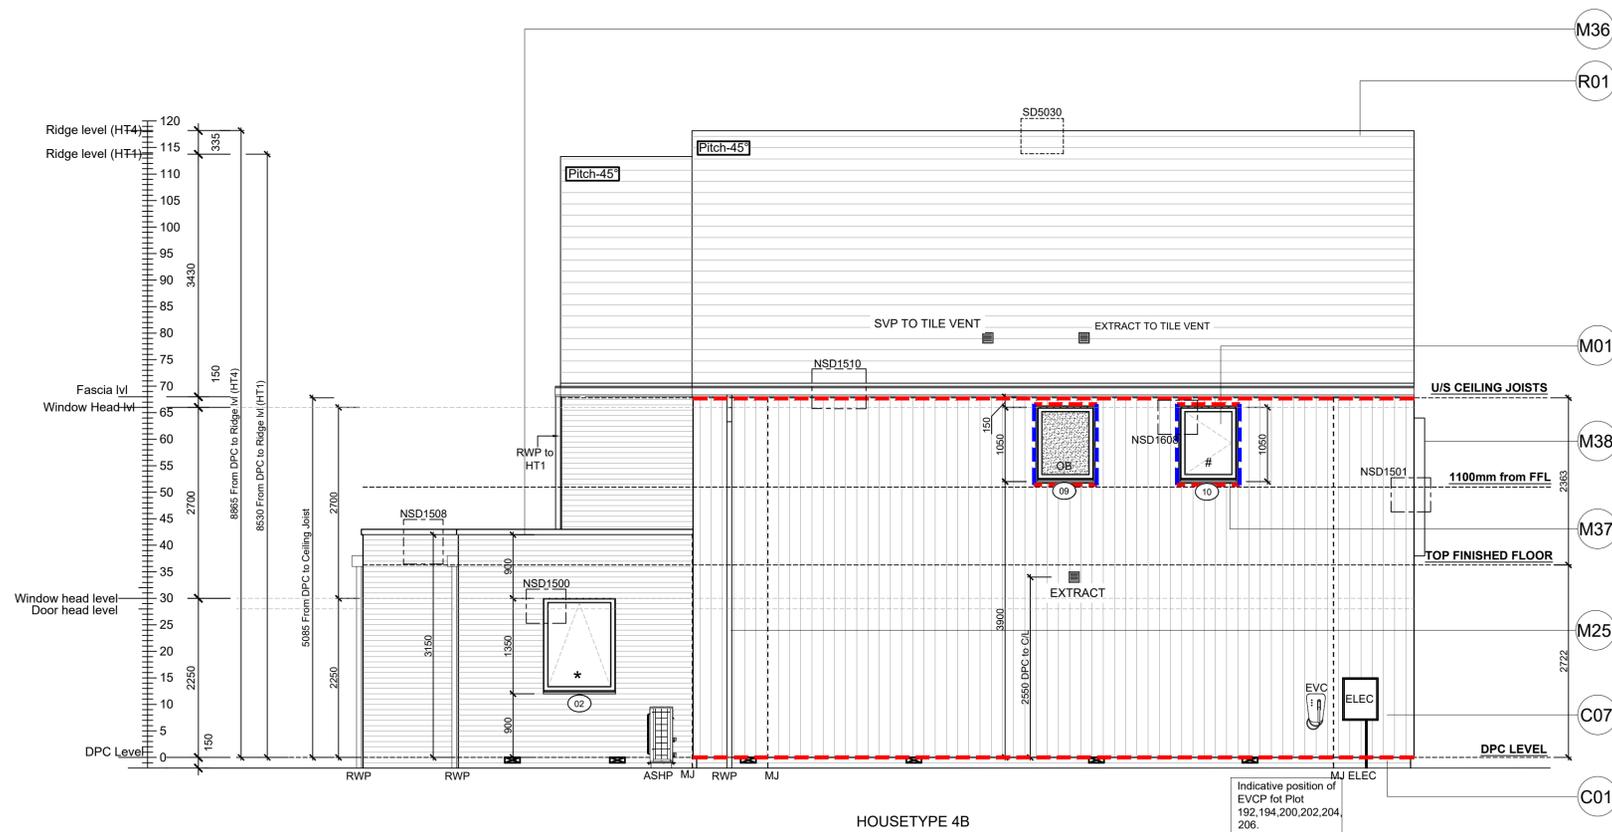

SIDE ELEVATION

SCALE 1:50

Refer to SE Drawings
SA00394-4569-S-HTSemi 2/ Semi
2A-SS for Bed joint re-inforcement

Notes
All dimensions to be checked on site prior to the commencement of construction and any discrepancy should be reported to the Site Manager.

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Sub-Contractors MUST ensure that they have the latest issue drawing before they commence work on site.

This drawing is to be read in conjunction with all relevant Specifications, schedules and Engineers details.

RWP/MJ positions to be finalised on Architects drawings on an individual site by site basis

Meter positions to be finalised on Architects drawings on an individual site by site basis

Material Key

Key	Material
C01	Rifer to EMS for plot specific brick colour.
C06	Clay-effect plain hung tile - burnt orange
C07	Fibre cement timber effect vertical boarding - Hardie Plank "Midnight Black" or similar
D06	Alternating 25mm horizontal recessed brick detail - to match facing brick
M01	Window frame - RAL 7015
M06	Framed glazed door - RAL 7015
M12	Timber-effect door with vertical panelling and glazed fanlight - RAL 7015
M25	Rainwater goods - dark grey
M26	Fascia board - RAL 7015
M36	Powder coated aluminium coping with fall to inside - RAL 7015
M37	Minimum 20mm thick board forming lining to window recess - painted RAL 9005 or similar to match vertical boarding M
M38	Slim profile extruded surround fixed into window recess and projecting 200mm from wall outer face - RAL 7015
M40	Slim profile powder coated aluminium entrance canopy - RAL 7015
R01	Slate effect plain tile - grey
R02	Clay effect plain tile - burnt orange
R03	Skylight - RAL 7015
R05	Flat roof membrane - grey

Rev	Date	Description	Int.
I	09.10.24	Weatherboarding / Tile hung cavity fire barriers	DF
		added in accordance with email dated 03.09.24	
H	25.09.24	Chimney width amended to sit on wall, door ht revised to 2100	ZJ
G	09.08.24	ASHP added. Ext Tap position revised. Win 03 height revised. Material key updated. All First fl win head ht amended to comply with Part O. FFL dims revised, Parapet dim amended. Dims Rod revised, overall building height revised. Rwp position amended. Hopper position revised. Ecology feature key & elevations co-ordinated.	SK
F	19.04.24	Ecological feature added. New Detail refs added	SK
E	16.02.24	Issued for Construction. MJ updated	ZJ
D	14.12.23	Revised as per Clients comments (01.11.23). Legend amended, extracts co-ordinated with Vectaire drawings, EVC added. Material key amended.	SK



Job title
**Brooklands College
Weybridge**

Drawing title
**HT Semi 2 (HT4BLaurel & HT1 Fir)
Plots: 192/193 194/195 200/201
202/203 204/205 206/207
Elevations**

Scale: 1:50 @ A1
Date: May 2023

Rev: I
Drawn: RR

Dwg No.
SA00394-0196-A-SEMI2-ELE

Weatherboard / Tile Hung - Cavity Fire Barrier Legend:	
- - -	Dashed line denotes Tenmat VFB Plus intumescent cavity fire barrier.
- - -	Dashed line denotes Tenmat NVFB LD cavity fire barrier.