


Window Legend:  
 # Egress Window  
 \* Secure By design  
 OB Obscure Glazing  
 SGP Solid Glazed Panel

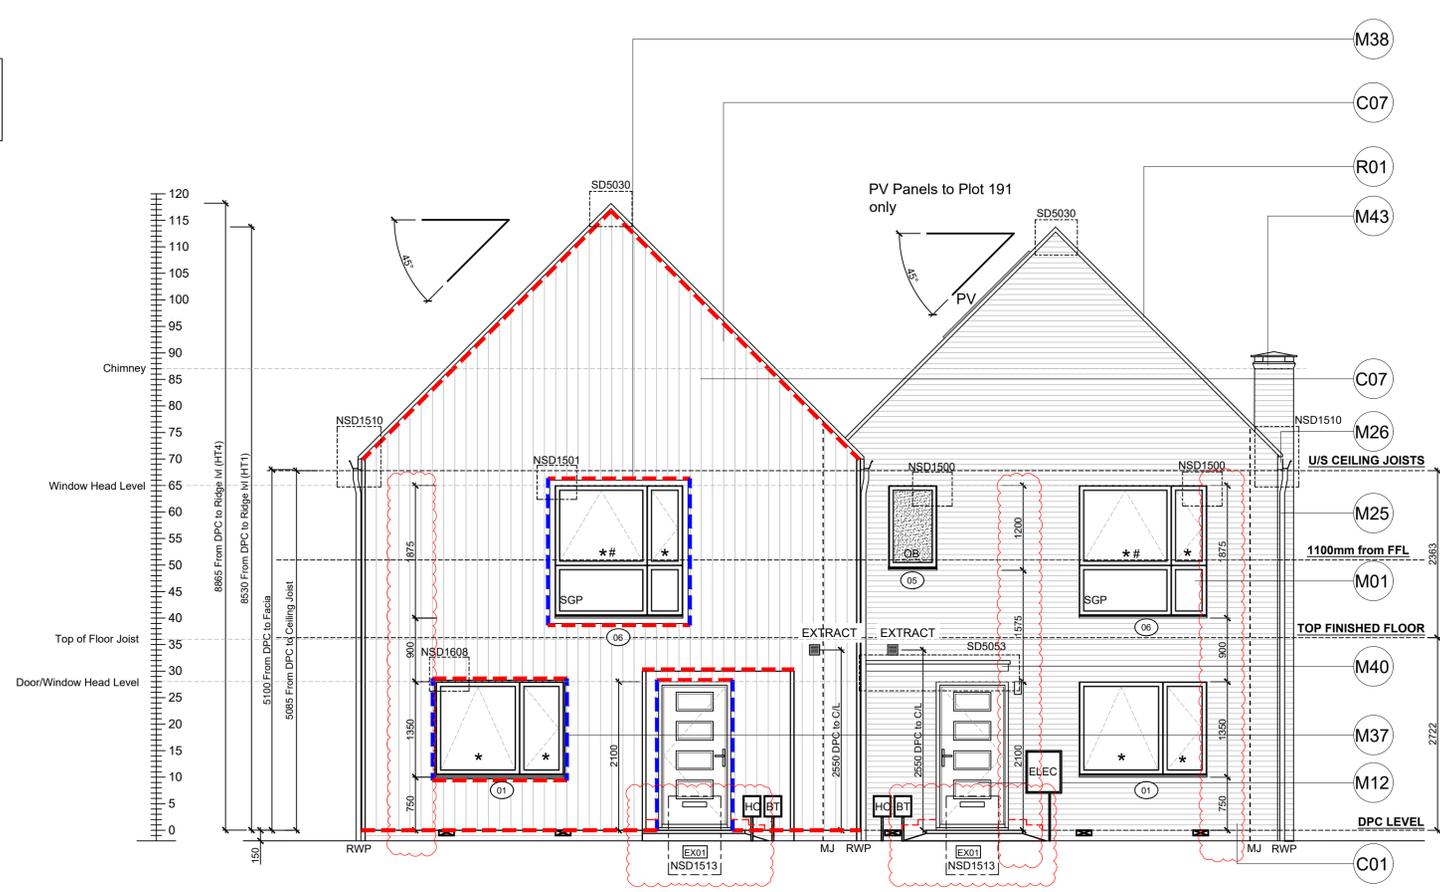

**FRONT ELEVATION**  
 SCALE 1:50

HOUSETYPE 4B1

HOUSETYPE 1

Refer to SE Drawings  
 SA00394-4570-S-HTSemi 2/ Semi  
 2A-SS for Bed joint re-inforcement

Notes  
 All dimensions to be checked on site prior to the commencement of construction and any discrepancy should be reported to the Site Manager.  
 This drawing may not be reproduced in any part or form without written consent.  
 All copyrights reserved.  
 Sub-Contractors MUST ensure that they have the latest issue drawing before they commence work on site.

This drawing is to be read in conjunction with all relevant Specifications, schedules and Engineers details.

RWP/MJ positions to be finalised on Architects drawings on an individual site by site basis


Meter positions to be finalised on Architects drawings on an individual site by site basis

**Material Key**

Key	Material
C01	Refer to EMS for plot specific brick colour.
C06	Clay-effect plain hung tile - burnt orange
C07	Fibre cement timber effect vertical boarding - Hardie Plank "Midnight Black" or similar
D06	Alternating 25mm horizontal recessed brick detail - to match facing brick
M01	Window frame - RAL 7015
M06	Framed glazed door - RAL 7015
M12	Timber-effect door with vertical panelling and glazed fanlight - RAL 7015
M25	Rainwater goods - dark grey
M26	Fascia board - RAL 7015
M36	Powder coated aluminium coping with fall to inside - RAL 7015
M37	Minimum 20mm thick board forming lining to window recess - painted RAL 9005 or similar to match vertical boarding M
M38	Slim profile extruded surround fixed into window recess and projecting 200mm from wall outer face - RAL 7015
M40	Slim profile powder coated aluminium entrance canopy - RAL 7015
R01	Slate effect plain tile - grey
R02	Clay effect plain tile - burnt orange
R03	Skylight - RAL 7015
R05	Flat roof membrane - grey

Rev	Date	Description	Int.
J	08.12.25	Window 02A updated. Stepped dpc highlighted.	DF
		Chimney detail refs added. Window head levels amended. 14.10.24	ZJ
I	09.10.24	Weatherboarding / Tile hung cavity fire barriers added in accordance with email dated 03.09.24	DF
H	25.09.24	Chimney width amended to sit on wall, door ht revised to 2100	ZJ
G	09.08.24	ASHP added. Material kept updated.	SK
		All First fl win head ht and Win 06 transome height amended to comply with Part O. FFL dims revised	
		Dims Rod revised, overall building height revised.	
		Canopy ref added. Parapet dim amended.	
		Front door design amended. Hopper omitted.	
		Electric Meter moved as it clashes with MJ	
		RWP position amended. Ecology feature key & elevations co-ordinated.	

Window Legend:  
 # Egress Window  
 \* Secure By design  
 OB Obscure Glazing  
 SGP Solid Glazed Panel  
 EVC Electric Vehicle Charger  
 MJ Movement Joint  
 BB Bat box  
 SB Swift box

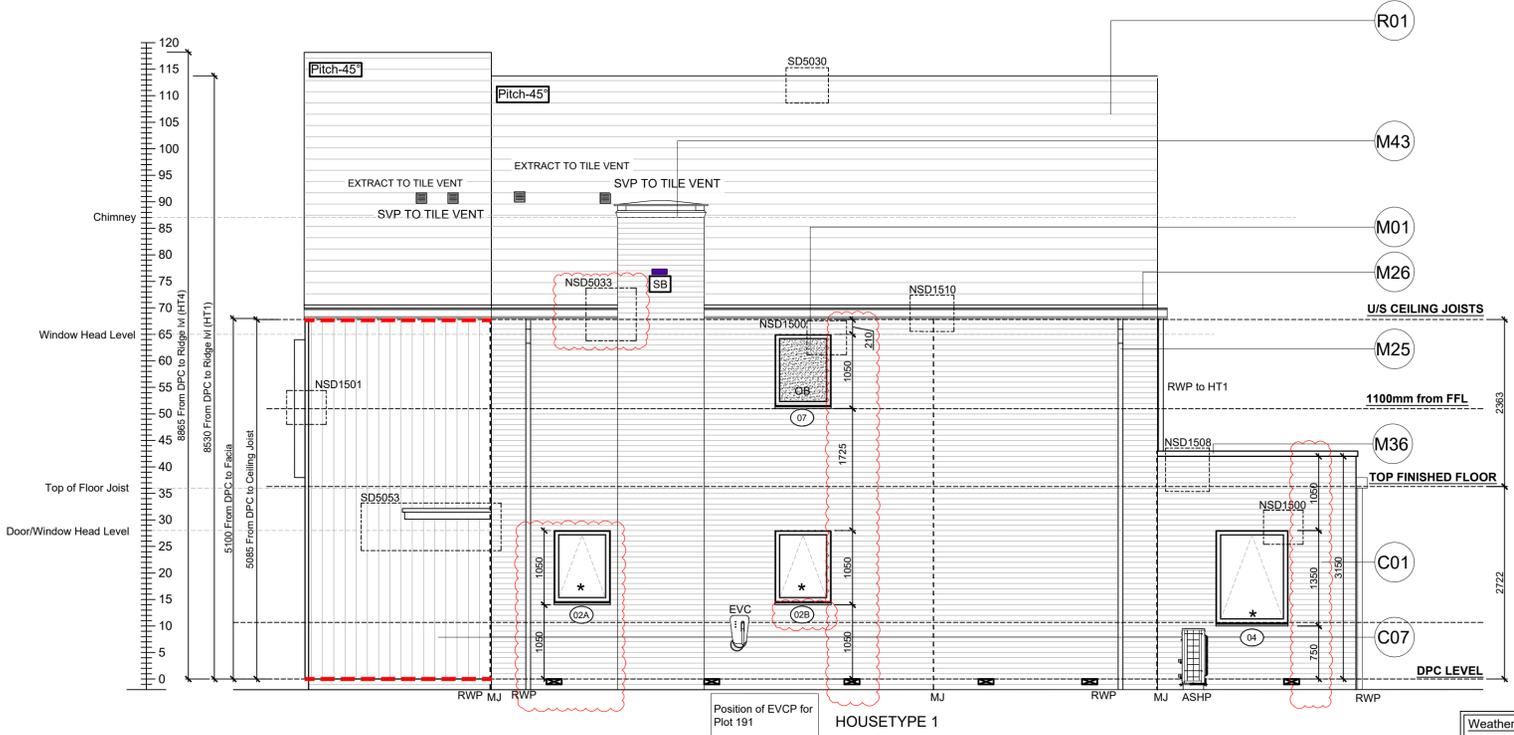

**SIDE ELEVATION**  
 SCALE 1:50

HOUSETYPE 1

Weatherboard / Tile Hung - Cavity Fire Barrier Legend:  
 - - - Dashed line denotes Tenmat VFB Plus intumescent cavity fire barrier.  
 - - - Dashed line denotes Tenmat NVFB LD cavity fire barrier.



Job title  
 Brooklands College  
 Weybridge

Drawing title  
 HT Semi 2A  
 HT4B1 (Laurel) & HT1 (Fir)  
 Plots: 190/191  
 Elevations

Scale 1:50 @ A1 Date May 2023

Rev. J Drawn RR

Dwg No. SA00394-0165-A-SEMI2A-ELE