

<p>INTERMITTENT EXTRACT VENTILATION:</p> <p>Kitchen = 30L/S Adjacent hob; Utility = 30L/S; Bathroom = 15L/S; En-Suites = 15L/S; Clk's = 6L/S</p>
<p>PURGE VENTILATION:</p> <p>All windows to habitable rooms to open more than 30 deg's. each habitable room to be provided with an openable window(s) with an opening area equal to 1/20th of the rooms floor area.</p>
<p>STAIRCASE - GRD-1st</p> <p>13 equal risers of 209.38mm; Going = 234mm; Pitch 41.82°; Width over strings - 860mm</p>
<p>ROOF VENTILATION (TYPE 1)</p> <p>An impermeable roofing underlay (Type 1F / HR) is to be draped over all roof pitches, with Rytons OFV1000 (or similar approved) over fascia ventilator providing ventilation equivalent to a continuous 10mm opening at eaves level, and Glidevale Fulmetal Rediroll ventilated dry ridge system (or similar approved) providing ventilation equivalent to a continuous 5mm opening at ridge level.</p>
<p>Padstones and steel beam sizes as per SE Drawings</p> <p>← Refer to specialist for joist sizes</p>

GENERAL ARRANGEMENT PLANS - WALL LEGEND

-  Frost resistant quality facing brickwork 20N Brickwork laid in minimum class iii (M4) mortar
-  Medium dense blockwork to outer leaf behind tile hanging / cladding
-  Compressive strength 7.3N/mm² minimum class iii (M4) mortar.
-  Compressive strength 3.5N/mm² minimum class iii (M4) mortar.
- Note: All external wall cavities to be 125mm unless otherwise specified.



70mm British Gypsum Gypframe 70S50 'C' stud system, with studs at 600mm centres. 12.5mm Gyproc Soundbloc plasterboard each side with tapered edges, finished as per internal spec. Moisture-resistant plasterboard to bathroom with studs at 400mm centres.



70mm Buttressing Wall with 12mm Ply Sheathing as per SD/3022.



12.5mm Gyproc Soundbloc plasterboard each side with tapered edges, finished as per internal spec. Moisture-resistant plasterboard to bathroom with studs at 400mm centres.



63x38mm timber studs @ max 600mm centres. 50mm Isovap acoustic partition roll (APR 1) to be installed between studwork for the entire wall panel

-  Movement Joints
-  Denotes the position of the external cavity fire Soc.

IMPORTANT NOTE:

ALL EXTERNAL WALLS TO INCORPORATE BRICKFORCE SBF30W60 BED-JOINT REINFORCEMENT TO OUTER & INNER LEAF OF BLOCKWORK 2x COURSES ABOVE BELOW ALL OPENINGS & TO PROJECT A MIN. 600mm BEYOND OPENING.

ELECTRICAL KEY	
This electrical legend is to be read in conjunction with the internal specification & M&E consultants details if applicable with any discrepancies being reported to the site manager. Doorbells, light switches, entryphones, etc. should be fixed no higher than 1200mm above FFL. TV, BT & power sockets should be fixed no lower than 450mm above FFL. All wall lights to be fitted at 2100mm above FFL.	
Symbol	Description
	Flush double switch socket.
	Flush double switch socket with 2 USB points.
	External socket.
	13A flush unswitched spur.
Where switches are located all in the same wall, use 2/3/4 gang switches.	

Symbol	Description
	Flush double switched socket 200mm above kitchen work top with 2 USB points
	Flush rocker light switch. 1,2 or 3 way switched.
	Ceiling rose light point.
	LED downlighter light fitting.
	Under-stair oval bulkhead wall mounted light.
	External Wall light.
	Batten holder light fitting.
	Door bell push.
	Door bell sounder.

Symbol	Description	Symbol	
X	Flush double switched socket 200mm above kitchen work top.	● 2	Dual
△	13A Flush unswitched outlet 300mm below kitchen work top.	⊕	Single
A	Flush 30A cooker switch 200mm above kitchen work top.	⊕	RJ45
—	Gas point.	□	HDM
◐	Shower head & control position.	▲	Imm
□	Ceiling mounted extract fan.	—	Rad/
△	Isolator switch.	P	Heat
▲	Shaver socket.	G	Grid
■		T	Ther

Description	Symbol	Description
TV/ FM point 1xCT100 cabling (diplexer).		Carbon Monoxide Detector.
slave phone socket 1xCAT 6 cabling.		Smoke Detector.
data point		Heat Detector.
port (4 & 5 beds only)		For sites with FTTP refer to SD/1002. For sites with FTTC refer to SD/1003. <small>inc Consumer unit</small>
ersion heater switch, located in AC.		For full lounge plate specification refer to CALA Group Internal Specification.
Rail.		Intruder Alarm unit to Nacoss Standard
ng control programming switch.		Alarm Panel
switch.		
mostat.		
		For sites where virgin is to be provided, Virgin Media blanking plates are to be provided adjacent to the low level Lounge Plate in the lounge, and next to the TV/FM socket within the Family Room and Master Bedroom.
		External wall mounted Electric Meter
		British Telecom Point
		Hyper Optic Point
		Underfloor Heating Manifold

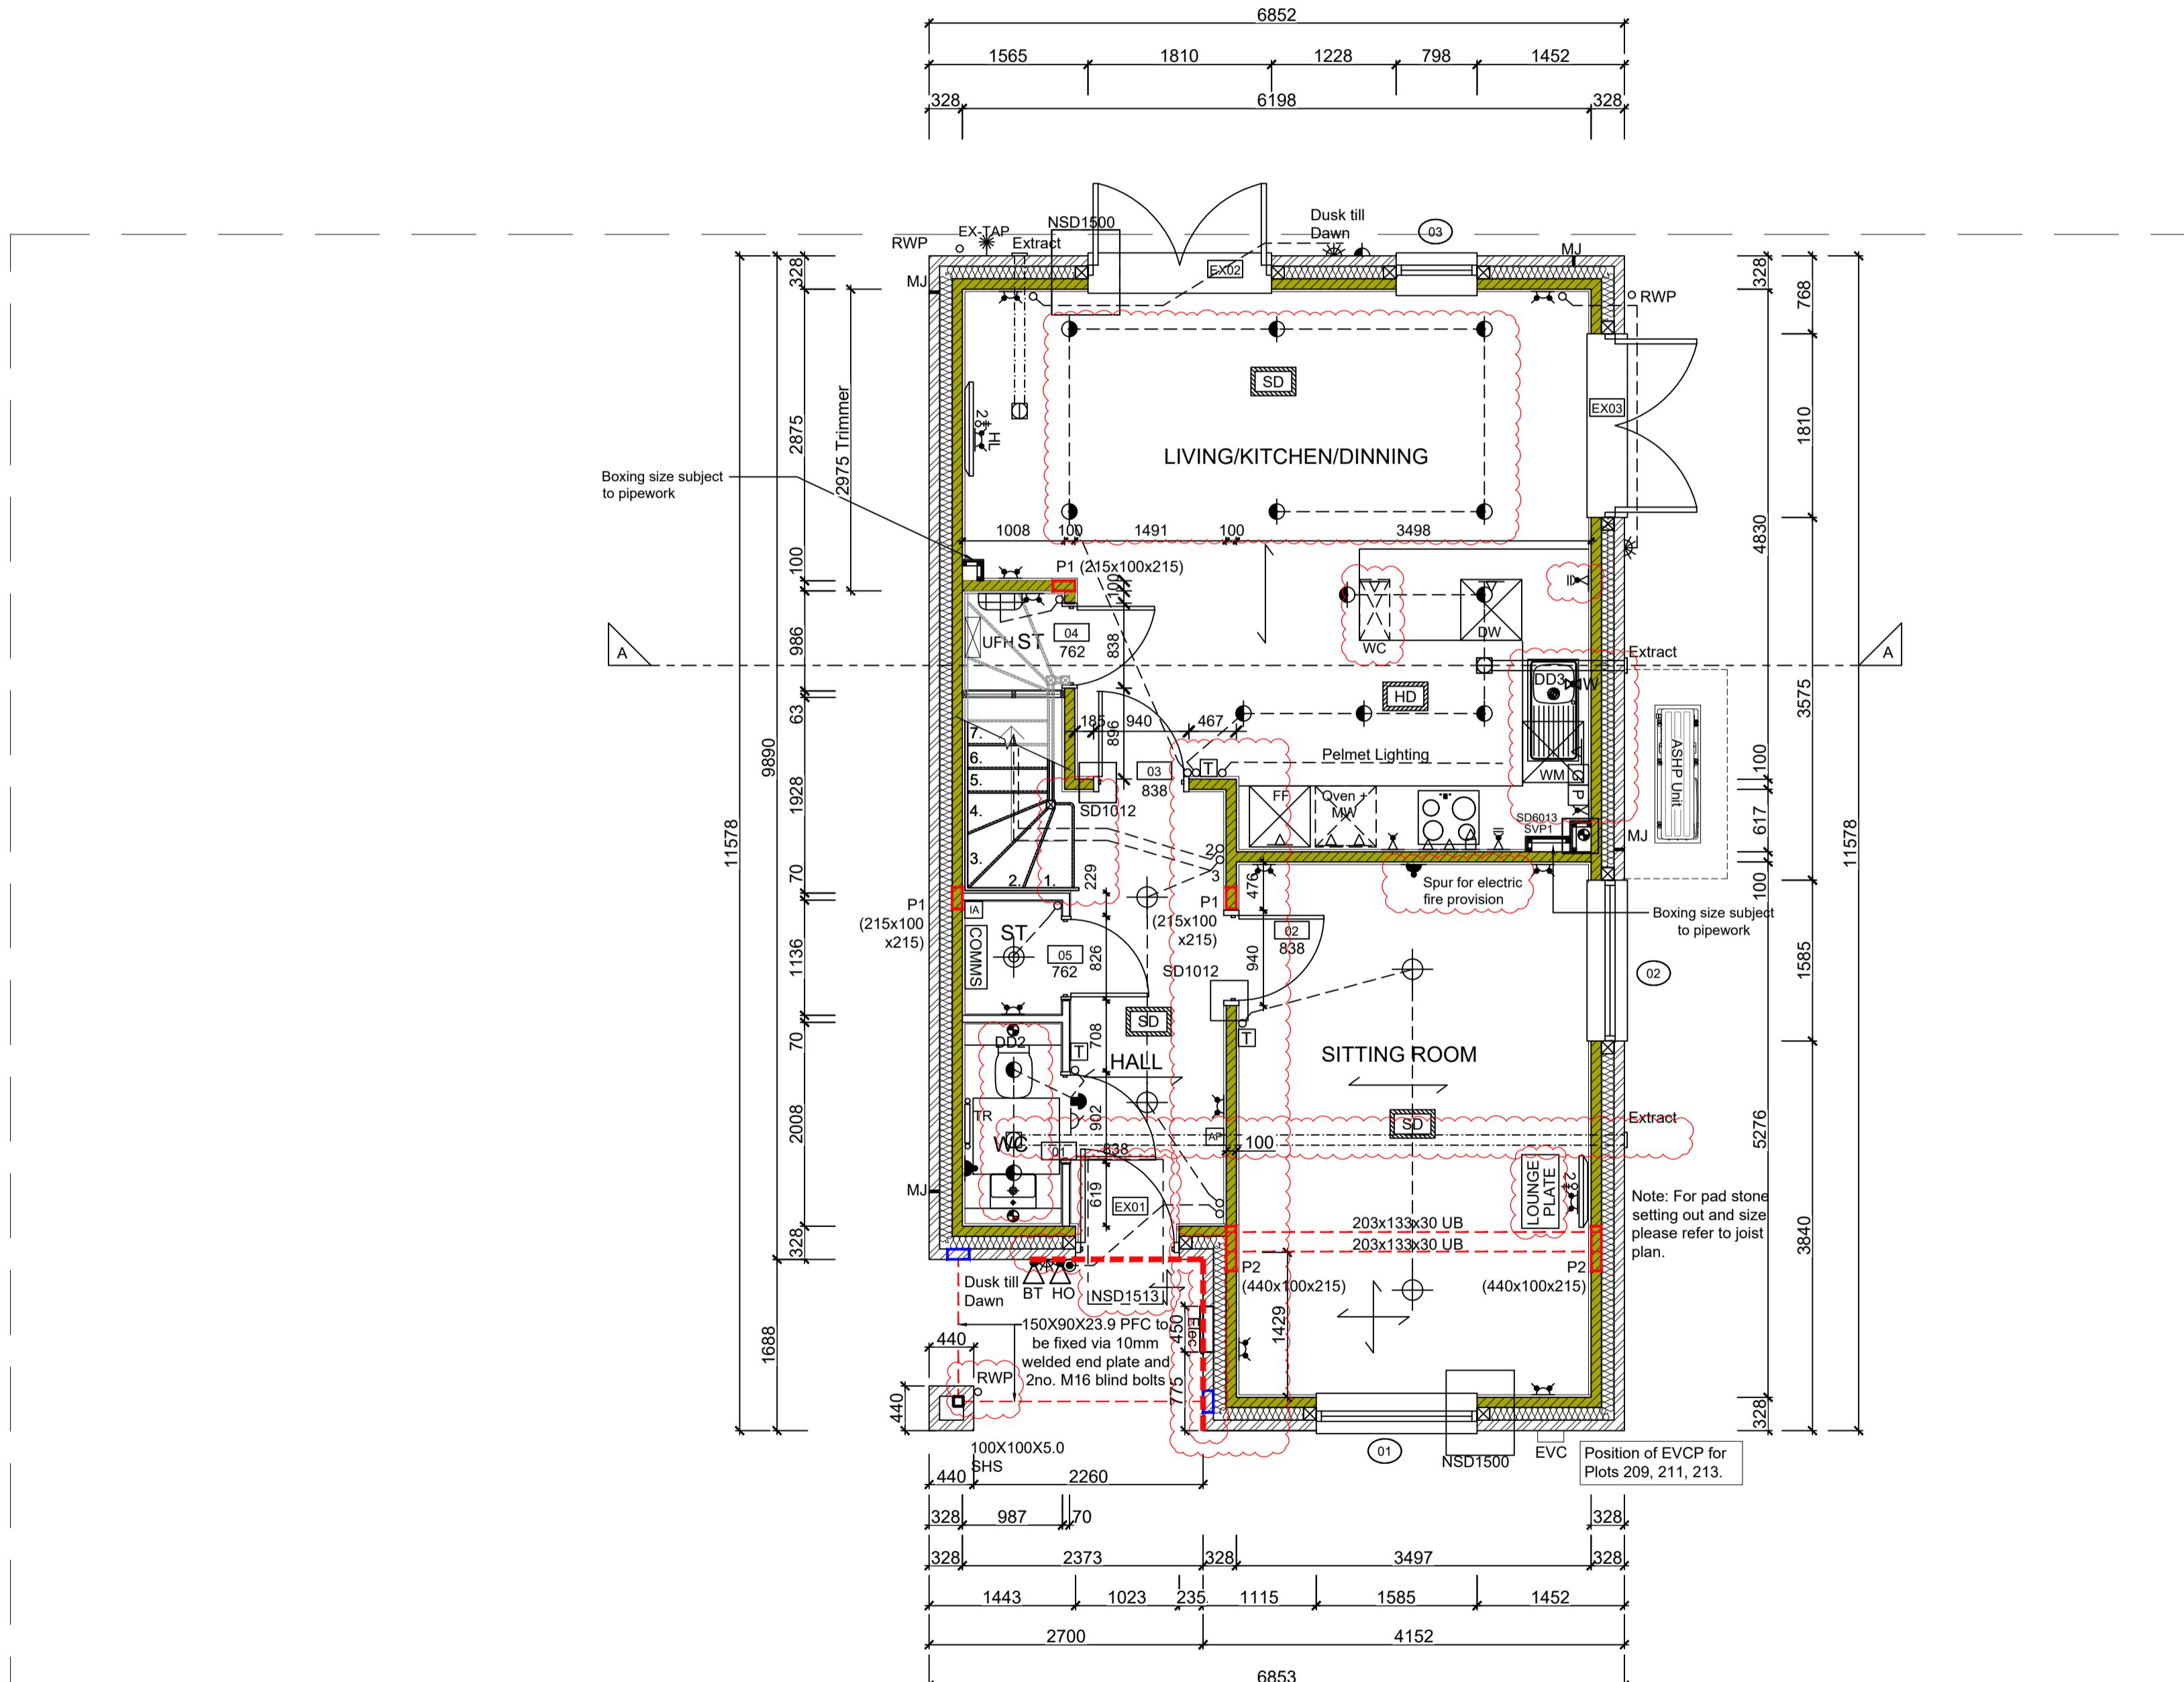
Notes
All dimensions to be checked on site prior to the commencement of construction and any discrepancy should be reported to the Site Manager.

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Sub-Contractors MUST ensure that they have the latest issue drawing before they commence work on site.

This drawing is to be read in conjunction with all relevant Specifications, schedules and Engineers details.



GROUND FLOOR LAYOUT

SCALE 1:50

□ EVC: Position of Electric Vehicle Charge Point

J	11.12.25	Stepped dpc highlighted.	DF
		Grid & Program switch moved, double sockets added.	SK
		Wine cooler relocated. 28.11.25	
		Sink amended to single bowl. DD and water amended	SK
		Sanitary ware amended as per spec, Electrics in Liv	
		Kit/Din amended. Sitting room wall moved. Electrics	
		amended as per. Stair amended to have a curtailed step	
		Dims added/updated. Ref to S1 removed. Lounge	CL
		plate & electric fire spur re-positioned. Store door	
		re-positioned.	
I	20.01.25	Kitchen coordinated with supplier layout, M&E	DF
		coordinated. Sockets coordinated	
H	24.09.24	Wall key amended	ZJ
G	09.08.25	Electric meter location amended. SE Note added	SK
		ASHP added.	
F	01.07.24	RWP location amended as per Clients Comments	SK
		dated 22.05.24.	
		M&E boxing omitted & revised. M&E note added.	
E	19.04.24	Legend revised, details refs added. M &E boxing &	SK
		and info added. rwp added for balcony drainage.	
		Balcony details added. Burglar alarm added.	
Rev	Date	Description	Init.

Job title

Brooklands College Weybridge

Drawing title

House Type HT6

Bilson (Type 2)

Plots: 209, 211, 213

Ground Floor Plan

Scale	1:50 @ A1	Date	May 2023
Rev.	J	Drawn	JM
Dwg No.			