

Refer to Ecology Consultants drawings for the product details of the bat and swift box

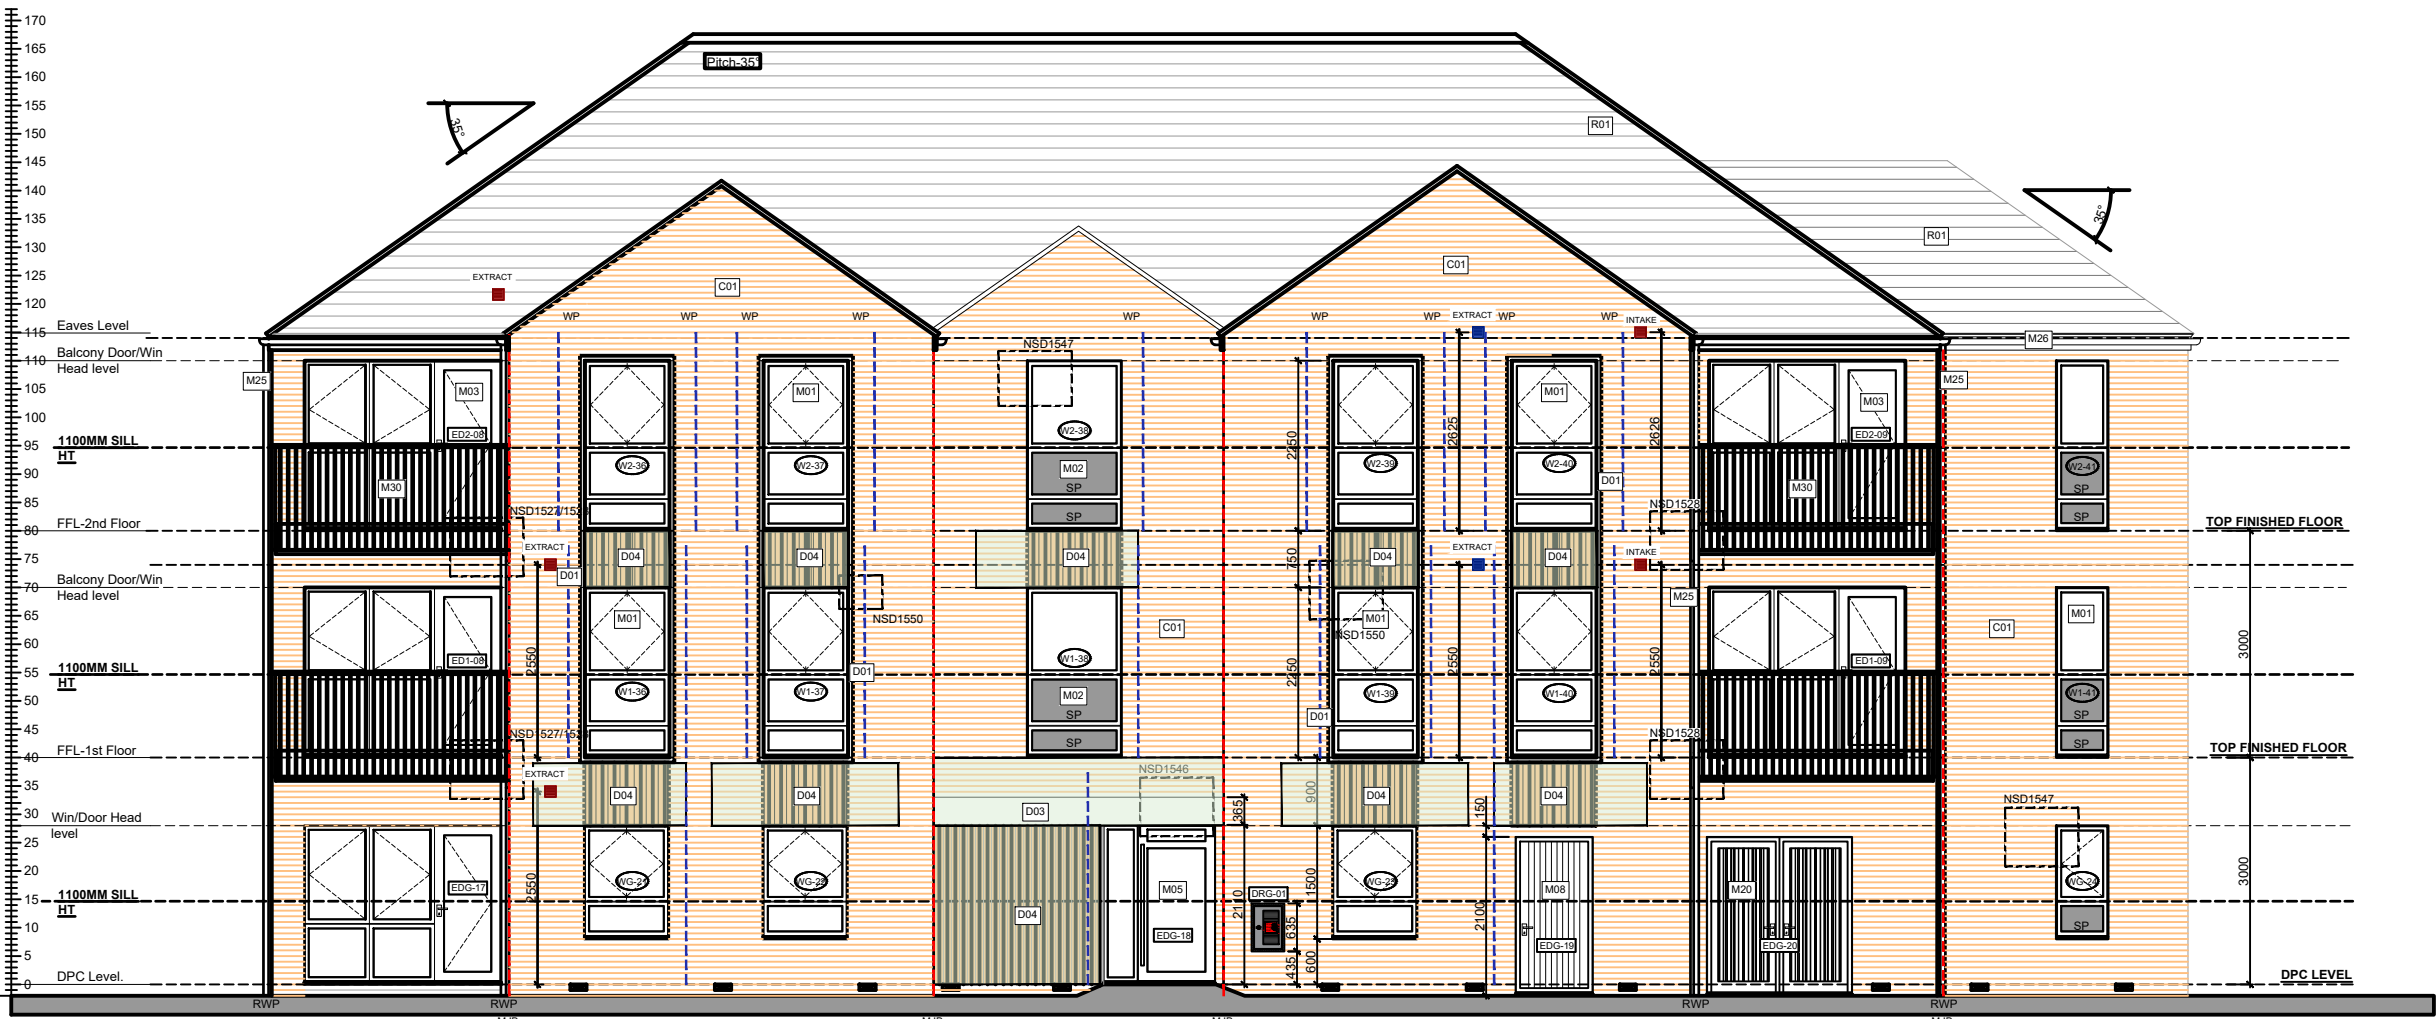
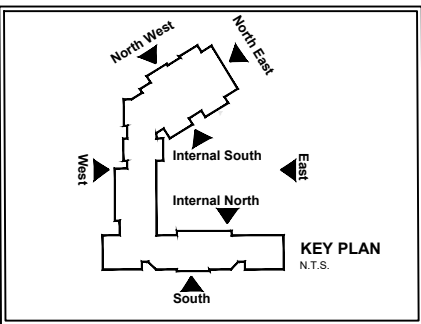
Notes
All dimensions to be checked on site prior to the commencement of construction and any discrepancy should be reported to the Site Manager.

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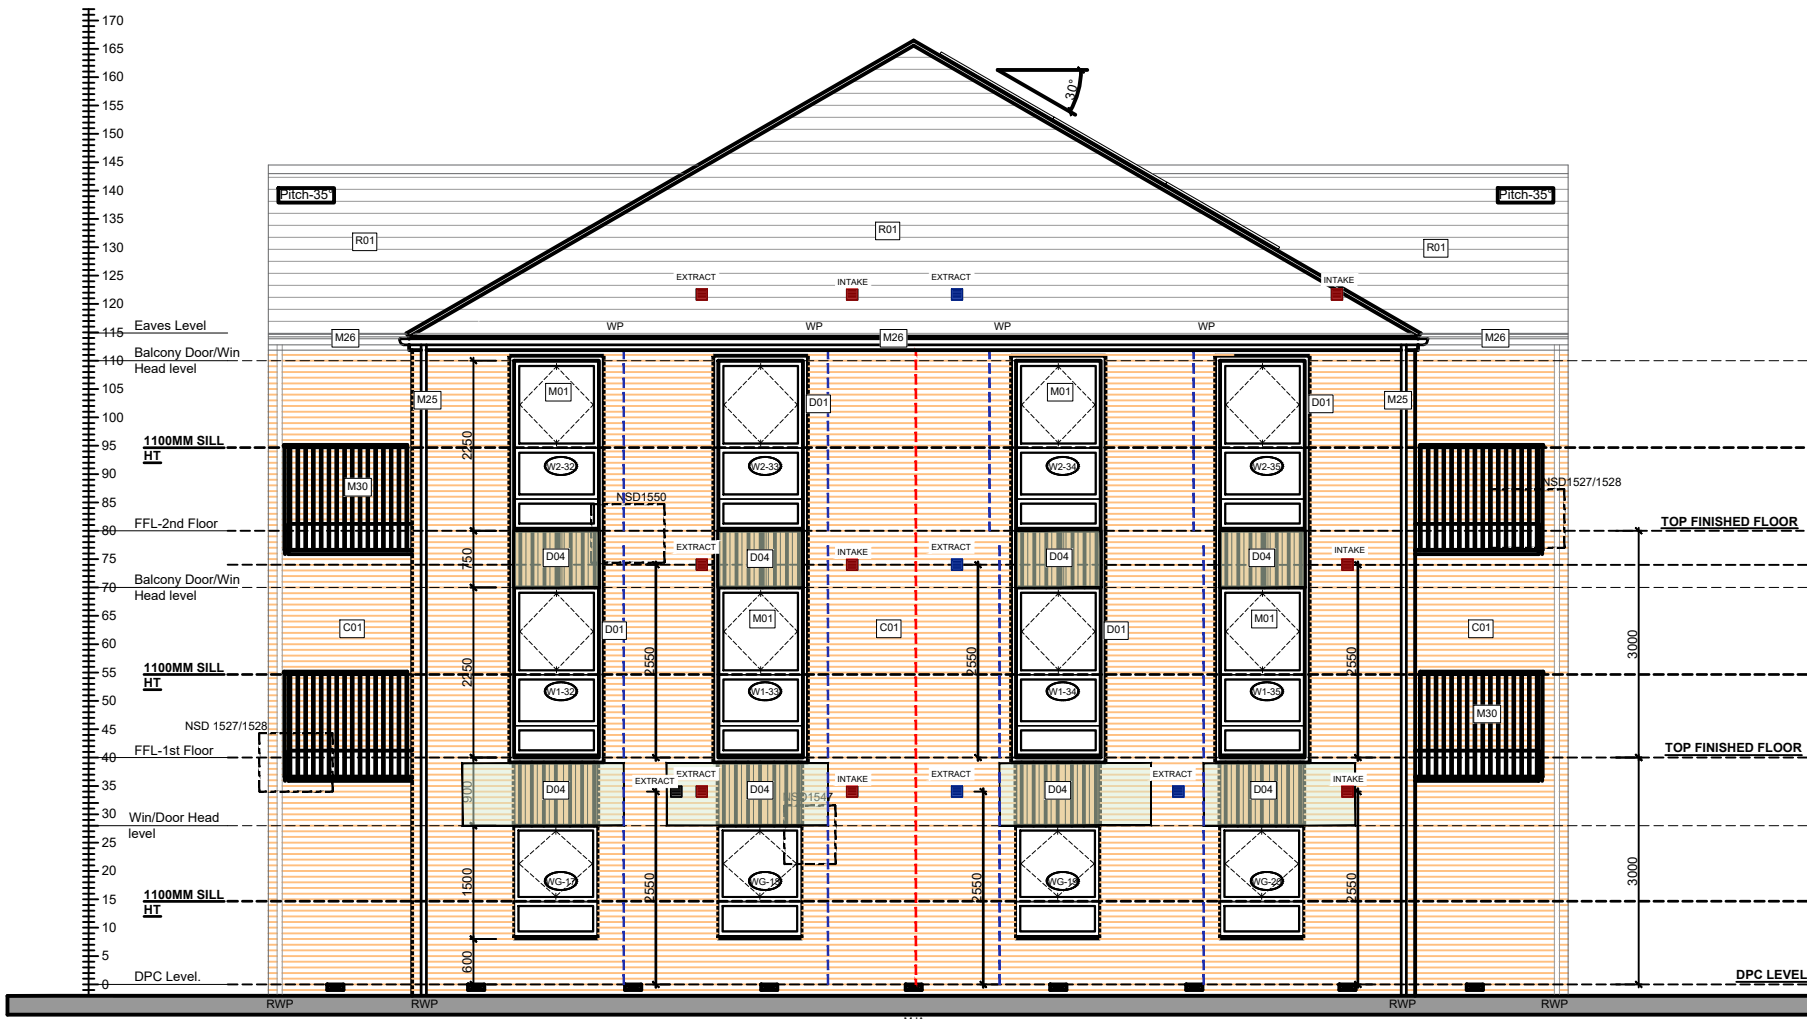
Sub-Contractors MUST ensure that they have the latest issue drawing before they commence work on site.

This drawing is to be read in conjunction with all relevant Specifications, schedules and Engineers details.



North West Elevation

SCALE 1:100
SP: Spandrel Panel



North East Elevation

SCALE 1:100
SP: Spandrel Panel



Internal South Elevation

SCALE 1:100
SP: Spandrel Panel

GENERAL KEY		Window Legend:	
	External Wall light.	#	Egress Window
	Vectaire MEV ventilation extracts	*	Secure By design
	Alpha ASHP intake & extracts	OB	Obscure Galzing
	Bedjoint Reinforcement (SBF35W60) @225mm vertical centres in outer leaf	SGP	Solid Glazed Panel
	Bedjoint Reinforcement (SBF35W60) @150mm vertical centres in outer leaf	BB	Bat box
		SB	Swift box
		Elevation Legend:	
		MJ	Movement Joint
		WP	Windposts

Material Key	
Key	Material
C01	Stock facing brick - Type 1 - orange multi
C03	Stock facing brick - Type 3 - buff yellow
C04	Stock facing brick - Type 4 - dark grey
D01	75mm projecting reconstituted stone surround - off-white
D03	reconstituted stone - off-white
D04	45 degree angled brick detail formed with cut bricks - colour to match facing brick
D05	Stepped brick detail - to match facing brick
D07	Polychromatic brick pattern - contrasting dark grey brick headers in facing brickwork
M01	Window frame - RAL 7015
M02	Double glazed panel with glazed front and solid back - RAL 7015
M03	Glazed balcony door - RAL 7015
M05	Glazed entrance door with sidelight and fanlight - RAL 7015
M08	Ancillary area door - RAL 7015
M19	Louved door - RAL 7015
M25	Rainwater goods - dark grey
M28	Fascia board - RAL 7015
M30	Recessed balcony with metal balustrade and handrail formed with 50mm x 10mm metal flats - RAL 7015
M31	Projecting balcony with metal balustrade and handrail formed with 50mm x 10mm metal flats - RAL 7015
M36	Powder coated aluminium coping with fall to inside - RAL 7015
R01	Slate effect plain tile - grey

N	10.10.25	Updated roof eaves & rainwater gutter to be in accordance with Client instruction dated 29.08.25	DF
		Updated balcony railing as manufacturer drawings.	
		Added bed joint reinforcement as Engineers dwg dated 24.07.25, windposts & extracts updated.	
		Ventilation extracts co-ordinated.	
M	02.06.25	Dry riser inlet added to NW elevation	ZJ
L	22.04.25	Door head & threshold lowered on bin/cycle car park areas	ZJ
K	13.03.25	Extracts coordinated with Alpha & Vectaire drawings	SK
		Solar Panels added.	
J	20.01.25	Brick colour added, additional material tags added	DF
I	07.01.25	Stone surround windows amended	ZJ
H	12.12.24	Windposts added to Legend.	CL
Rev	Date	Description	Init.



Job title
**Brooklands College
Weybridge**

Drawing title
**Block F
Plots: 122 - 153
Elevations
Sheet 2**

Scale 1:100 @ A1 Date Nov 2023

Rev. N Drawn SK

Dwg No.
SA00394-0352-A-FTF-ELE