

Refer to Ecology Consultants drawings for the product details of the bat and swift box


Notes
All dimensions to be checked on site prior to the commencement of construction and any discrepancy should be reported to the Site Manager.

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Sub-Contractors MUST ensure that they have the latest issue drawing before they commence work on site.


This drawing is to be read in conjunction with all relevant Specifications, schedules and Engineers details.



North West Elevation

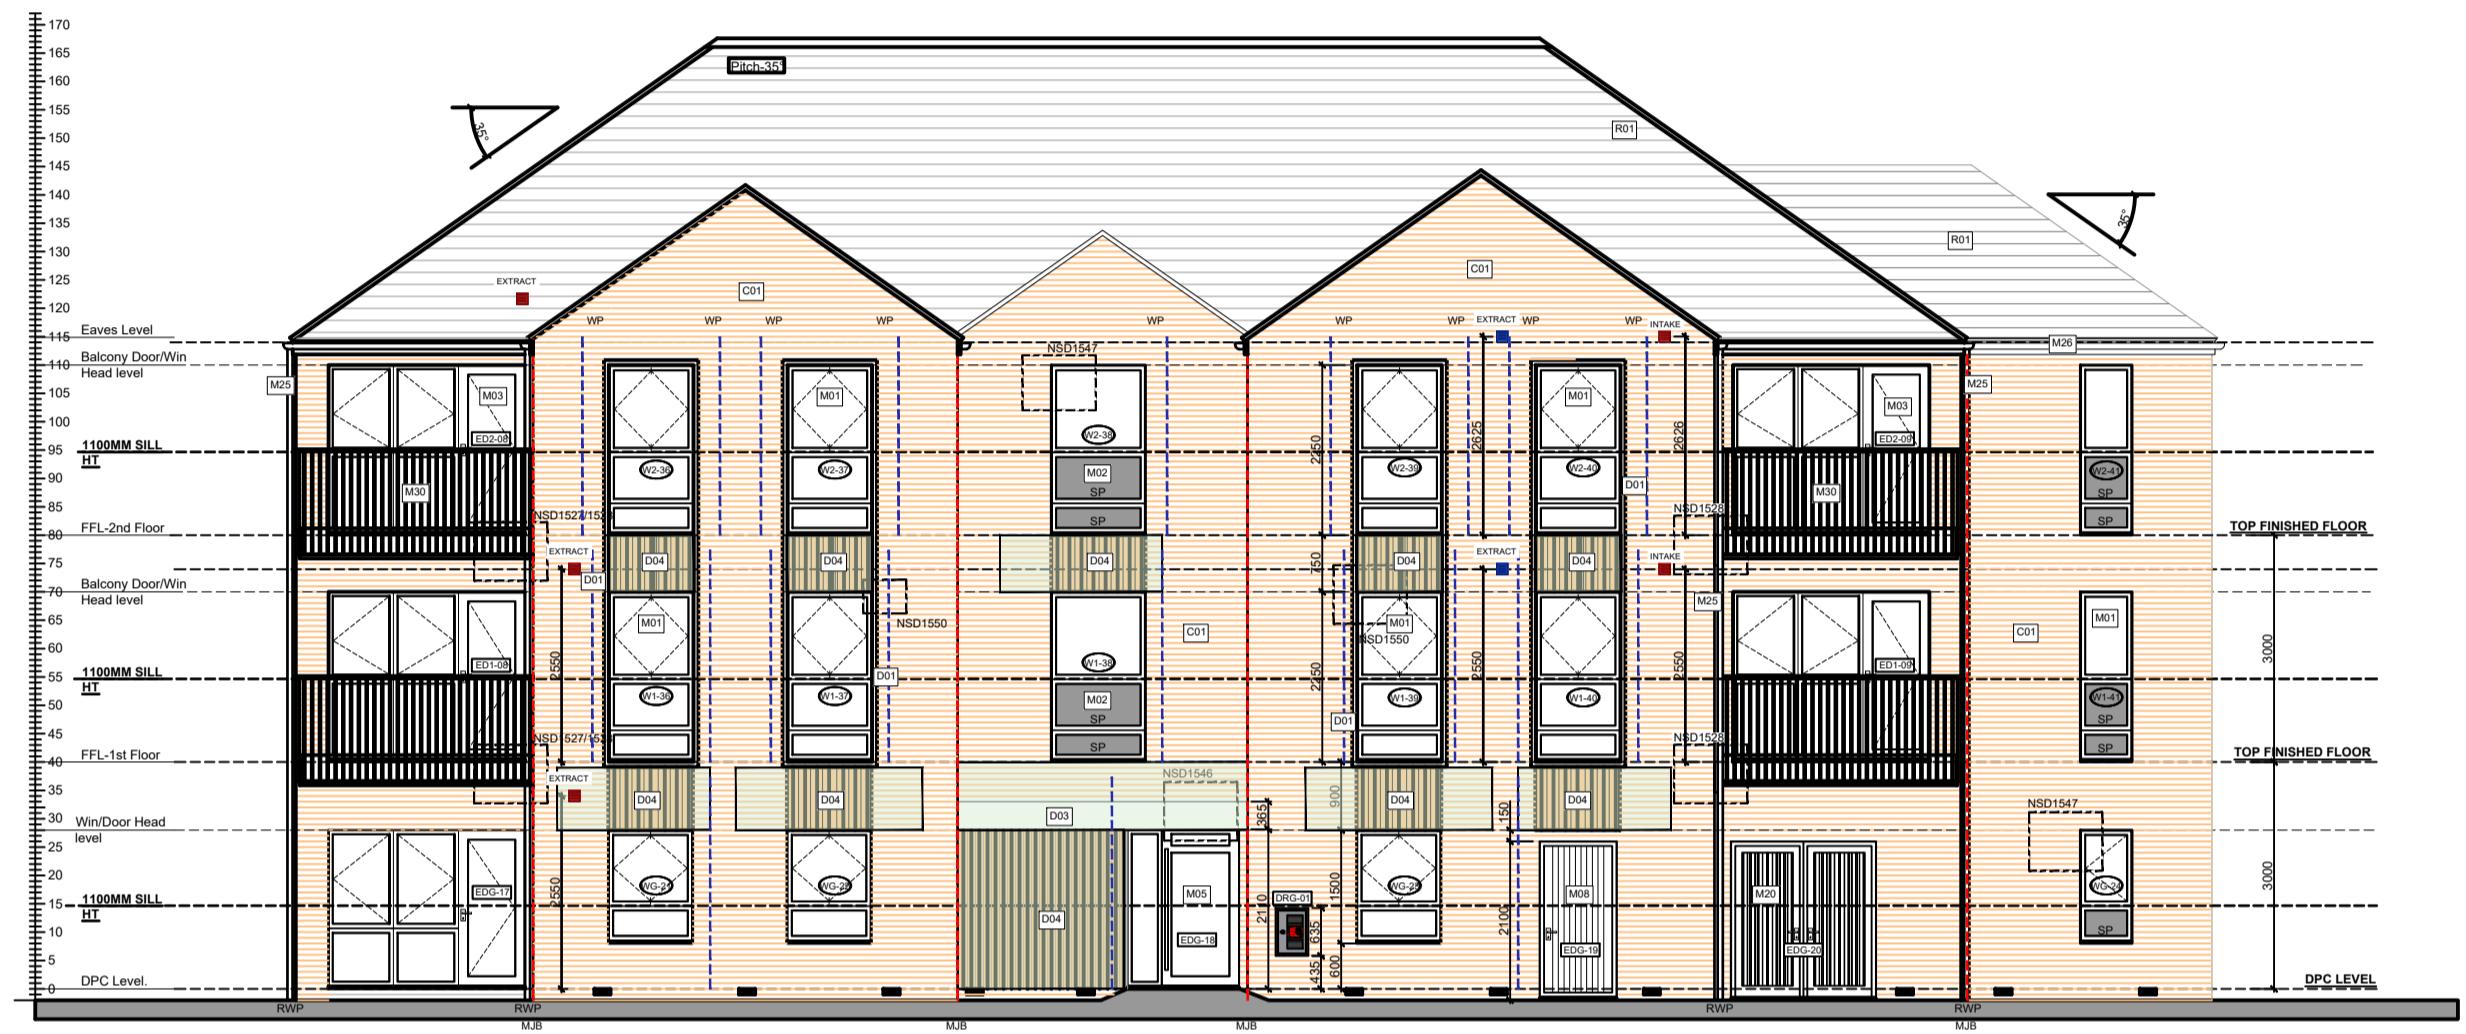SCALE 1:100

SP: Spandrel Panel

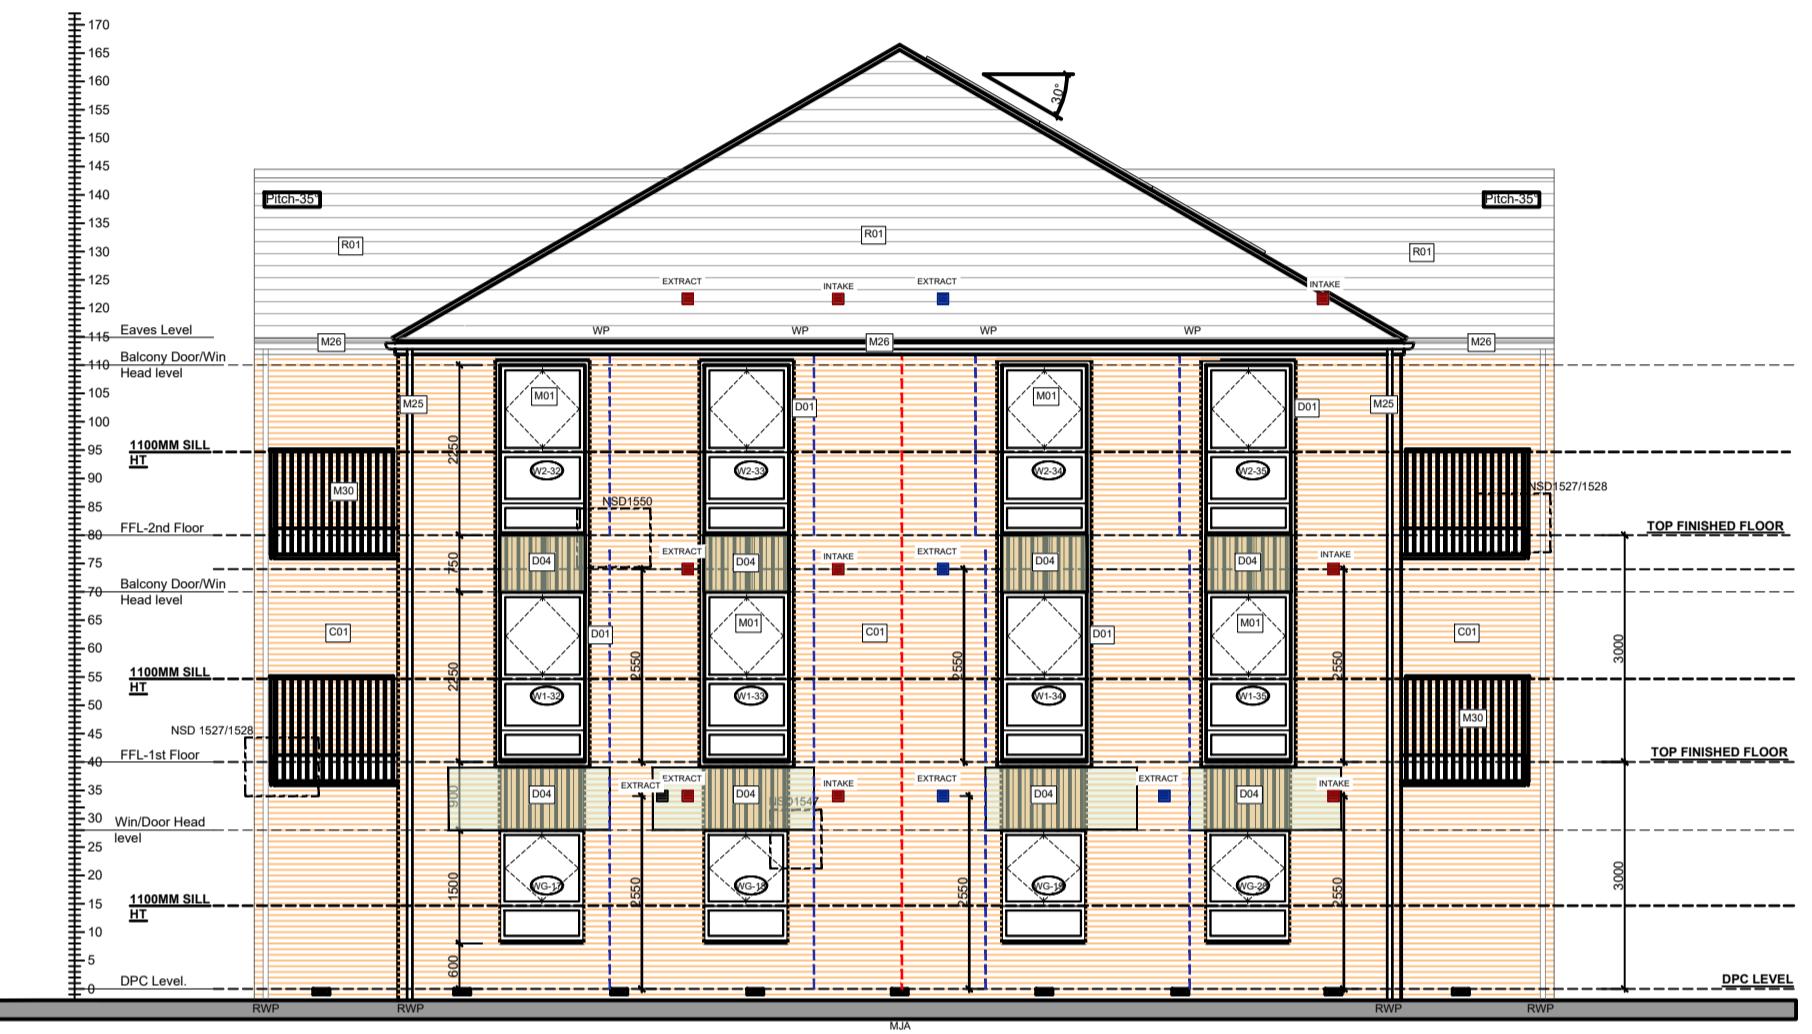

North East Elevation

SCALE 1:100

SP: Spandrel Panel



Internal South Elevation


SCALE 1:100

SP: Spandrel Panel

| GENERAL KEY | |
|--|------------------------|
| External Wall light. | Window Legend: |
| Vectaire MEV ventilation extracts | # Egress Window |
| Alpha ASHP intake & extracts | * Secure By design |
| Bedjoints Reinforcement (SBF35W60) @225mm vertical centres in outer leaf | OB Obscure Galazing |
| Bedjoints Reinforcement (SBF35W60) @150mm vertical centres in outer leaf | SGP Solid Glazed Panel |
| | BB Bat box |
| | SB Swift box |

| Elevation Legend: | |
|-------------------|----------------|
| MJ | Movement Joint |
| WP | Windposts |

| Material Key | |
|--------------|--|
| Key | Material |
| C01 | Stock facing brick - Type 1 - orange multi |
| C03 | Stock facing brick - Type 3 - buff yellow |
| C04 | Stock facing brick - Type 4 - dark grey |
| D01 | 75mm projected reconstituted stone surround - off-white |
| D03 | Recessed stone - off-white |
| D04 | 45 degree angled brick detail formed with cut bricks - colour to match facing brick |
| D05 | Stepped brick detail - to match facing brick |
| D07 | Polychromatic brick pattern - contrasting dark grey brick headers in facing brickwork |
| M01 | Window frame - RAL 7015 |
| M02 | Double glazed panel with glazed front and solid back - RAL 7015 |
| M03 | Glazed balcony door - RAL 7015 |
| M05 | Glazed entrance door with sidelight and fanlight - RAL 7015 |
| M08 | Ancillary area door - RAL 7015 |
| M19 | Louvered door - RAL 7015 |
| M25 | Rainwater goods - dark grey |
| M26 | Fascia board - RAL 7015 |
| M30 | Recessed balcony with metal balustrade and handrail formed with 50mm x 10mm metal flats - RAL 7015 |
| M31 | Projecting balcony with metal balustrade and handrail formed with 50mm x 10mm metal flats - RAL 7015 |
| M36 | Painted coated aluminium coping with fall to inside - RAL 7015 |
| R01 | Slate effect plain tile - grey |

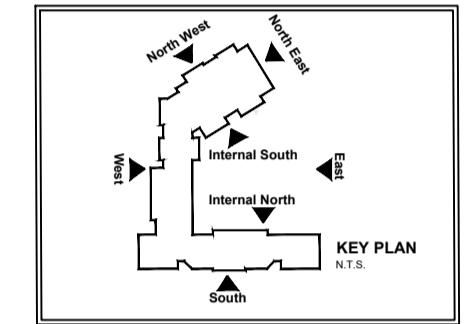

| N | 10.10.25 | Updated roof eaves & rainwater gutter to be in accordance with Client instruction dated 29.08.25 |
|-----|----------|--|
| | | Updated balcony railing as manufacturer drawings. |
| | | Added bed joint reinforcement as Engineers dwg dated 24.07.25, windposts & extracts updated. |
| | | Ventilation extracts co-ordinated. |
| M | 02.06.25 | Dry riser inlet added to NW elevation |
| L | 22.04.25 | Door head & threshold lowered on bin/cycle car park areas |
| K | 13.03.25 | Extracts coordinated with Alpha & Vectaire drawings |
| | | Solar Panels added. |
| J | 20.01.25 | Brick color added, additional material tags added |
| I | 07.01.25 | Stone surround windows amended |
| H | 12.12.24 | Windposts added to Legend. |
| Rev | Date | Description |
| | | Init. |

CALA

Job title
Brooklands College
Weybridge

Drawing title
Block F
Plots: 122 - 153
Elevations
Sheet 2

Scale 1:100 @ A1 Date Nov 2023
Rev. N Drawn SK
Dwg No. SA00394-0352-A-FTF-ELE