


STAIRCASE - GRD-1st
14 equal risers of 205.14mm; Going = 234mm; Pitch 41.82°; Width over strings - 860mm
STAIRCASE - 1st-2nd
13 equal risers of 219.23mm; Going = 234mm; Pitch 41.82°; Width over strings - 860mm


### ROOF VENTILATION (TYPE 1)


An impermeable roofing underlay (Type 1F / HR) is to be draped over all roof pitches, with Rytons OFV1000 (or similar approved) over fascia ventilator providing ventilation equivalent to a continuous 10mm opening at eaves level, and Glidevale Fulmetal Rediroll ventilated dry ridge system (or similar approved) providing ventilation equivalent to a continuous 5mm opening at ridge level.


PADSTONE SCHEDULE				Padstones and steel beam sizes as per SE Drawings  ← Refer to specialist for joist sizes  Refer to M&E Drawings for Underfloor heating details
REF	LENGTH	DEPTH	WIDTH	
P1	215	215	100	
P2	330	215	100	
P3	440	215	100	
P5	215	215	100	


## GENERAL ARRANGEMENT PLANS - WALL LEGEND


 Frost resistant quality facing brickwork 20N Brickwork laid in minimum class iii (M4) mortar.


 Celcon Standard blockwork to inner leaf only. Medium dense blockwork to outer leaf to be laid in minimum class iii (M4) mortar.


 Compressive strength 7.3N/mm<sup>2</sup> to the Ground Floor, minimum class iii (M6) mortar (unless otherwise noted) & 3.5N/mm<sup>2</sup> minimum class iii (M4) mortar (unless noted otherwise noted) to first, second floor roof level.


 Note: All external wall cavities to be 125mm unless otherwise specified.


 70mm British Gypsum Gyproc 70S50 °C stud system, with studs at 600mm centres. 12.5mm Gyproc Soundblock plasterboard each side with tapered edges, finished as per internal spec. Moisture resistant plasterboard to bathroom with studs at 400mm centres.


 70mm Buttersing Wall with 12mm Ply Sheathing as per SD/3032.


 12.5mm Gyproc Soundblock plasterboard each side with tapered edges, finished as per internal spec. Moisture resistant plasterboard to bathroom with studs at 400mm centres.

 63x38mm timber studs @ max 600mm centres, 50mm lower acoustic partition roll (APR 1200) to be installed between studwork for the entire wall panel

 Movement Joints

 MJ

 Denotes the position of the external gyp fibre Soc.





 Dashed line indicates extent of secondary DPC stepped up to accommodate level threshold to front door.

**IMPORTANT NOTE:**

ALL EXTERNAL WALLS TO INCORPORATE BRICKFORCE SBF30W60 BED-JOINT REINFORCEMENT TO INNER LEAF OF BLOCKWORK 2x COURSES ABOVE & BELOW ALL OPENINGS & TO PROJECT A MIN. 600mm BEYOND OPENING.

## ELECTRICAL KEY










This electrical legend is to be read in conjunction with the internal specification & M&E consultants details if applicable with any discrepancies being reported to the site manager. Doorbells, light switches, entryphones, etc. should be fixed no higher than 1200mm above FFL. TV, BT & power sockets should be fixed no lower than 450mm above FFL. All wall lights to be fitted at 2100mm above FFL.









Symbol	Description
	Flush double switch socket.
	Flush double switch socket with 2 USB points.
	External socket.
	13A flush unswitched spur.


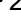







Where switches are located all in the same wall, use 2/3/4 gang switches.




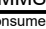







Hot water cylinder located in  
Bedroom 01. M&E & client to confirm

Refer to OPOWA Drawings  
for Plot specific PV Locations





Symbol	Description
	Flush double switched socket 200mm above kitchen work top with 2 USB points
	Flush rocker light switch. 1.2 or 3 way switched.
	Ceiling rose light point.
	LED light fitting.
	Under-stair oval bulkhead wall mounted light.
	External Wall light.
	Batten holder light fitting.
	Door bell push.
	Door bell sounder.

Symbol	Description
	Flush double switched socket 200mm above kitchen work top.
	13A Flush unswitched outlet 300mm below kitchen work top.
	Flush 30A cooker switch 200mm above kitchen work top.
	Gas point.
	Shower head & control position.
	Ceiling mounted extract fan.
	Isolator switch.
	Shaver socket.

Symbol	Description
 2	Dual TV/ FM point 1xCT100 cabling (diplexer)
	Single slave phone socket 1xCAT 6 cabling.
	RJ45 data point
	HDMI port (4 & 5 beds only)
	Immersion heater switch, located in AC.
	Rad/Rail.
	Heating control programming switch.
	Grid switch.
	Thermostat.

Symbol	Description
	Carbon Monoxide Detector.
	Smoke Detector.
	Heat Detector.
	For sites with FFTP refer to SD/1002. For sites with FTTC refer to SD/1003.
	For full lounge plate specification refer to CALA Group Internal Specification.
	Intruder Alarm unit to Nacoss Standard
	Alarm Panel
VIRGIN	For sites where virgin is to be provided, Virgin Media blanking plates are to be provided adjacent to the low level Lounge Plate in the lounge, and next to the TV/MTF socket within the Family Room and Master Bedroom.
	External wall mounted Electric Meter
	British Telecom Point
	Hyper Optic Point
	Underfloor Heating Manifold

## LOFT SPACE ELEC KEY

Symbol	Description
	Batten holder light fitting.
	Flush double switch socket.
	Smoke Detector within loft space.
	Switch with Neon indicator



Notes	All dimensions to be checked on site prior to the commencement of construction and any discrepancy should be reported to the Site Manager.
-------	--

This drawing may not be reproduced in any part or form without written consent.

All copyrights reserved.

Sub-Contractors MUST ensure that they have the latest issue drawing before they commence work on site.


<p>This drawing is to be read in conjunction with all relevant Specifications, schedules and Engineers details.</p>	
<p><input type="checkbox"/> EVC - Indicative position of EVCP. If remote, see external works drawing for position</p>	

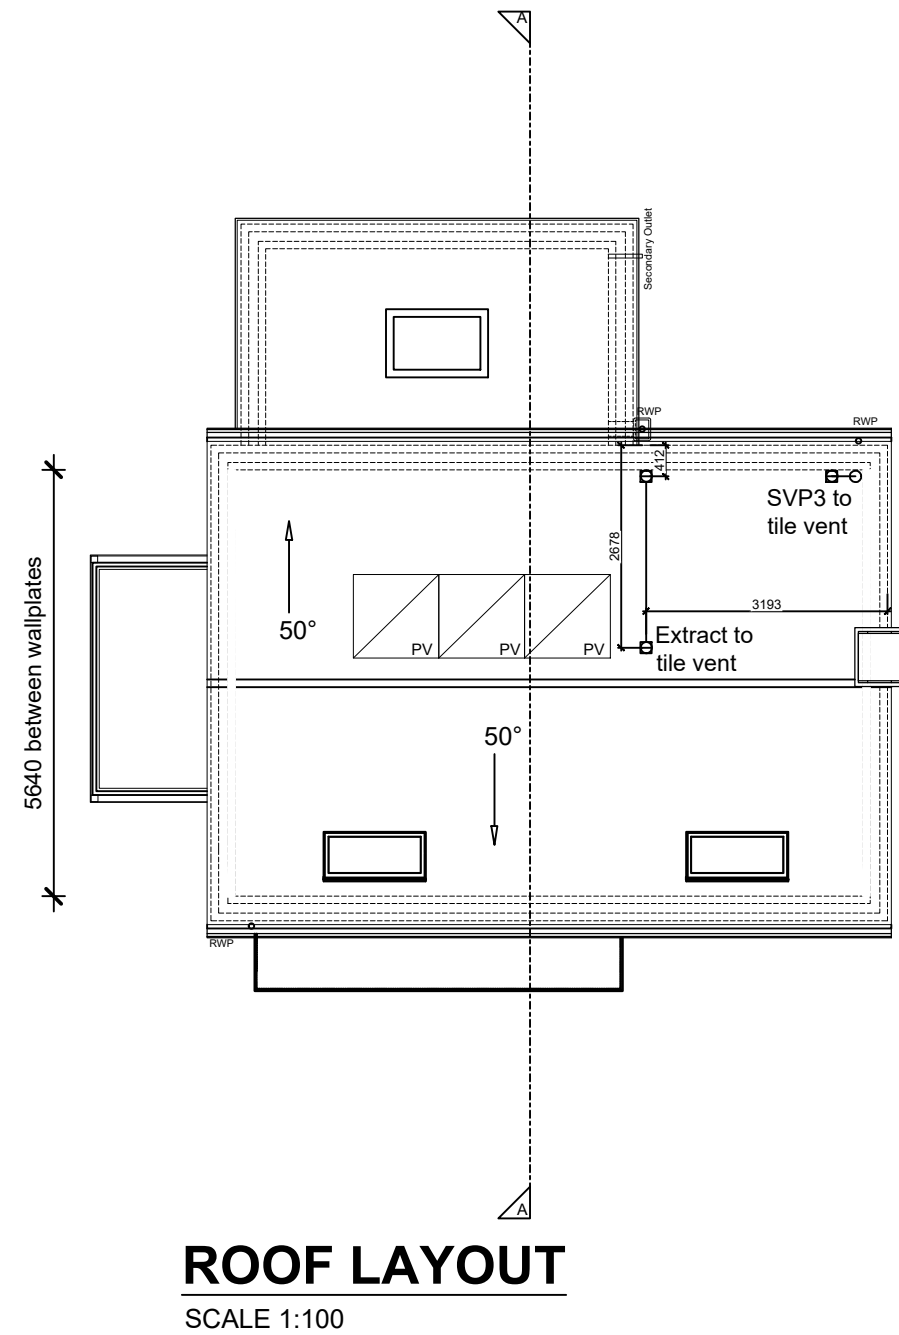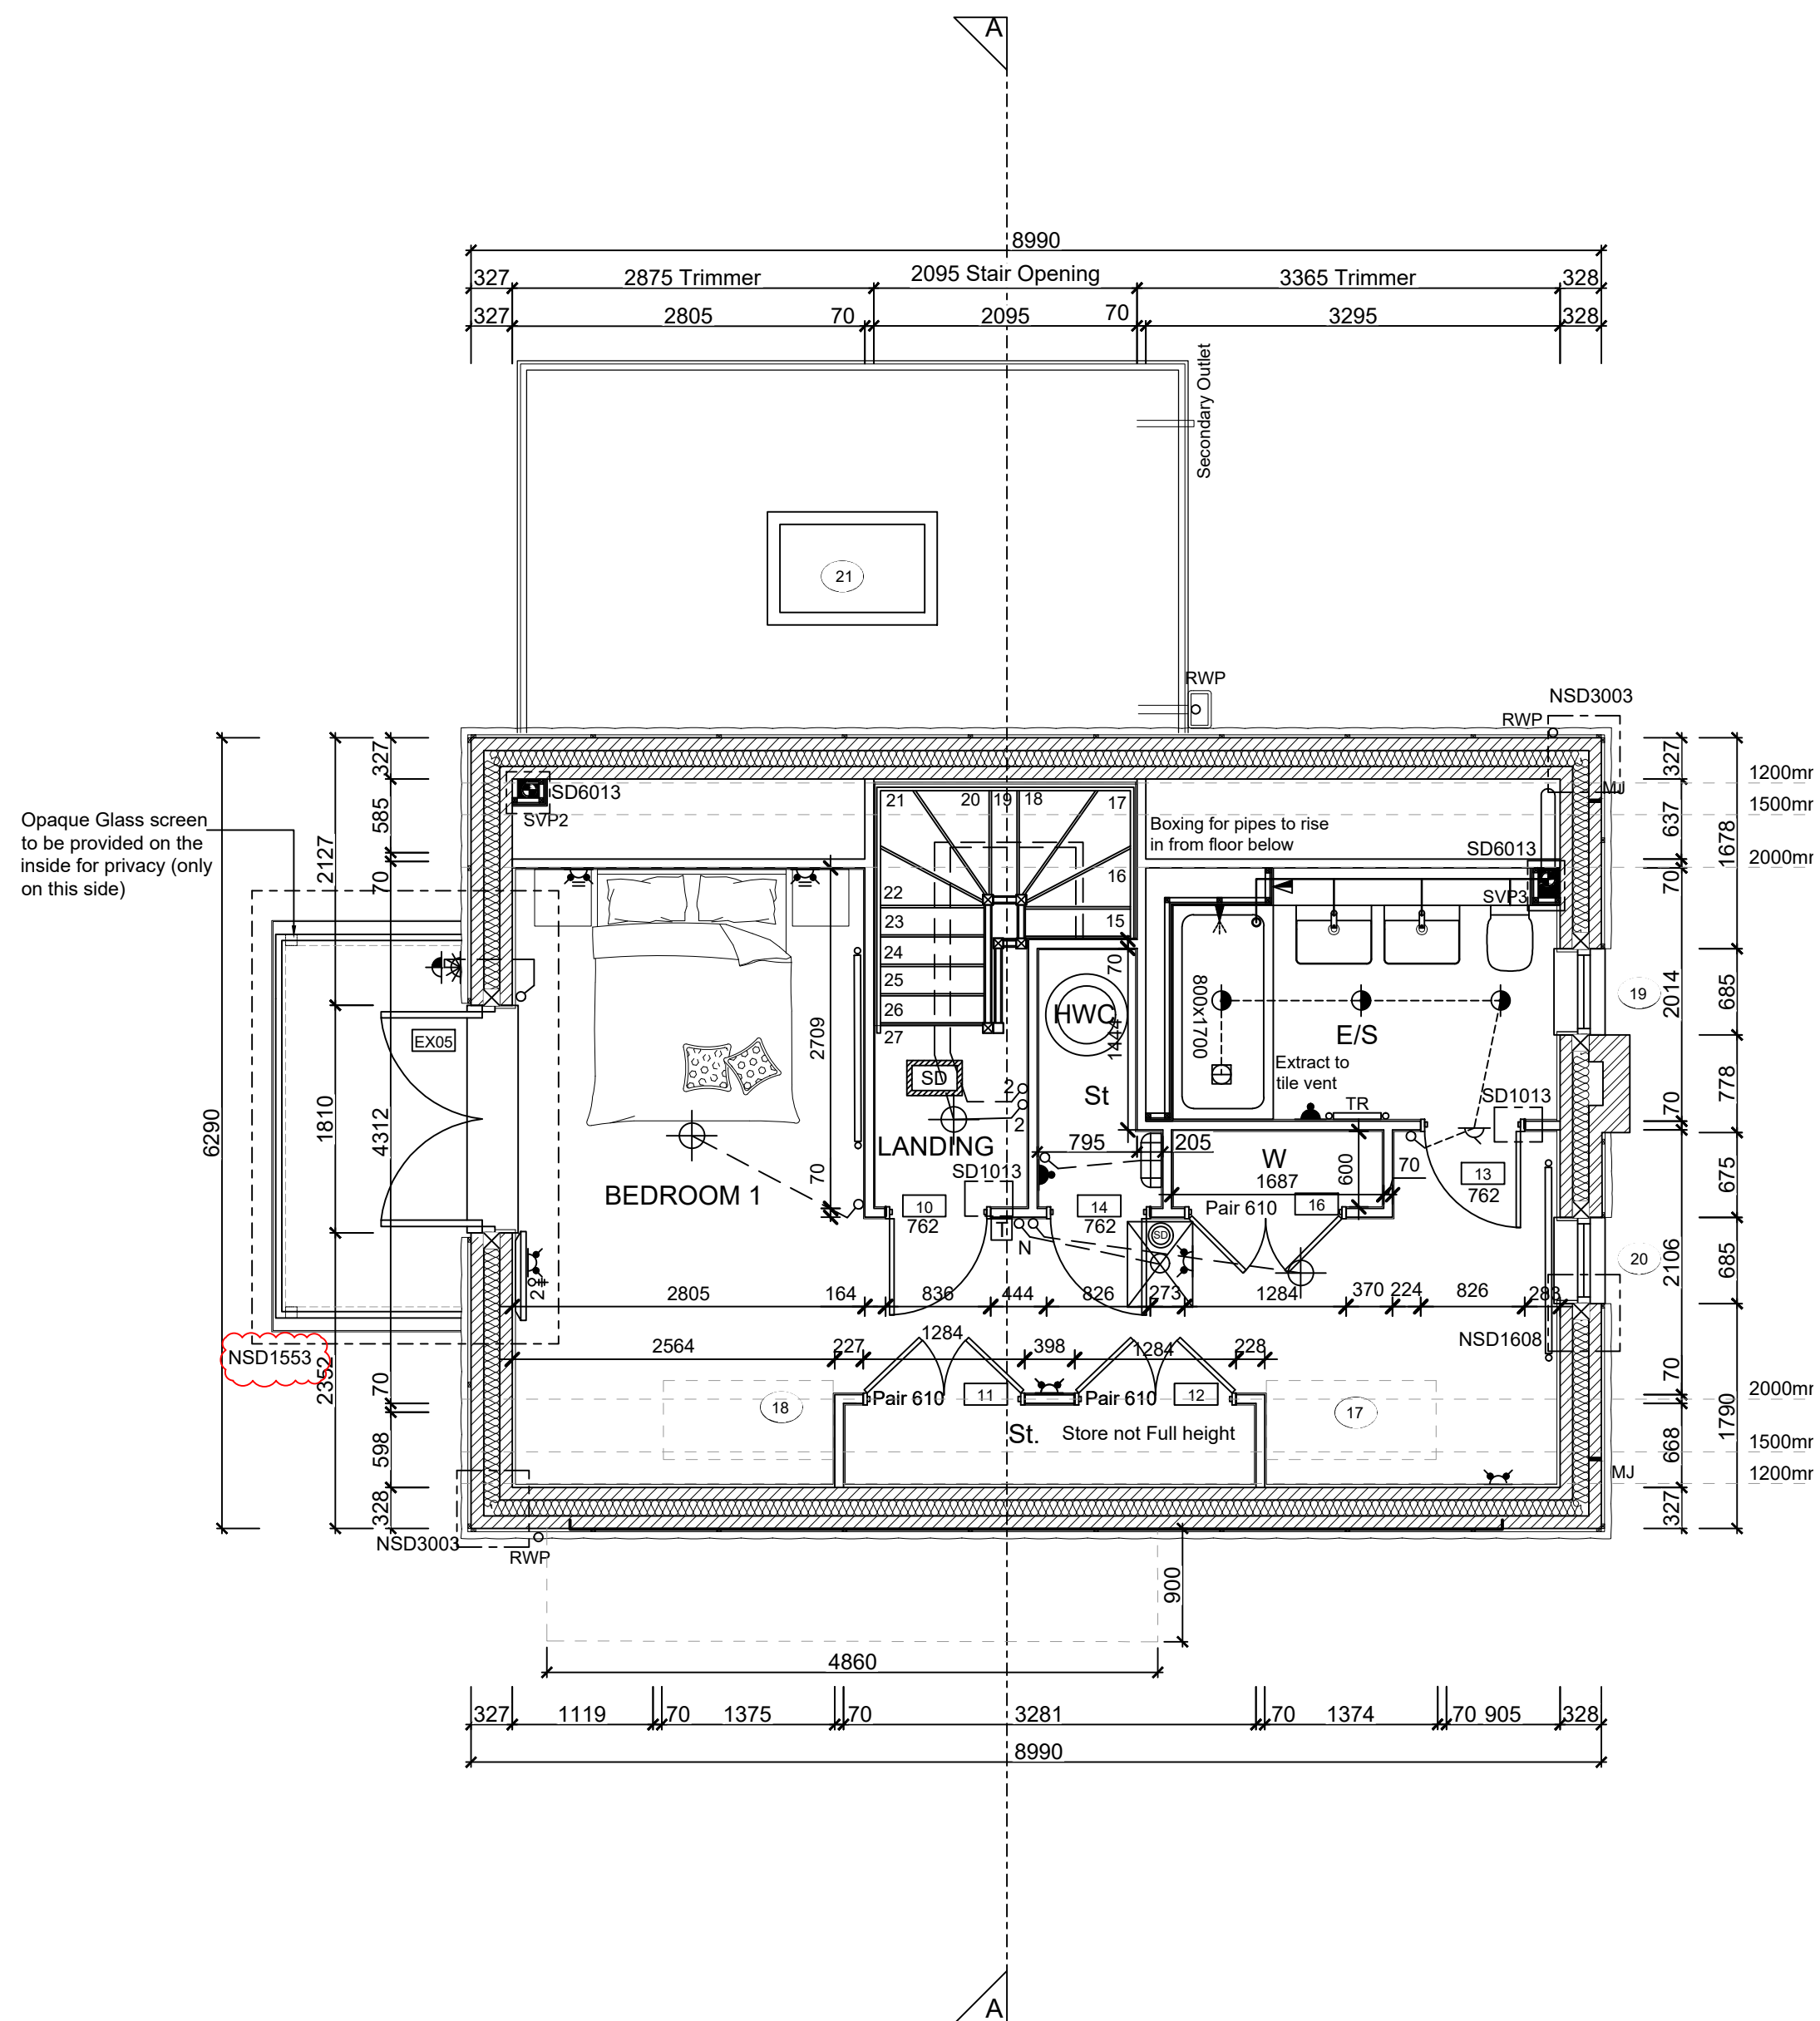

## SECOND FLOOR LAYOUT

SCALE 1:50

S	15.12.25	Updated balcony floor structure / detail ref.	DF
R	08.06.25	Loft hatch coordinated	ZJ
Q	12.08.25	Basin updated as per spec; Boxing removed	SK
P	15.04.25	Structural opening amended to door 10	SK
O	05.02.25	Double doors added to W/drooms. Drims amended	SK
N	24.01.25	P/V's added to roof plan. Loft hatch legend added. SD added to loft hatch	SK
M	10.01.25	Increase Ensuite shower tray, M&E coordinated	DF
L	15.10.24	Detail Ref tags co-ordinated.	SK
K	13.03.24	Wardrobe added to Bed 1	ZJ
J	24.09.24	Wall key amended	ZJ
I	16.09.24	Note amended, chimney width amended	ZJ
H	09.08.24	En-suite shower moved forward to accommodate boxing for ASHP pipes. Door moved. Drims revised	SK
G	24.07.24	RWP location amended. SE Note added. Velux position revised. Internal arrangement revised.	SK
F	28.06.24	M&E note added.	SK
E	24.06.24	Door Leaf Size changed to 762mm.	SK
D	19.04.24	Legend revised, New details refs added.	YS
		Privacy screen note added.	
Rev	Date	Description	Init.

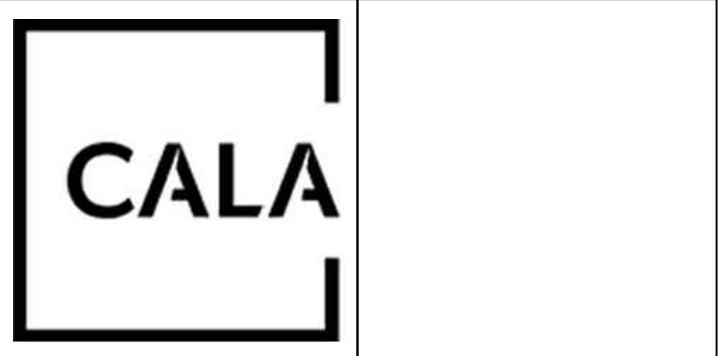

Job title

Brooklands College  
Weybridge

Drawing title

House Type HT9

Everglade (Type 3)

Plots: 189

Second Floor Plan & Roof Plan

Scale 1:50 @ A1	Date Oct 2023
Rev. S	Drawn SK

Dwg No.  
SA00394-0613-A-HT9-GA