
### SUBSTRUCTURE MASONRY STRENGTH LEGEND All Substructure Blockwork to be 7.3N/mm2 Aircrete Blocks, JetFloor Infill blocks to be 3.5N/mm2 Where infill blocks to beam and block floor are built into adjacent walls, the infill block is to be the same strength and density as the wall blockwork. SUBSTRUCTURE LEGEND ⊕DD1 Direct Drain Connection (No.1). Centre line of drainage outlets to be positioned 75mm from structural Wall ⊕SVP1 Soil Vent Pipe (No.1). Telescopic Air Vents to ventilate sub floor void, to be positioned at max. 2m c/c. AIR BRICKS NOT TO BE POSITIONED BELOW DOOR THRESHOLD (Door Position Indicated By Dashed Lines). DOOR THRESHOLD Thick dashed line denotes ACO 'HEX Drain Brickslot' hidden drainage channel across width of door opening Refer to Engineers and Architects details. Thin dashed line indicates extent of secondary DPC stepped up to accommodate level threshold where required. Secondary DPC to be installed to perimeter of building as per detail 00256-304-NETHERHALL

**Ensure 60mm continuous cavity to substructure** 

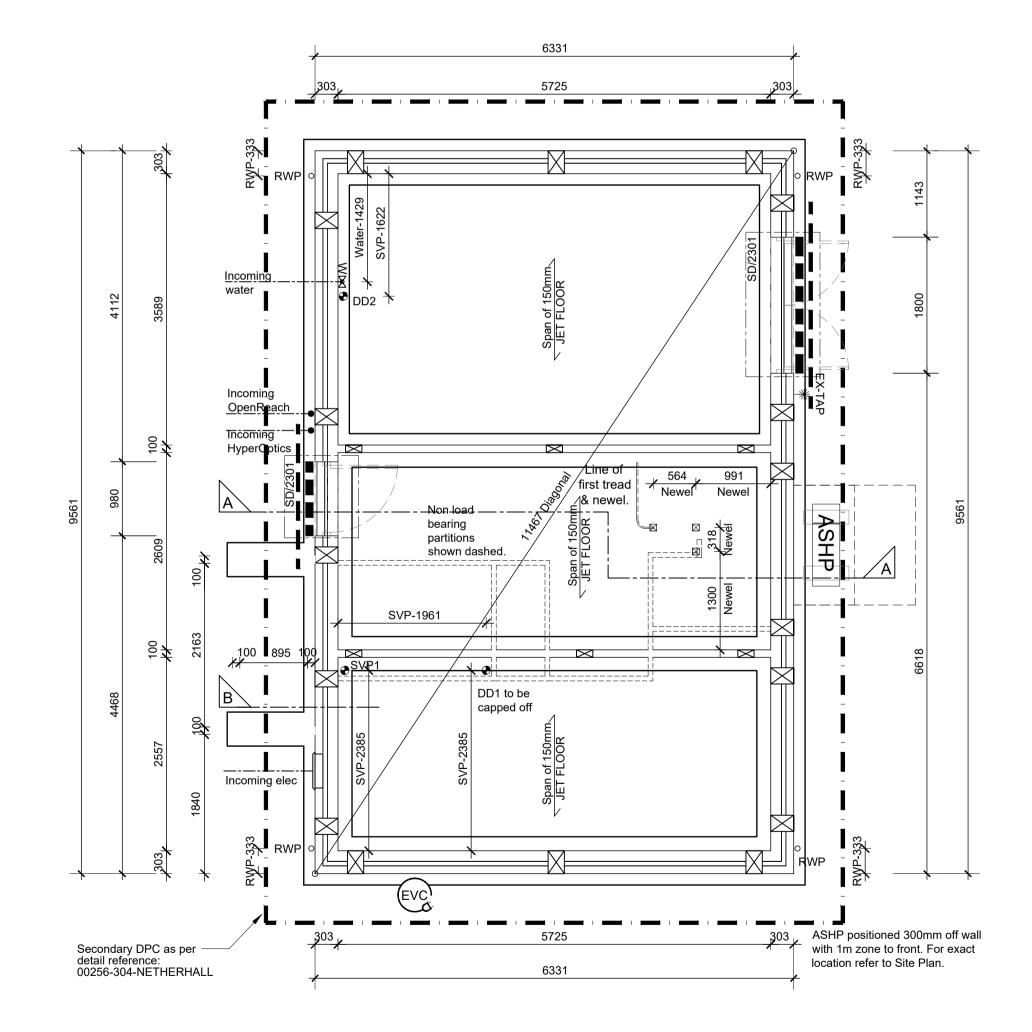

# Extract to tile vent SVP to tile vent Oriel window to detail reference: 00256-301-NETHERHALL RWP STATES between Head Binders Gable panel to be used SD/5105 RWP Extract to tile vent Oriel April 2007 Oriel Window to detail reference: 00256-301-NETHERHALL RWP RWP RWP

## SUBSTRUCTURE LAYOUT

SCALE 1:50

ROOF LAYOUT
SCALE 1:50

# ROOF VENTILATION (Type 2)

An impermeable roofing underlay (Type 1F / HR) is to be draped over all roof pitches, with Rytons OFV300 (or similar approved) over fascia ventilator providing ventilation equivalent to a continuous 25mm opening at eaves level, and Glidevale Fulmetal Rediroll ventilated dry ridge system (or similar approved) providing ventilation equivalent to a continuous 5mm opening at ridge level.

### NOTES:

All dimensions to be checked on site prior to the commencement of construction and any discrepancy should be reported to the Site Manager.

This drawing may not be reproduced in any part

All copyrights reserved.


or form without written consent.

Sub-Contractors MUST ensure that they have the latest issue drawing before they commence work on site.

This drawing is to be read in conjunction with all relevant Specifications, schedules and Engineers details.

# SPECIFICATION C

PRIVATE

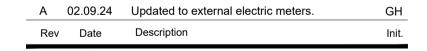



Netherhall Gardens

DRAWING TITLE

HT 3.2b

Plots 136

Substructure & Roof Plan Layout

**Timber Frame Construction** 

ALE DATE DRAWN
1:50 @ A1 Nov 2023 GF

00256-100-NETHERHALL