INTERMITTENT EXTRACT VENTILATION: Kitchen = 30L/S Adjacent hob; Utility = 30L/S; Bathroom = 15L/S; En-Suites = 15L/S; Clk's = 6L/S

PURGE VENTILATION: All windows to habitable rooms to open more than 30 deg's. each habitable room to be provided with an openable window(s) with an opening area equal to 1/20th of the rooms floor area.

STAIRCASE - GRD-1st

14 equal risers of 205.14mm; Going = 234mm; Pitch 41.82°; Width over strings - 860mm

STAIRCASE - 1st-2nd

13 equal risers of 206.30mm; Going = 234mm; Pitch 41.82°; Width over strings - 860mm

ROOF VENTILATION (TYPE 1)

An impermeable roofing underlay (Type 1F / HR) is to be draped over all roof pitches, with Rytons OFV1000 (or similar approved) over fascia ventilator providing ventilation equivalent to a continuous 10mm opening at eaves level, and Glidevale Fulmetal Rediroll ventilated dry ridge system (or similar approved) providing ventilation equivalent to a continuous 5mm opening at ridge level.

| PAI | OSTONE SC | HEDUL | | Padstones and steel beam sizes a | | | |
|-----|-----------|-------|-----|----------------------------------|--|--|--|
| REF | LENGTH | DEPTH | l . | per SE Drawings | | | |
| P1 | 215 | 215 | 100 | ∠——>Refer to specialist for | | | |
| P2 | 440 | 215 | 100 | joist sizes | | | |
| P3 | 600 | 215 | 100 | | | | |

GENERAL ARRANGEMENT PLANS - WALL LEGEND Frost resistant quality facing brickwork 20N Brickwork laid in minimum class iii (M4) mortar. Celcon Standard blockwork to inner leaf only. Medium dense blockwork to outer leaf to be laid in minimum class iii (M4) mortar. Compressive strength 7.3N/mm² to the Ground Floor, minimum class iii (M6) mortar (unless otherwise noted) & 3.5N/mm² minimum class iii (M4) mortar (unless noted otherwise noted) to first, second floor& roof level. Note: All external wall cavities to be 125mm unless otherwise specified. 70mm British Gypsum Gypframe 70S50 'C' stud system, with studs at 600mm centres. 12.5mm Gyproc Soundbloc plasterboard each side with tapered edges, finished as per internal spec. Moisture-resistant plasterboard to bathroom with studs at 400mm centres. 70mm Buttressing Wall with 12mm Ply Sheathing as per SD/3022. 12.5mm Gyproc Soundbloc plasterboard each side with tapered edges, finished as per internal

Movement Joints Denotes the position of the external cavity fire Soc.

63x38mm timber studs @ max 600mm centres. 50mm Isover acoustic partition roll (APR 1200)to

spec. Moisture-resistant plasterboard to bathroom with studs at 400mm centres.

IMPORTANT NOTE:

ALL EXTERNAL WALLS TO INCORPORATE BRICKFORCE SBF30W60 BED-JOINT


REINFORCEMENT TO INNER LEAF OF BLOCKWORK 2x COURSES ABOVE & BELOW ALL

OPENINGS & TO PROJECT A MIN. 600mm BEYOND OPENING.

be installed between studwork for the entire wall panel

| | | ELECTRICAL KEY | | Description | Symbol | Description | Symbol | Description | Symbol | Description |
|------|--|---|----------|---|----------|--|------------|---|-----------------------|---|
| 1 | | ical legend is to be read in conjunction with the ecification & M&E consultants details if applicable | <u> </u> | Flush double switched socket 200mm above kitchen work top with 2 USB points | | Flush double switched socket 200mm above kitchen work top. | 0 2 | Dual TV/ FM point 1xCT100 cabling (diplexer). | СМ | Carbon Monoxide Detector. |
| | with any di | rith any discrepancies being reported to the site manager. oorbells, light switches, entryphones, etc. should be fixed | | Flush rocker light switch. 1,2 or 3 way switched. | | 13A Flush unswitched outlet 300mm below | 土 | Single slave phone socket 1xCAT 6 cabling. | SD | Smoke Detector. |
| | no higher than 1200mm above FFL. TV, BT & power sockets should be fixed no lower than 450mm above FFL. All wall lights to be fitted at 2100mm above FFL. | | + | Ceiling rose light point. | | kitchen work top. | _ | RJ45 data point | HD | Heat Detector. |
| II I | | | • | LED light fitting. | A | Flush 30A cooker switch 200mm above kitchen work top. | T I | HDMI port (4 & 5 beds only) | COMMS inc Consumer | For sites with FTTP refer to SD/1002. |
| | Symbol | Description | | Under-stair oval bulkhead wall mounted light. | 1 | Gas point. | ∠ N | Immersion heater switch, located in AC. | unit | Tor sites with Fire feler to 3D/1003. |
| | 74 | Flush double switch socket. | ** | External Wall light. | ¥ | Shower head & control position. | - | Rad/Rail. | LOUNGE PLATE | For full lounge plate specification refe CALA Group Internal Specification. |
| | 7₹ | Flush double switch socket with 2 USB points. | 0 | Batten holder light fitting. | | Ceiling mounted extract fan. | P | Heating control programming switch. | IA | Intruder Alarm unit to Nacoss Standa |
| | A | External socket. | 0 | Door bell push. | 4 | Isolator switch. | G | Grid switch. | AP | Alarm Panel |
| · | • | 13A flush unswitched spur. | • | Door bell sounder. | Δ | Shaver socket. | | Thermostat. | | For sites where virgin is to be provide Virgin Media blanking plates are to be |
| | \M/boro si | vitabas ara lacated | | provided adjacent to the low level Lou | | | | | | |

Where switches are located all in the same wall, use 2/3/4 gang switches.

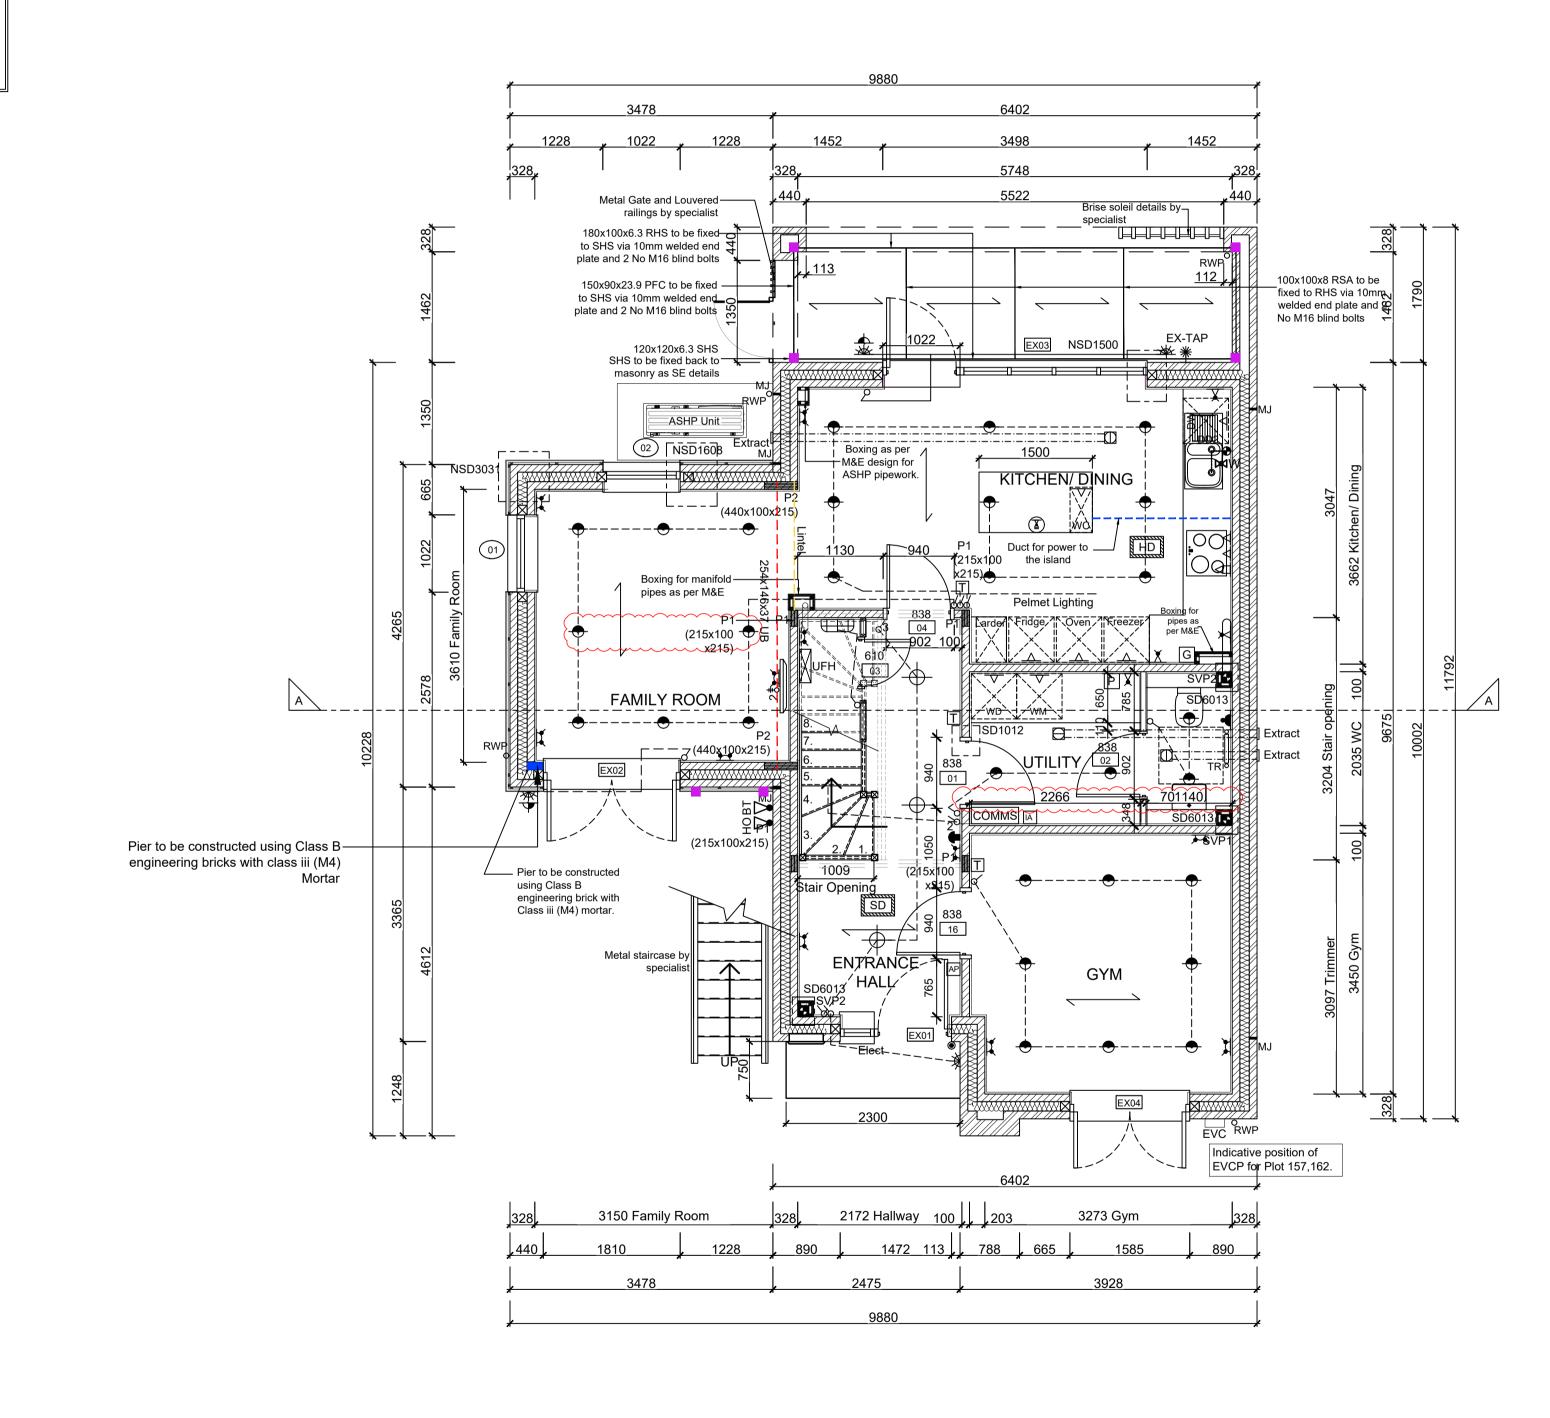

GROUND FLOOR LAYOUT

SCALE 1:50

All dimensions to be checked on site prior to the commencement of construction and any discrepancy should be reported to the Site COMMS For sites with FTTP refer to SD/1002. For sites with FTTC refer to SD/1003. This drawing may not be reproduced in any part or form without written consent. LOUNGE For full lounge plate specification refer to

All copyrights reserved.

socket within the Family Room and Master

Bedroom.

British Telecom Point

유 Hyper Optic Point

Pop up Socket for the Island

Underfloor Heating Manifold

External wall mounted Electric Meter

Sub-Contractors MUST ensure that they have For sites where virgin is to be provided, the latest issue drawing before they commence provided adjacent to the low level Lounge Plate in the lounge, and next to the TV/FM

This drawing is to be read in conjunction with all relevant Specifications, schedules and Engineers details.

RWP/MJ positions to be finalised on Architects drawings on an individual site by site basis

Meter positions to be finalised on Architects drawings on an individual site by site basis

Radiator positions shown as per M&E drawings. Sizing of radiators & towel rails are shown indicatively check M&E drawings for correct sizing.

Indicative postion of EVCP-□EVC:If remote,see External works drawing for position

Extract locations to be confirmed by Vectaire

| R | 08.08.25 | WC/Utility wall updated to site measurement | Ī |
|-----|----------|---|----|
| | | Family room lighting adjusted | Ī |
| Q | 12.06.25 | Relocated kitchen socket, added WC/Utility wall | Ī |
| | | setting out dimensions, add ex. light, grid switch mo | Vē |
| | | comms moved back to utility | Ī |
| Р | 15.05.25 | Kitchen door (04) handed. switches and thermostat | Ī |
| | | relocated.Sockets moved,Utility door handed, Comr | ns |
| | | sockets moved to gym, pop up, socket added. | |
| | | duct for power to island added. | |
| 0 | 14.04.25 | Store Door amended to 610 door. Structural door | Ī |
| | | opening amended. | Ī |
| N | 25.03.25 | Utility & WC ventilation extract routes amended. | |
| М | 06.02.25 | Double socket added as per comments | |
| L | 13.01.25 | Kitchen coordinated with new supplier layout, M&E | |
| | | coordinated, sockets coordinated | |
| K | 15.10.24 | Detail Ref tags co-ordinated. | |
| J | 16.09.24 | Wall key amended | |
| 1 | 12.09.24 | Posts added for ex. stairs, staircase moved away | |
| | | from wall, ex. light relocated, BT/fibre relocated | |
| Н | 16.08.24 | Ashp added. RWP added. | |
| Rev | Date | Description | |



Brooklands College Weybridge

House Type HT8A 4B7P Plots: 157,162 **Ground Floor Plan**

| Scale 1 | :50 @ A1 | Date | May 2023 |
|---------|----------|-------|----------|
| Rev. | R | Drawn | RR |

SA00394-0601-A-HT8A-GA