


Plots 12-13 Pile Data Table							
Pile No.	Pile Load (kN)	Pile Cut Off Level (m)	Easting (m)	Northing (m)			
P092	210	51.075	570617.782	140421.188			
P093	250	51.075	570619.554	140417.106			
P094	250	51.075	570620.271	140415.455			
P095	210	51.075	570622.043	140411.373			
P096	410	51.075	570617.038	140415.032			
P097	350	51.075	570614.081	140419.583			
P098	340	51.075	570618.342	140409.767			
P099	170	51.075	570615.384	140414.314			
P100	200	51.075	570611.482	140418.455			
P101	420	51.075	570613.614	140413.546			
P102	200	51.075	570615.746	140408.639			
P103	180	51.075	570608.887	140417.329			
P104	180	51.075	570613.149	140407.512			
P105	100	51.075	570609.135	140414.493			
P106	340	51.075	570610.191	140412.060			
P107	100	51.075	570611.247	140409.628			



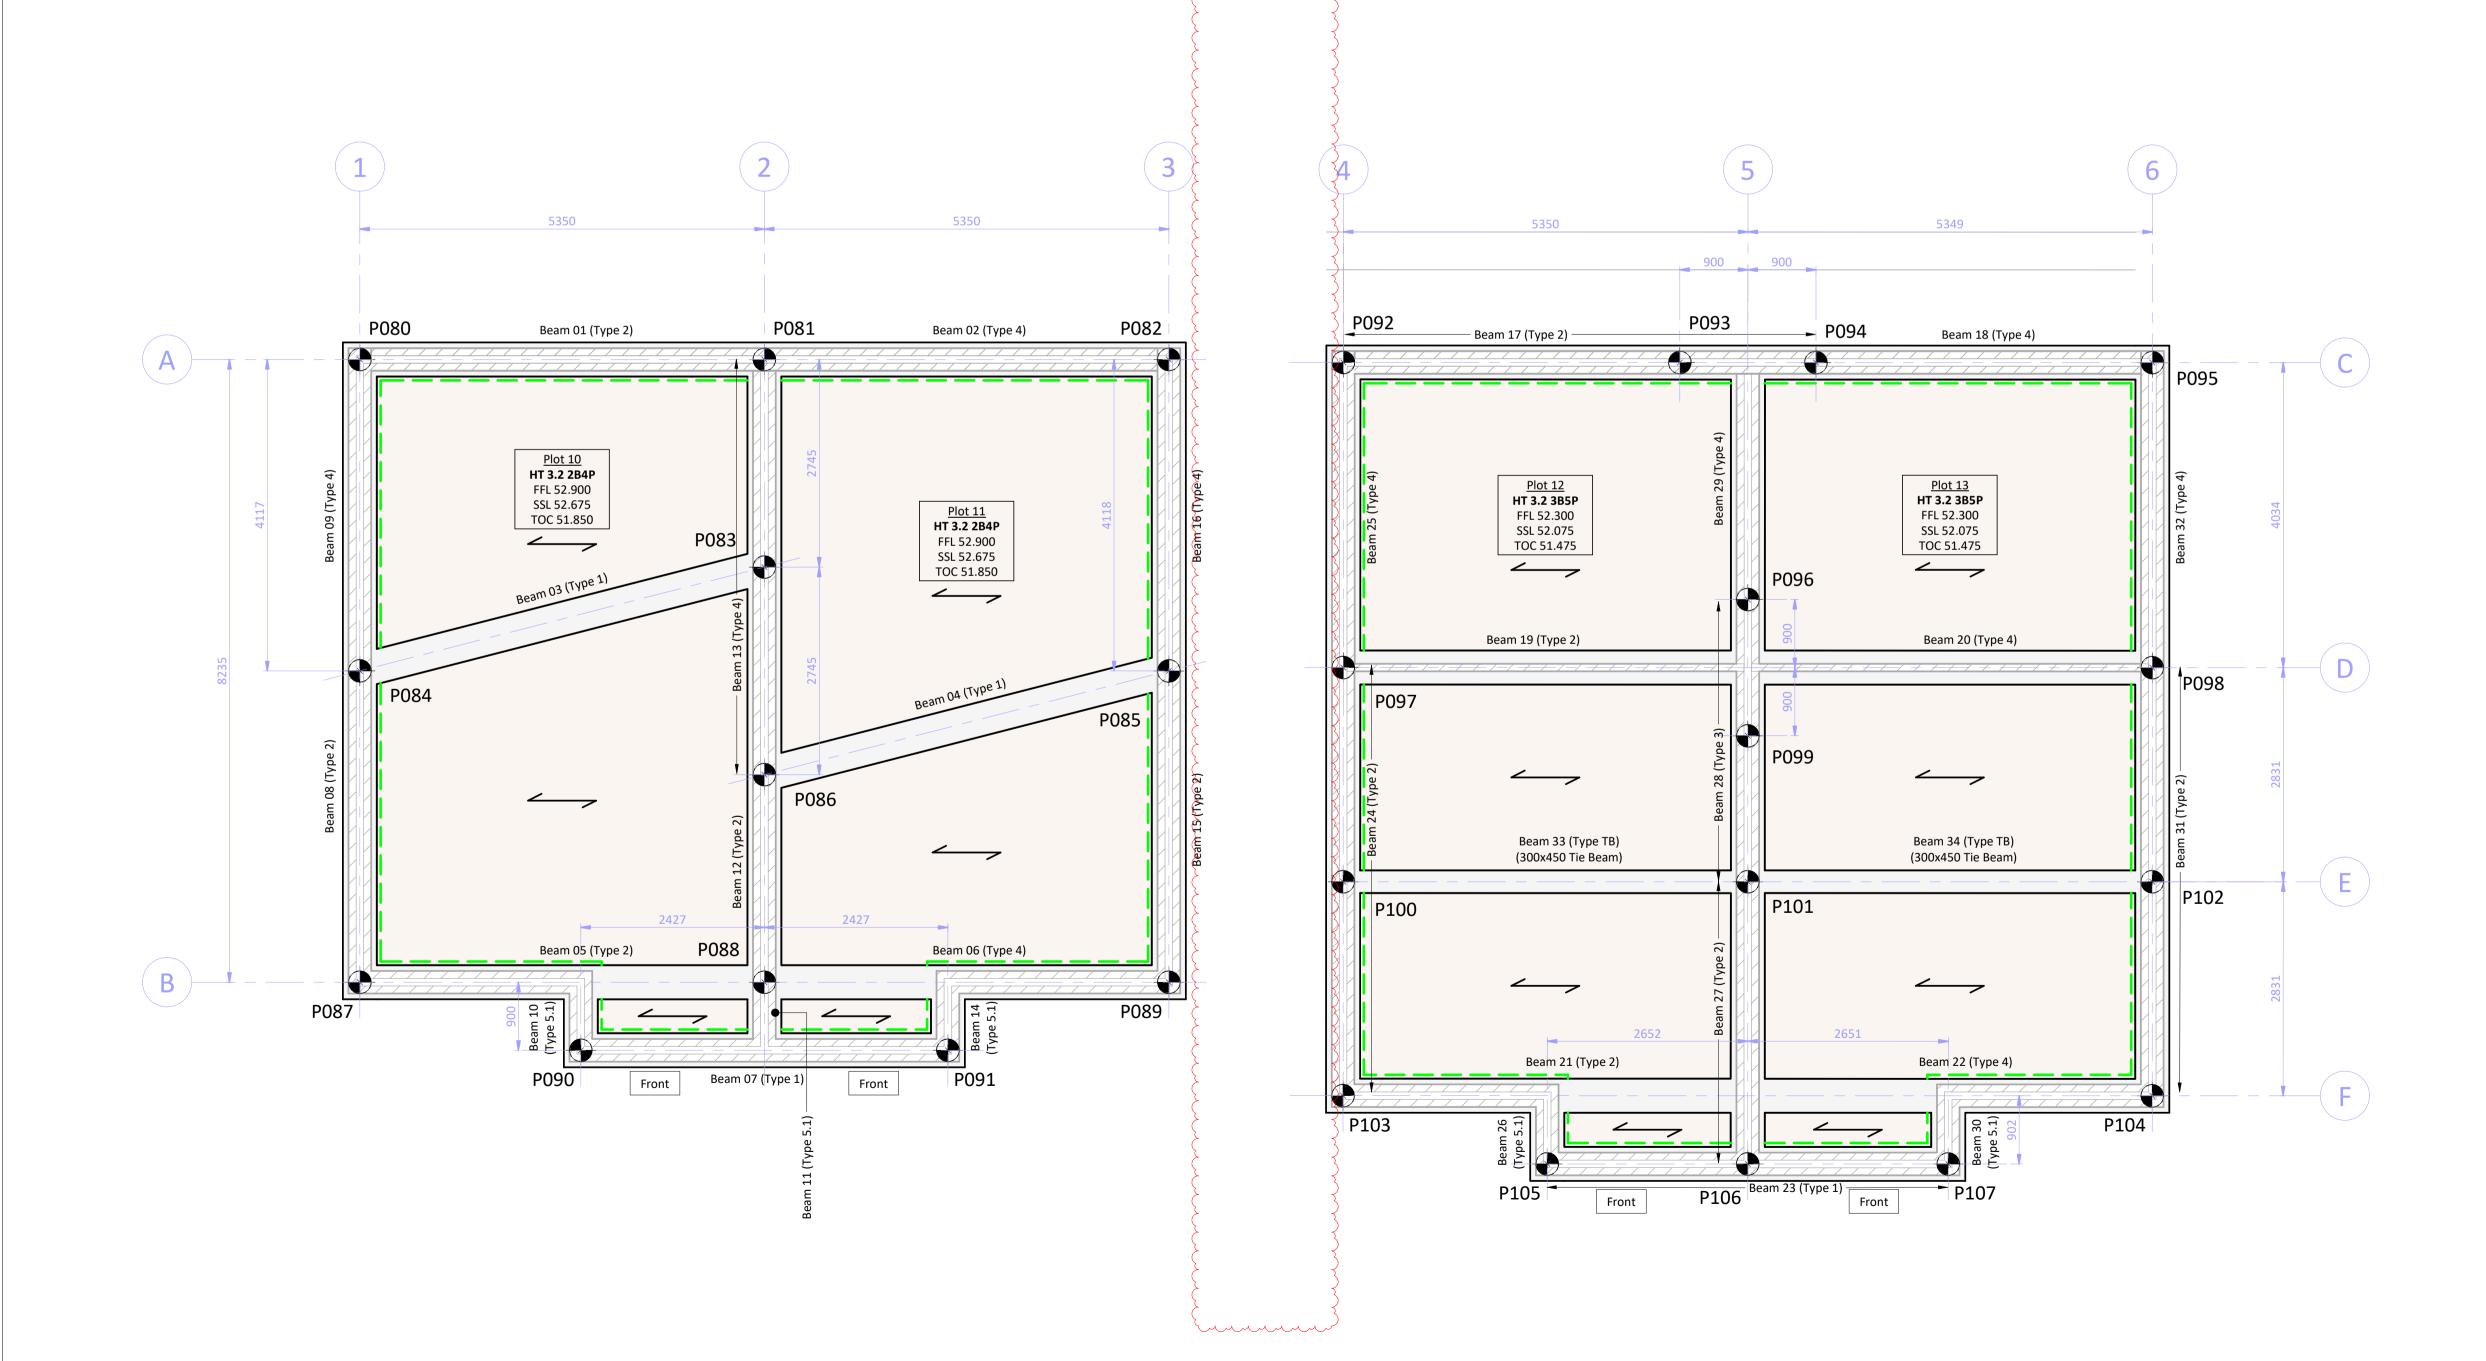

Plots 10-13 Foundation General Arrangements (Scale 1:50)

HEALTH, SAFETY & ENVIRONMENT:

It is the responsibility of the client to ensure that those undertaking the works are competent and experienced in the type of work to be undertaken.

In addition to the hazards usually associated with the types of work detailed on this drawing, the following specific hazards have been identified through design risk assessment. The planning and execution of the works should take into account all usual and specific hazards.

Hazards should also be taken into account in the maintenance, operation, decommissioning and demolition of the works.

Live services may be present on site

⚠ Existing ground is/may be contaminated

⚠ Deep excavations necessary

Ground conditions may be unstable during excavation

The stability of adjacent foundations will need to be considered during excavation works

Piling rig and working platform on sloping site

NOTES:

- 1. All dimensions are in millimetres (mm) and levels in metres (m) Above Ordnance Datum (mAOD) unless noted otherwise.
- Do not scale from this drawing.
- 3. The copyright in this drawing belongs to Structa LLP; the designs and details may not be used on any project other than that indicated in the titleblock.
- Where CAD and Revit files of the drawings are issued, they are provided for the convenience of others, and shall not be used for construction purposes or relied upon for accuracy or completeness.
- The Engineer is not responsible for dimensional information except where shown on these drawings. All setting out information, dimensions etc. shall be calculated from the Architects drawings.
- to Structa drawing 3902-2005.

6. For foundation sections, details and construction notes refer

- For additional retaining walls and retaining wall setting out refer to relevant Civil Engineering drawings.
- 8. For retaining wall construction details including spacing of movement joints, refer to Structa drawings 3902-2025 and 3902-2026.
- For ground beam general notes and reinforcement details refer to Structa drawings 3902-2006 and bar bending schedule 3902-B2013.
- 10. For material and workmanship requirements refer to notes on relevant drawings and structural specification 3902-SS001.

C2	20.12.24	REVISED AS CLOUDED. SECTION D-D REMOVED. LEGEND UPDATED	CDJ	NW	TJS
C1	11.12.24	CONSTRUCTION ISSUE	GB	NW	TJS
P2	14.03.24	RETAINING WALLS UPDATED AND REFERENCES ADDED	GB	NW	TJS
P1	23.02.24	FIRST ISSUE	GB	NW	TJS
Rev.	Date	Description	Drawn	Checked	Approved

FOR CONSTRUCTION



BASSETTS FARM, HORSMONDEN

PLOTS 10-13 FOUNDATION GENERAL ARRANGEMENTS

StructuralCivilGeo-environmental

SCALE 1:50 @ A1

structo

Drawing No: Revision: