


	Plots 8-9 Pile Data Table				
Pile No.	Pile Load (kN)	Pile Cut Off Level (m)	Easting (m)	Northing (m)	
P064	210	51.075	570576.787	140405.933	
P065	250	51.075	570575.011	140410.014	
P066	250	51.075	570574.293	140411.664	
P067	210	51.075	570572.518	140415.744	
P068	410	51.075	570577.526	140412.089	
P069	350	51.075	570580.486	140407.541	
P070	340	51.075	570576.218	140417.354	
P071	170	51.075	570579.177	140412.806	
P072	200	51.075	570583.080	140408.668	
P073	420	51.075	570580.946	140413.577	
P074	200	51.075	570578.814	140418.483	
P075	180	51.075	570585.678	140409.798	
P076	180	51.075	570581.409	140419.612	
P077	100	51.075	570585.428	140412.634	
P078	340	51.075	570584.370	140415.066	
P079	100	51.075	570583.313	140417.498	


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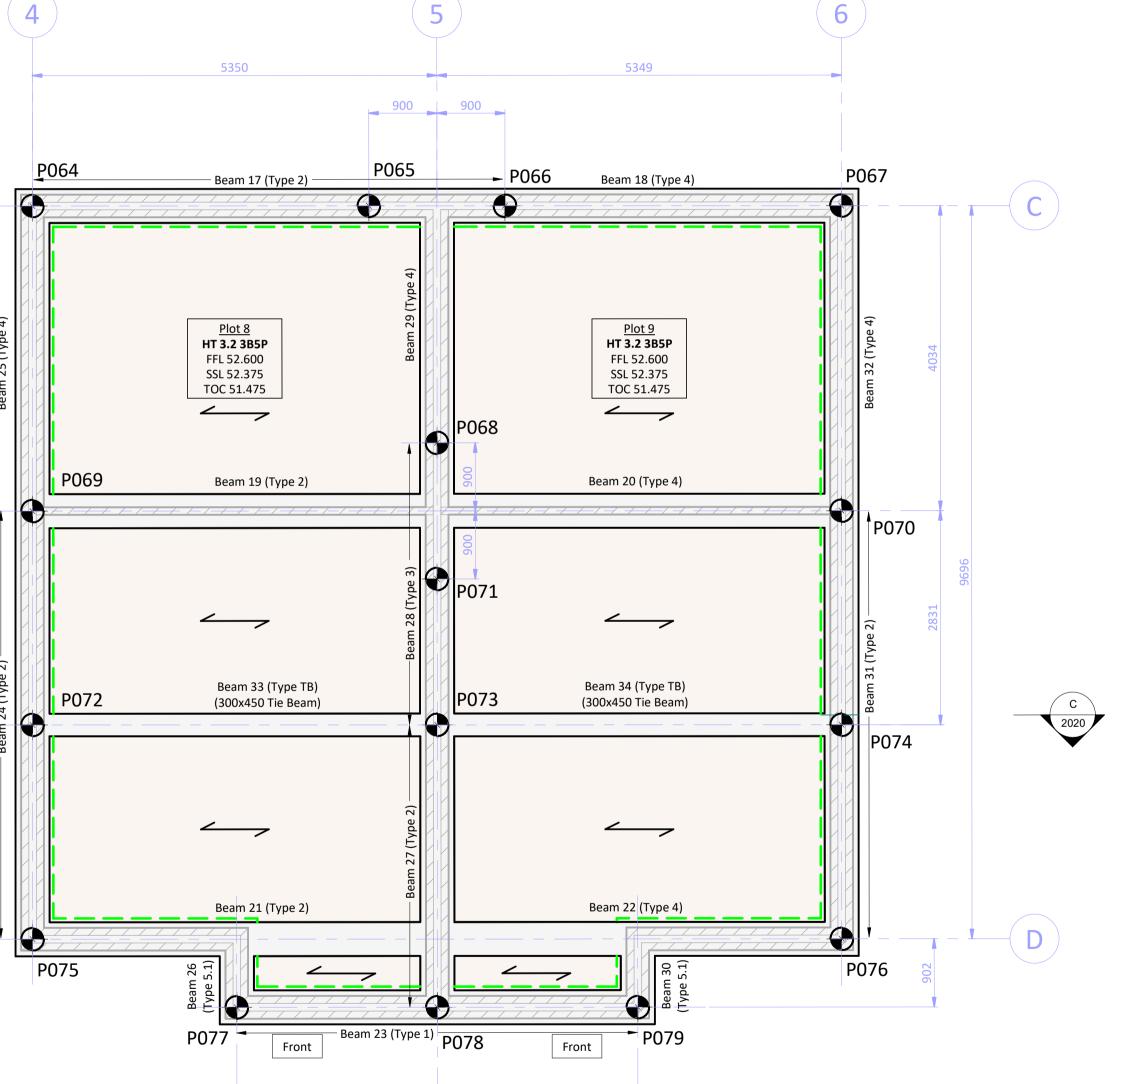
Movement joints-

omitted for clarity, see Note 8 (Typical)

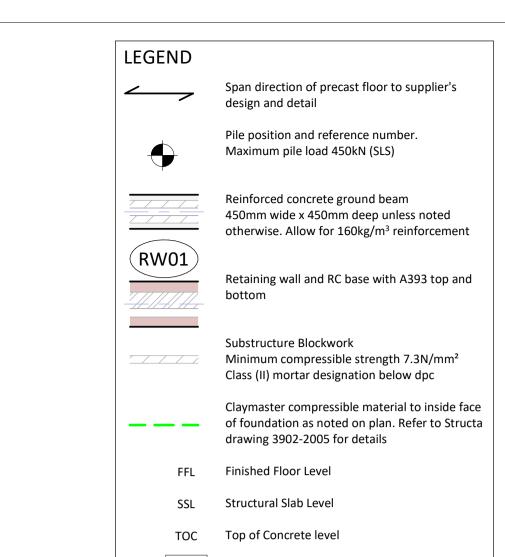

Front entrance door location



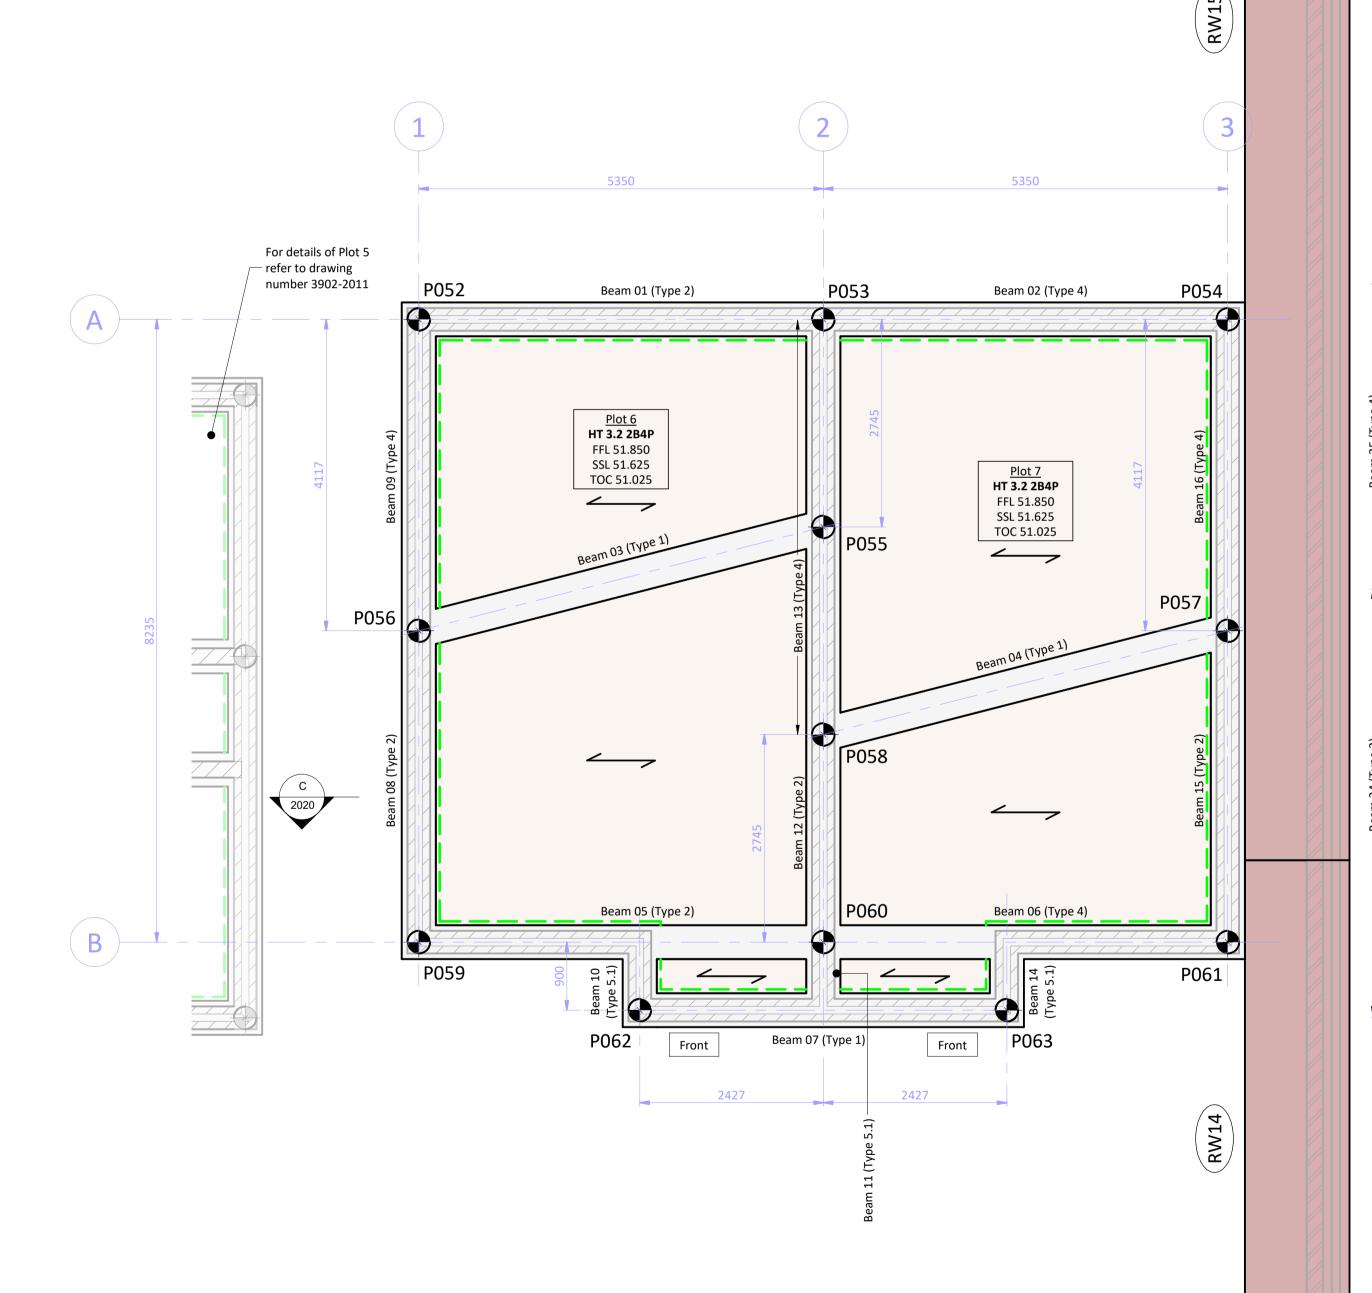

SCALE 1:50 @ A1

HEALTH, SAFETY & ENVIRONMENT:

It is the responsibility of the client to ensure that those undertaking the works are competent and experienced in the type of work to be

In addition to the hazards usually associated with the types of work detailed on this drawing, the following specific hazards have been identified through design risk assessment. The planning and execution of the works should take into account all usual and specific

Hazards should also be taken into account in the maintenance. operation, decommissioning and demolition of the works.

Live services may be present on site

Existing ground is/may be contaminated

Deep excavations necessary

Ground conditions may be unstable during excavation

The stability of adjacent foundations will need to be considered during excavation works

Piling rig and working platform on sloping site

## NOTES:

- 1. All dimensions are in millimetres (mm) and levels in metres (m) Above Ordnance Datum (mAOD) unless noted otherwise.
- 2. Do not scale from this drawing.
- 3. The copyright in this drawing belongs to Structa LLP; the designs and details may not be used on any project other than that indicated in the titleblock.
- 4. Where CAD and Revit files of the drawings are issued, they are provided for the convenience of others, and shall not be used for construction purposes or relied upon for accuracy or completeness.
- 5. The Engineer is not responsible for dimensional information except where shown on these drawings. All setting out information, dimensions etc. shall be calculated from the Architects drawings.
- to Structa drawing 3902-2005. 7. For additional retaining walls and retaining wall setting out

6. For foundation sections, details and construction notes refer

- refer to relevant Civil Engineering drawings. 8. For retaining wall construction details including spacing of movement joints, refer to Structa drawings 3902-2025 and
- 3902-2026. 9. For ground beam general notes and reinforcement details refer to Structa drawings 3902-2006 and bar bending
- schedule 3902-B2012. 10. For material and workmanship requirements refer to notes on

relevant drawings and structural specification 3902-SS001.

REVISED AS CLOUDED REVISED AS CLOUDED CONSTRUCTION ISSUE P1 23.02.24 FIRST ISSUE

## FOR CONSTRUCTION



BASSETTS FARM, HORSMONDEN

PLOTS 6-9 FOUNDATION GENERAL ARRANGEMENTS

Structural Civil Geo-environmental

Drawing No: 3902-2012

Revision: **C**3

Plots 6-9 Foundation General Arrangements (Scale 1:50)