


(2) ARCH 2544G\_HIG5\_DM.1.A SQ FT: 1950 ft²

SQ M:

Highgate M4(2)

**G SERIES** 

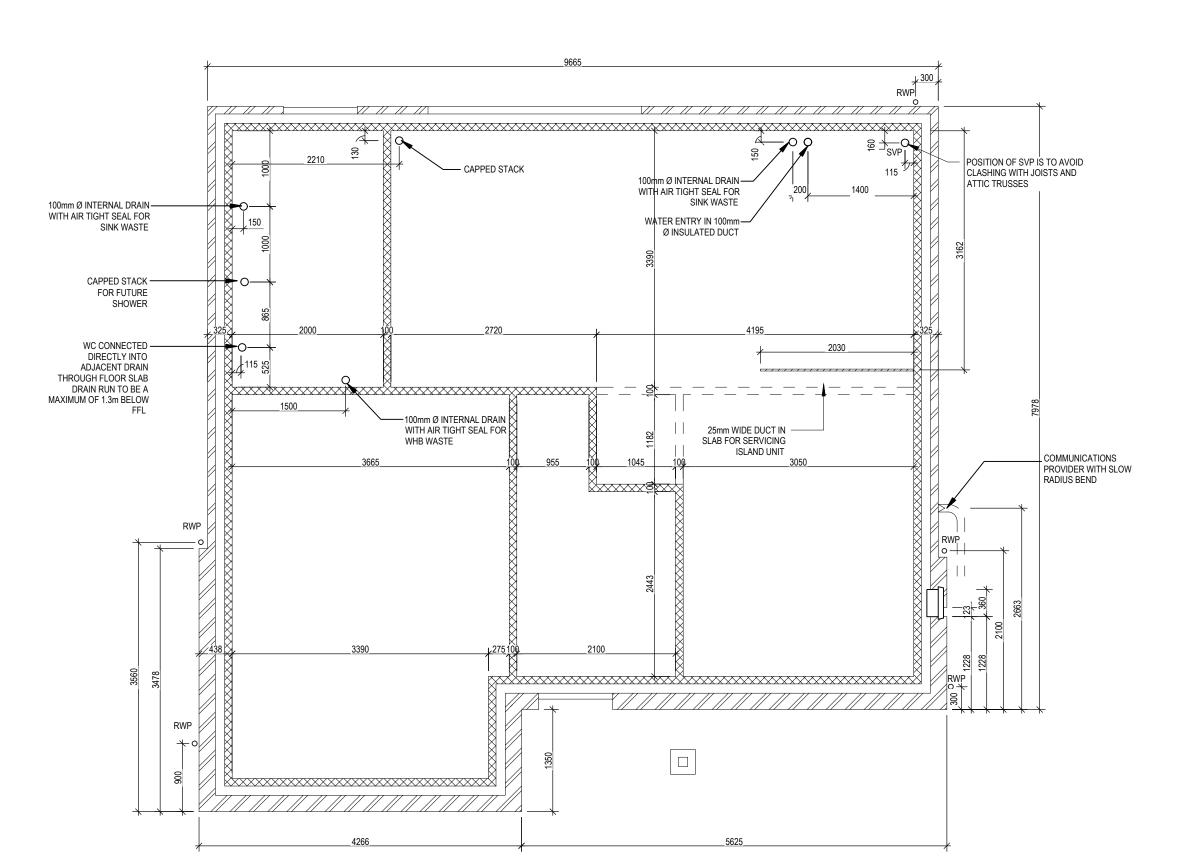

Highgate M4(2)


Slab Penetration Layout

**Date** =eb 2023 **Scale** 1 : 50

200

160 Dwg No Dwg Rev

copyright law. Do Not Scale

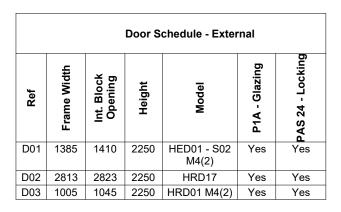

	Door	Schedul	Schedule - Internal			
Ref	Width	Height Fire Rating		Code		
D04	900	2150	FD 30	HID2		
D05	900	2150	FD 30	HID2		
D06	825	2150	FD 30	HID3		
D07	900	2150		HID2		
D08	900	2150		HID2		

Window Schedule									
Ref	Frame Width	Frame Height	Int Block Opening	Comments	P1A - Glazing	PAS 24 - Locking			
W01	1835	1640	1845	Note 1	No	Yes			
W02	2510	1640	2520		No	Yes			
W03	710	1040	720	Obscure	No	Yes			
W04	1273	1190	1283		No	Yes			


Note 1: Handle 1200mm above FFL max.

NOTE: ALL WINDOWS TO BE FITTED WITH OVER-FRAME TRICKLE VENTILATORS. FOR MINIMUM TRICKLE VENTILATION RATES FOR EACH WINDOW WIDTH SEE WINDOW AND DOOR SCHEDULE.

HANDLES - ALL WINDOW HANDLES TO BE FITTED AT A MXIMUM OF 1400MM ABOVE FFL UNLESS OTHERWISE STATED IN THE COMMENTS COLUMN.

ALL WINDOWS TO BE SAFE CLEAN IN ACCORDANCE WITH B.S. 8213.

WHOLE HOUSE TRICKLE VENTILATION REQUIREMENT STATED ON VENTILATION DRAWING

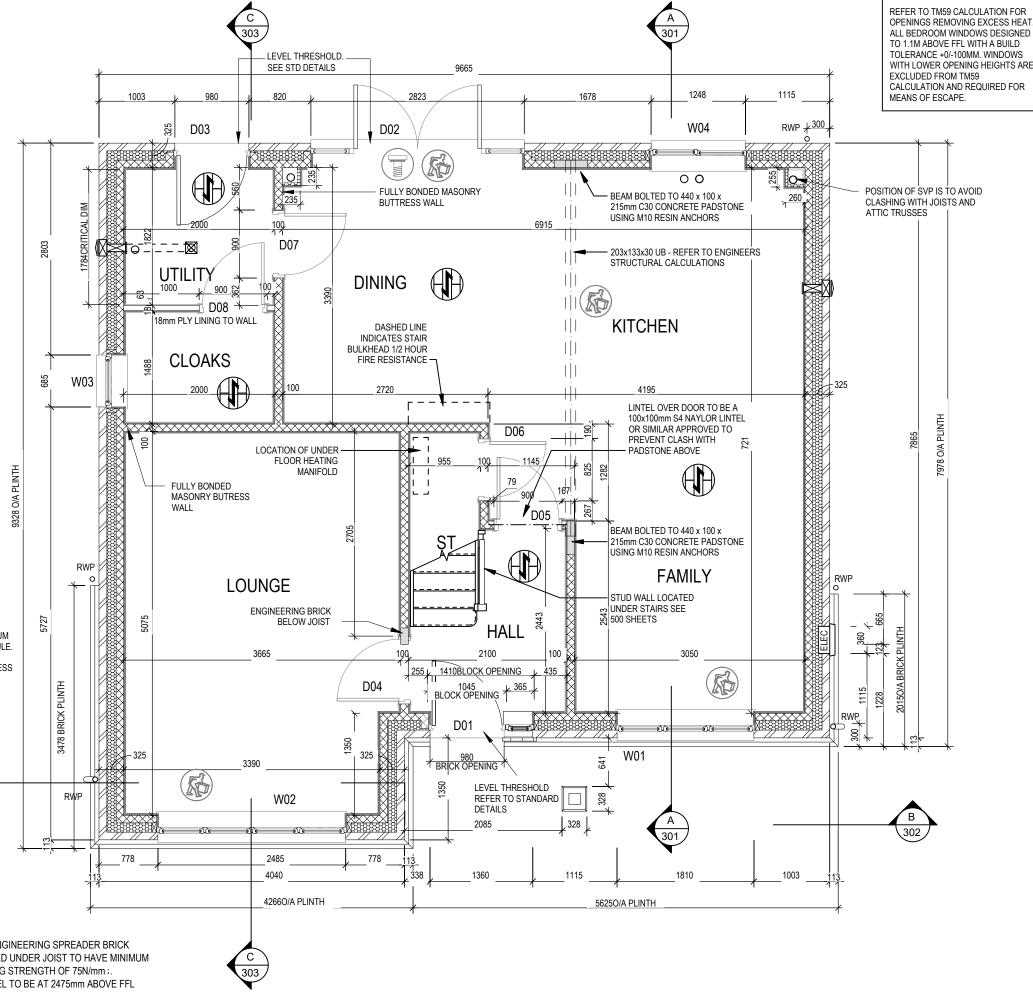

#### WALL LEGEND

WALL TYPE	SIZE (mm)	STRENGTH (N/mm²)	DENSITY (Kg/m³)	LAMBDA (A)
BLOCKWORK	100	7.3	1650	0.15
40dB STUDWORK (####################################	63 (88)	-	-	-

**NOTE**: ENGINEERING SPREADER BRICK CENTERED UNDER JOIST TO HAVE MINIMUM CRUSHING STRENGTH OF 75N/mm 2. TOP LEVEL TO BE AT 2475mm ABOVE FFL





Structural Layout Ground Floor Highgate M4(2)

201 201 Dwg Rev

S N

**Scale** 1:50

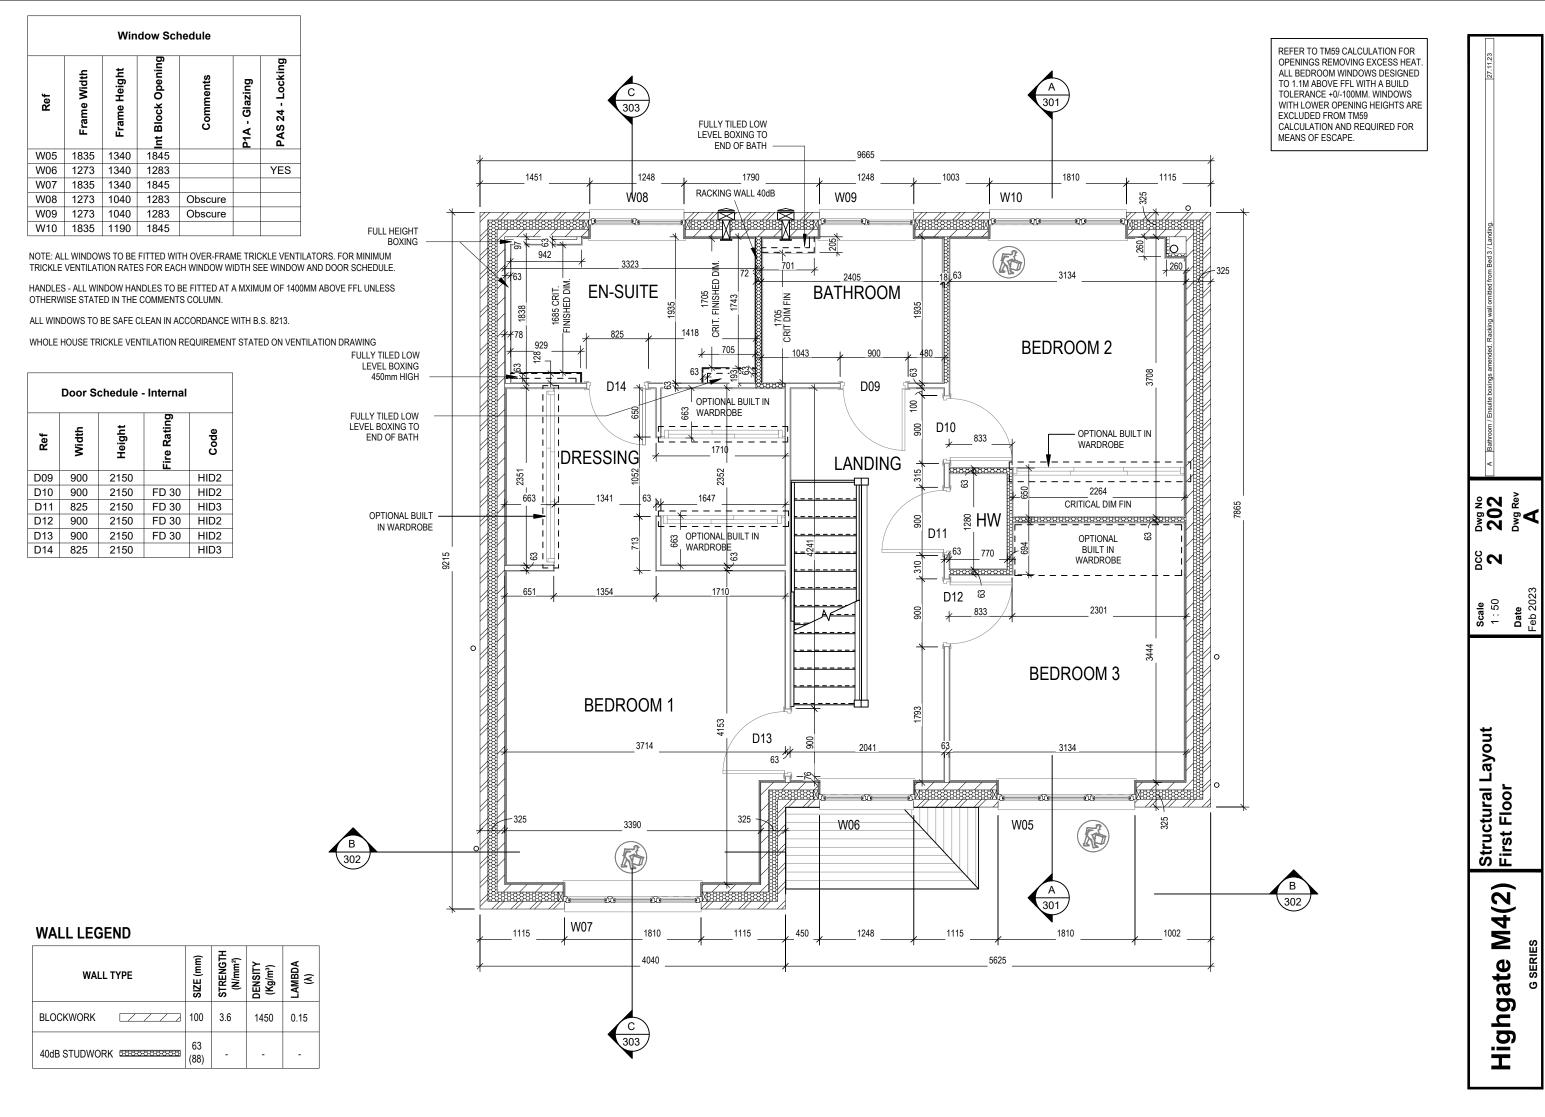

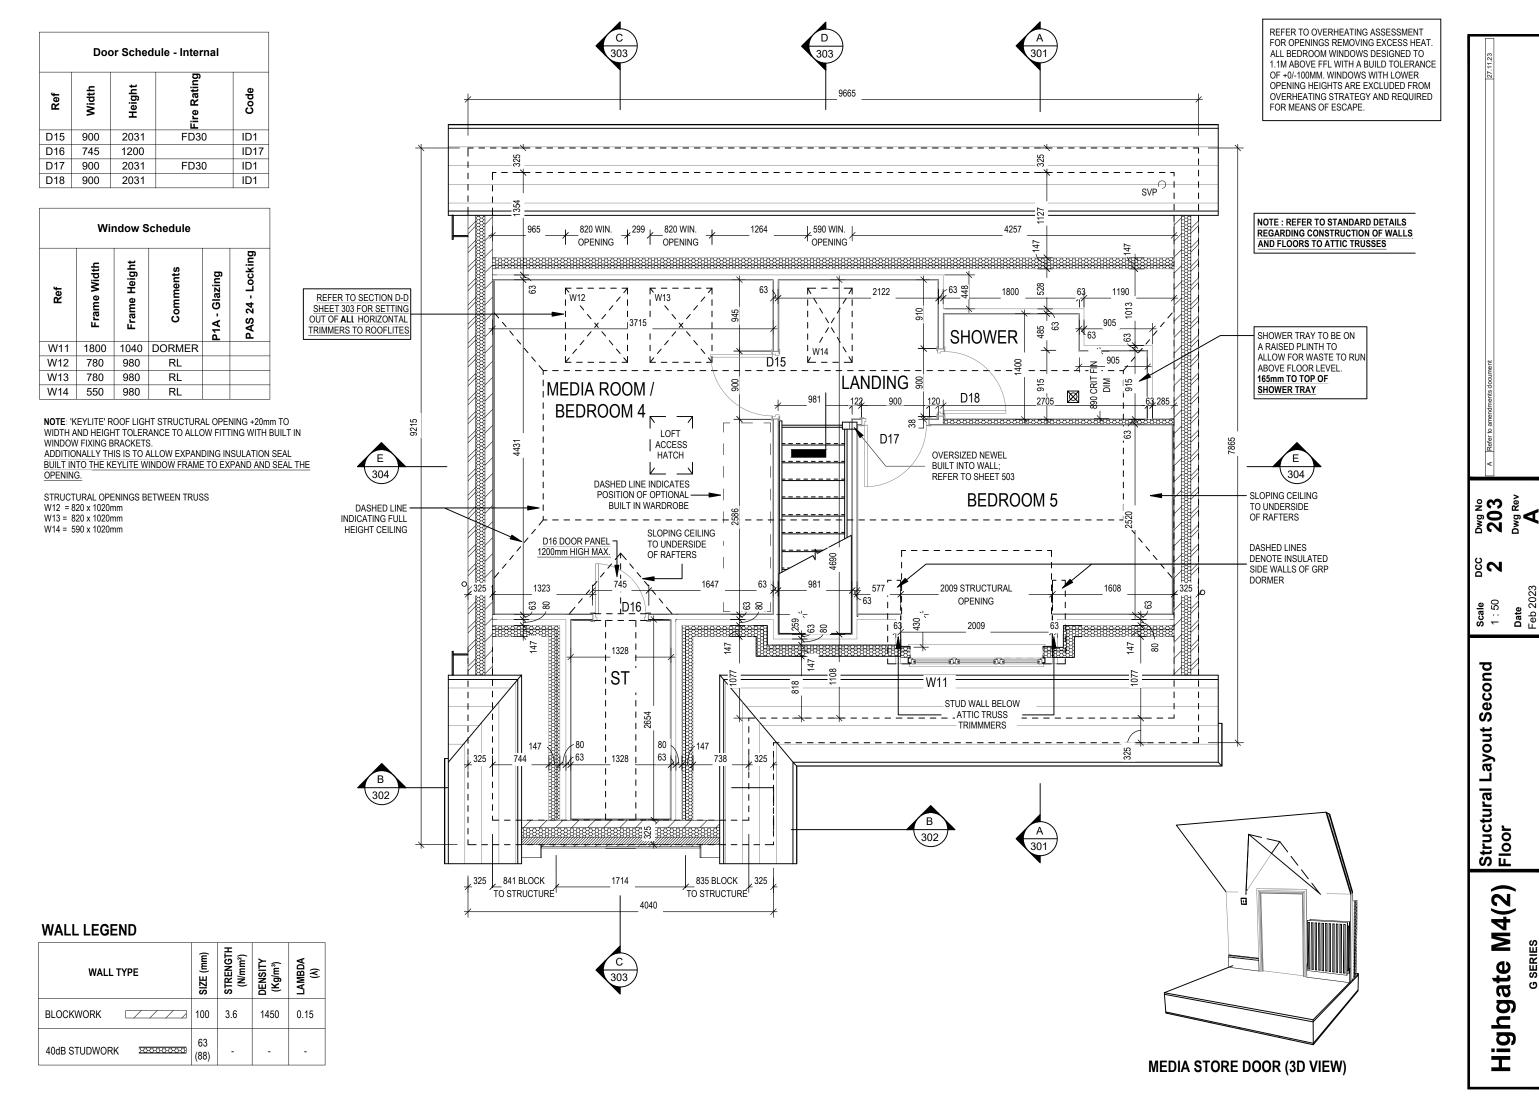

law.Do Not



MAN HANDLING- STEEL AND LINTEL

SEE SCHEDULE FOR WEIGHT.

PART 'O' COMPLIANCE DIAGRAM Scale: 1:50

Highgate M4(2)

301 301 Dwg Rev


S<sub>N</sub>


**Scale** 1:50


Section A-A

PART 'O' COMPLIANCE DIAGRAM Scale: 1:50


302 302 Dwg Rev 82 **Scale** 1:50 **Date** Feb 2 Section B-Highgate M4(2)

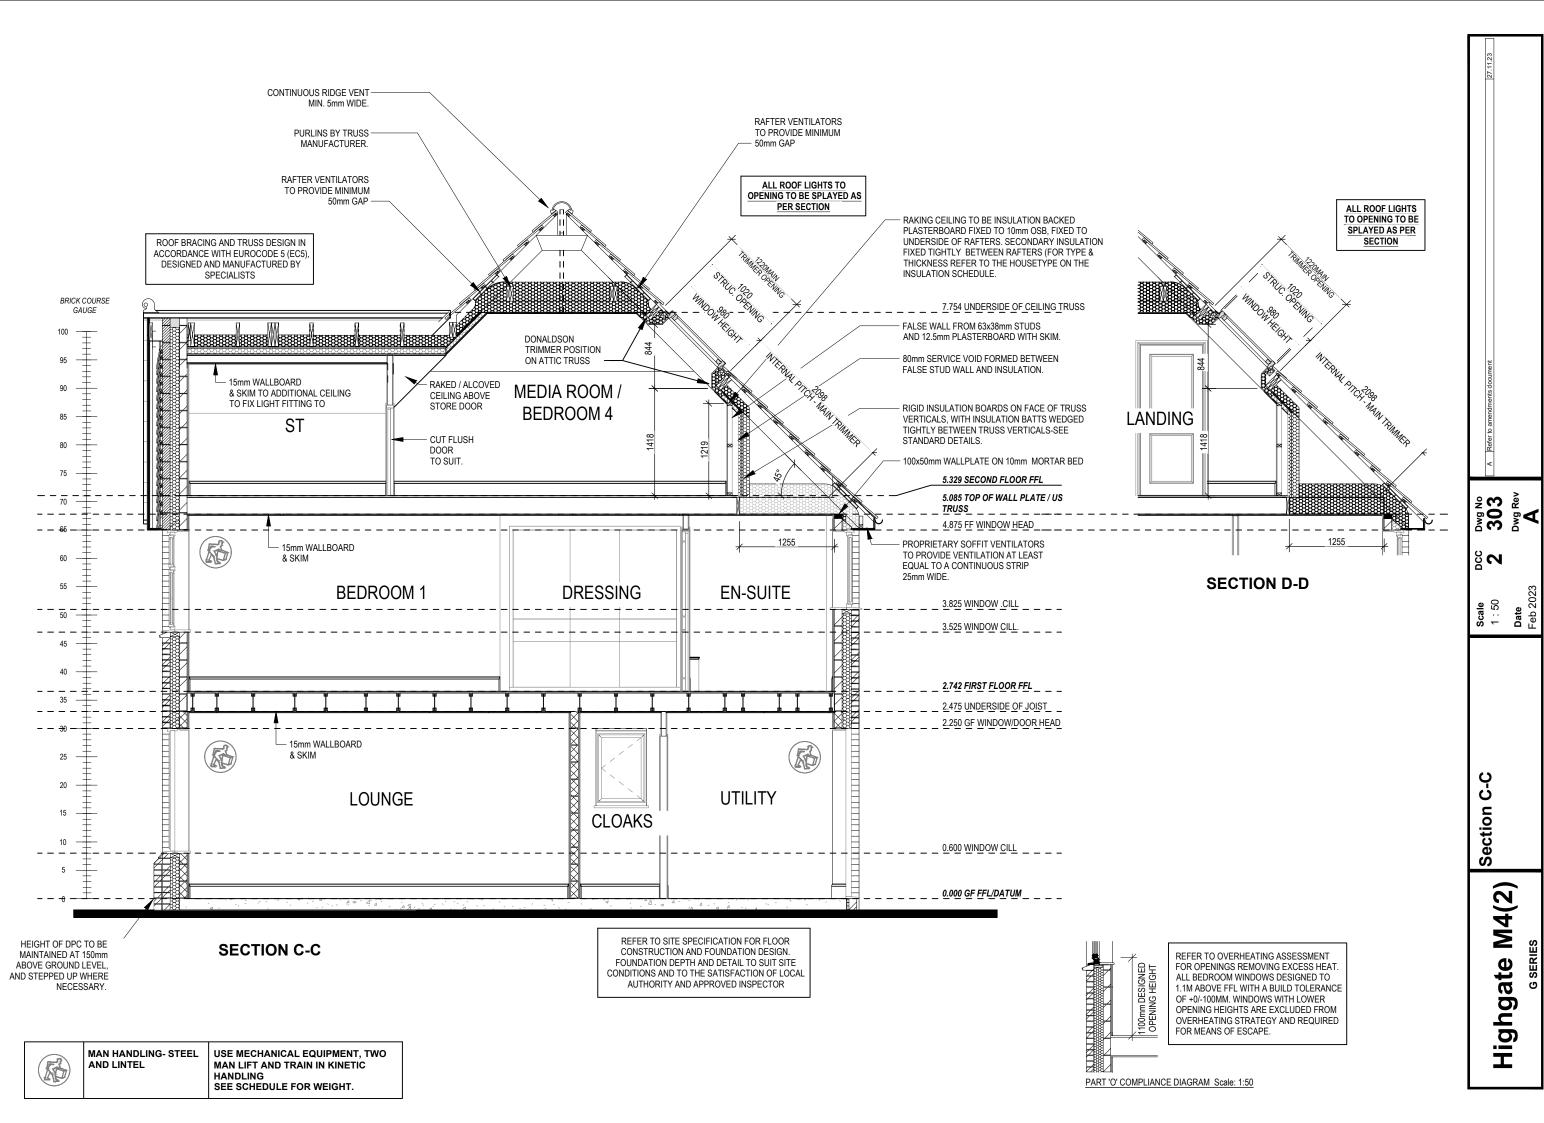

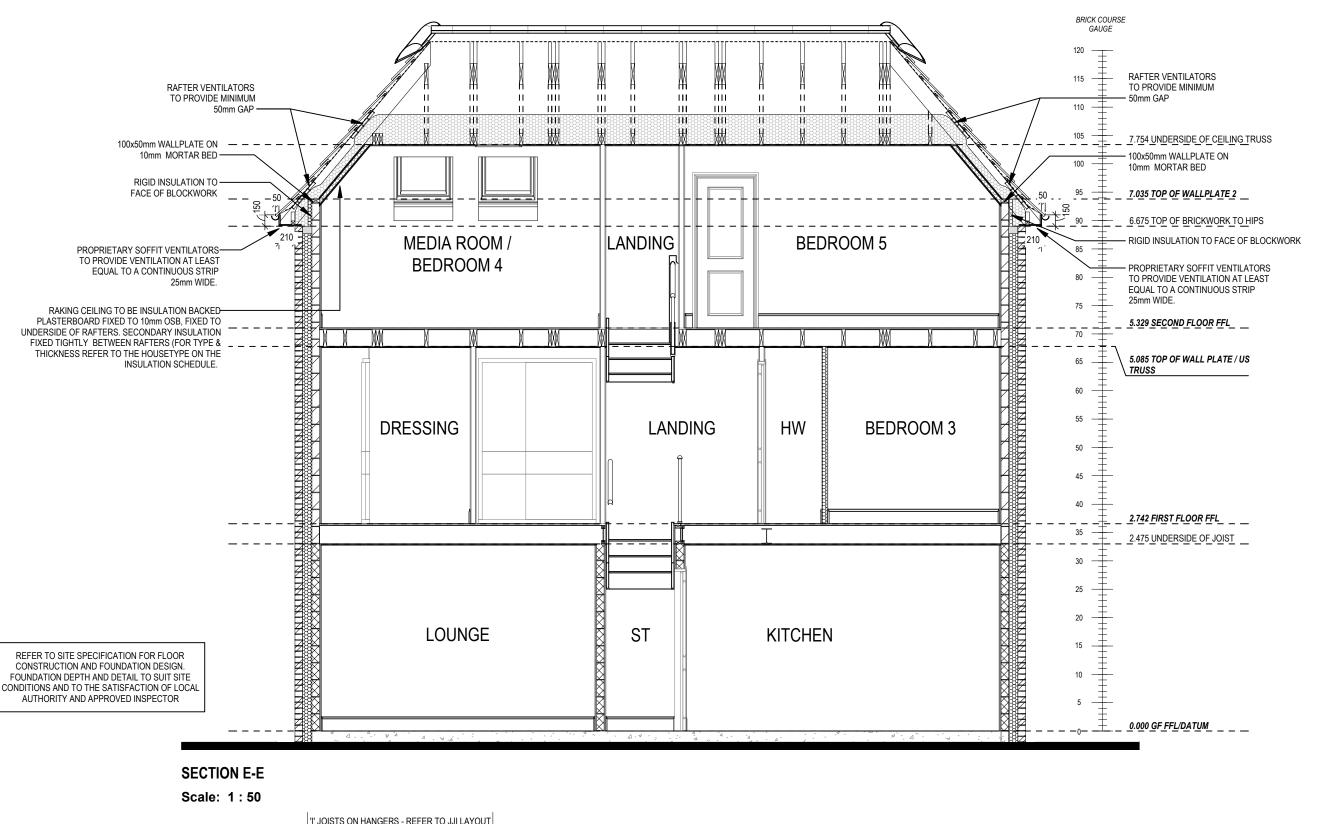

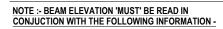

- REFER TO 'BETTS' INFORMATION FOR STRUCTURAL ENGINEERS DESIGN SPECIFICATIONS OF STEEL BEAMS
- REFER TO 'JJI' FLOOR JOIST LAYOUTS FOR SETTING OUT OF FLOOR JOISTS AND JOIST HANGER SPECIFICATIONS

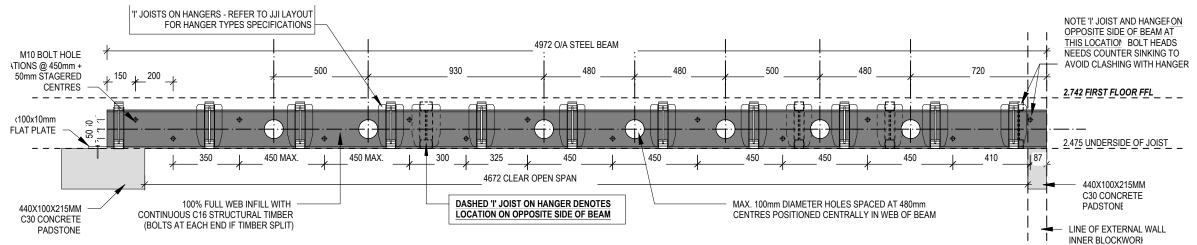

303 303 Dwg Rev

8 N

Щ ⊗


ш

Section

Highgate

## **SECTION F-F (STEEL BEAM ELEVATION)**

Scale: 1:20

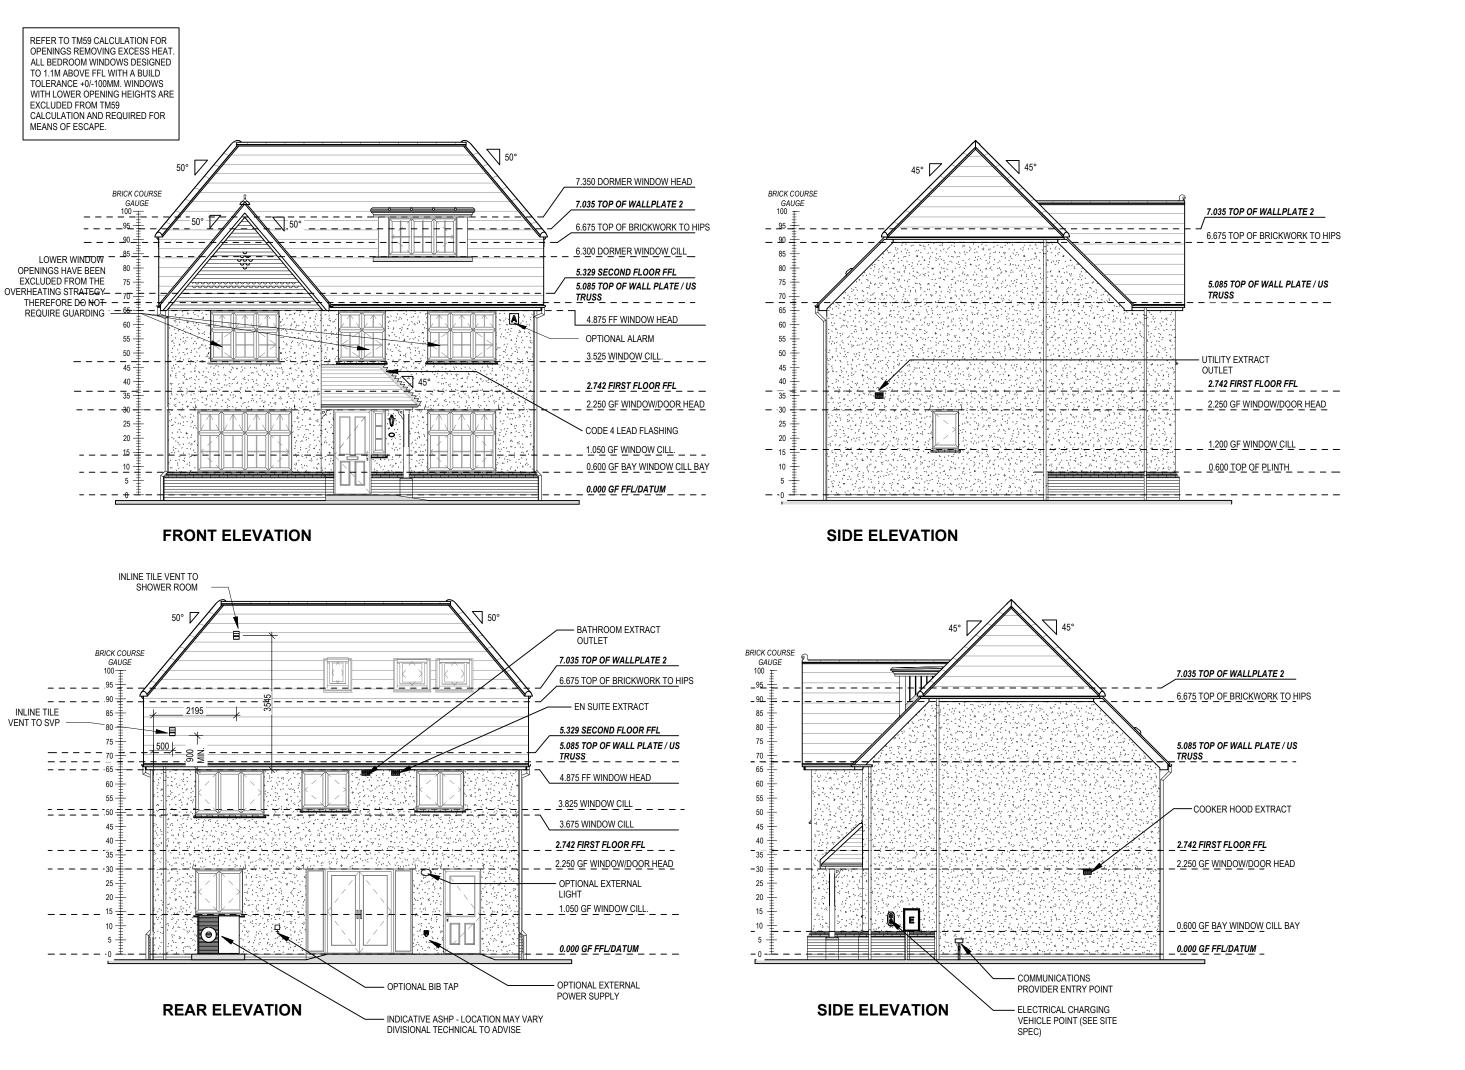

Highgate M4(2)


402 402 Dwg Rev


S N


**Scale** 1:100

Elevations A1

**Date** Feb 2

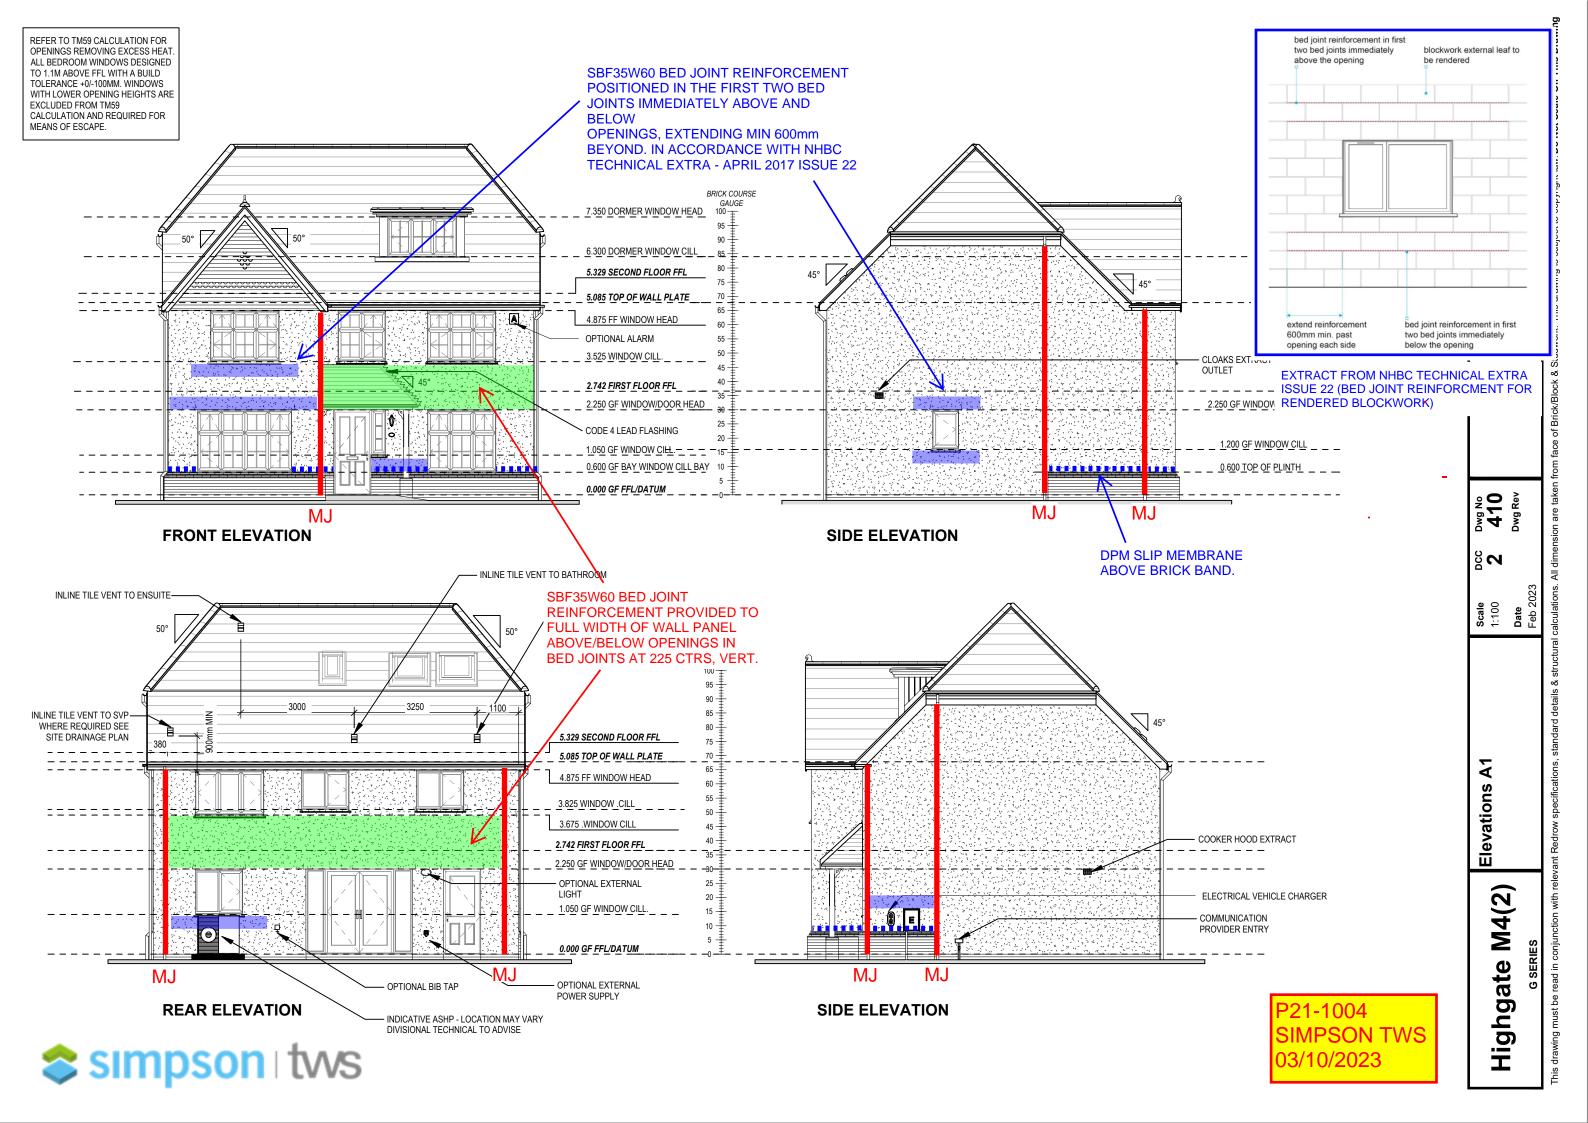

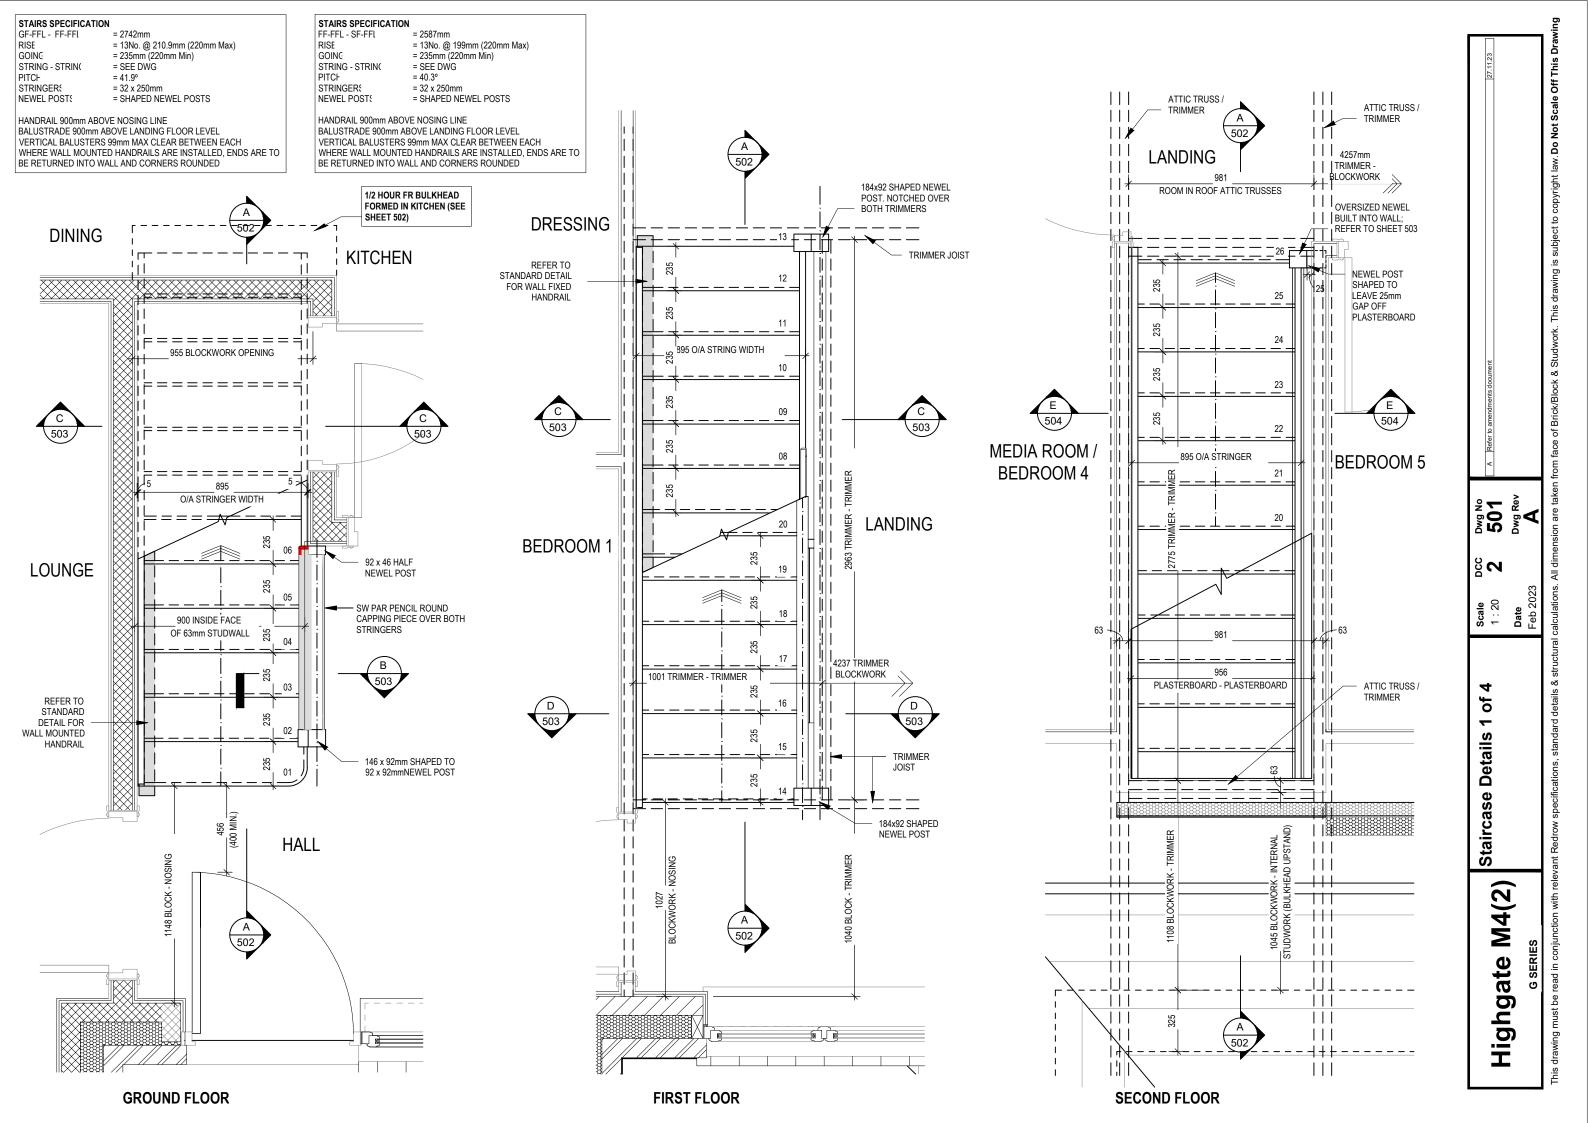

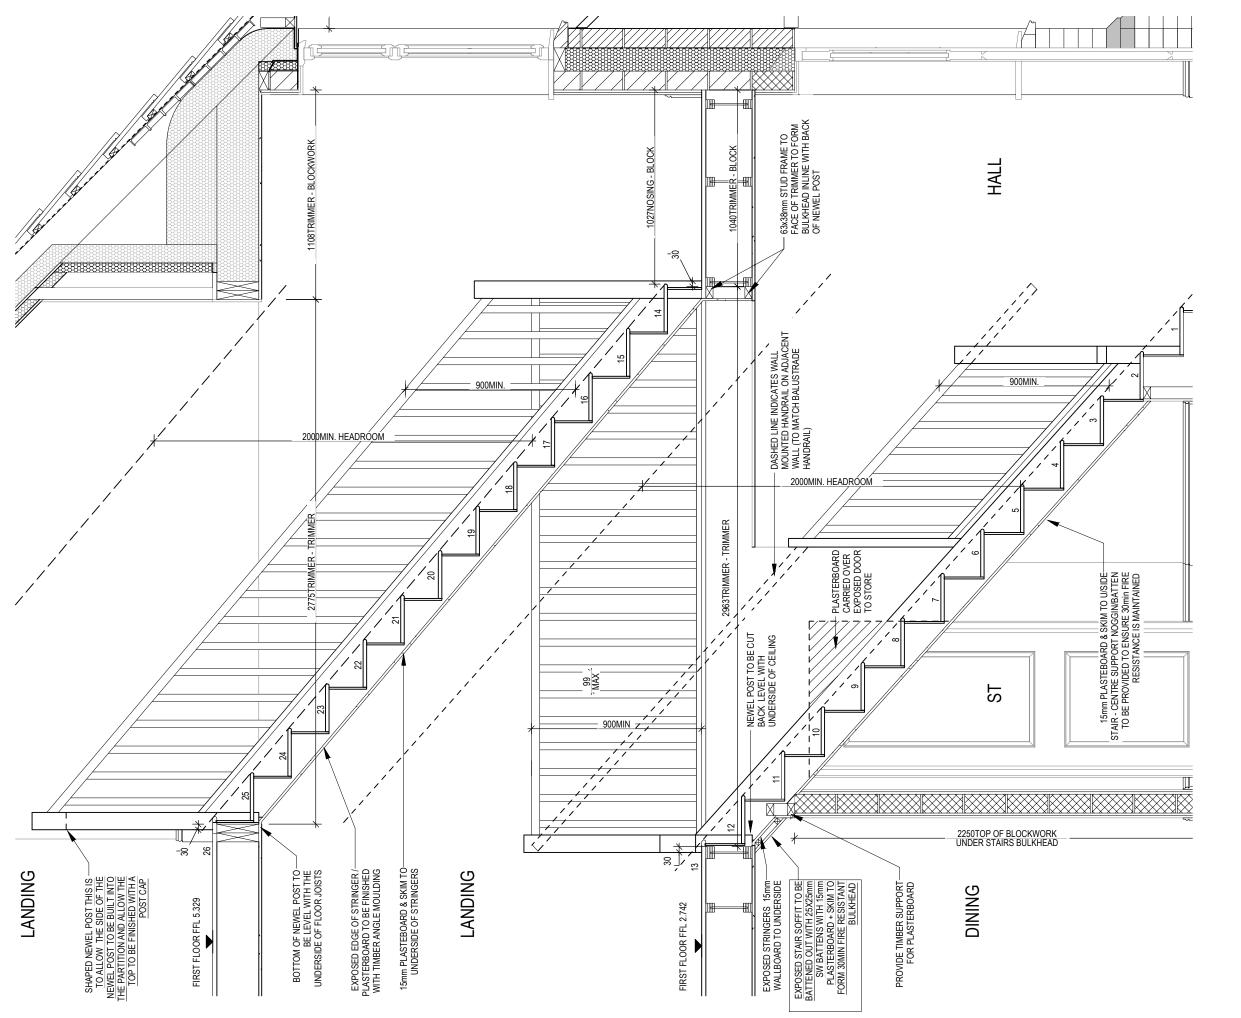

Stair Section A-A


Highgate M4(2) G SERIES

Staircase Details 2 of 4


200 **Date** Feb 2023 Scale 1 : 20

502 502 Dwg Rev

from face of Brick/Block & Studwork. This drawing is subject to copyright law. Do Not Scale Off This Drawin

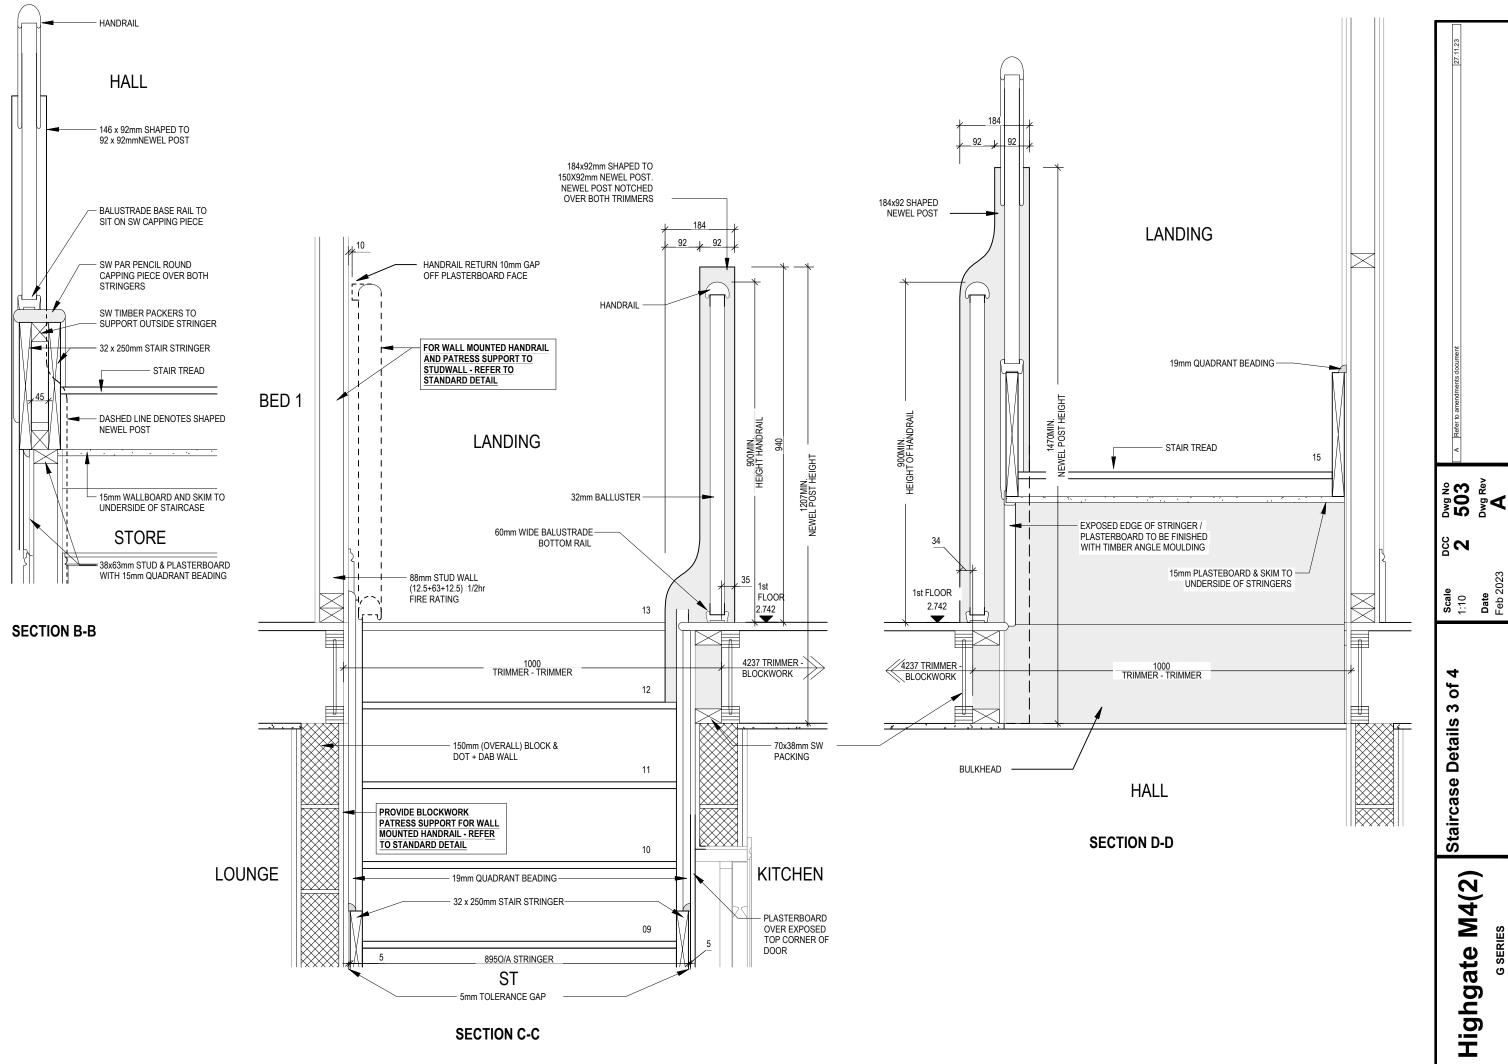


copyright law. Do Not

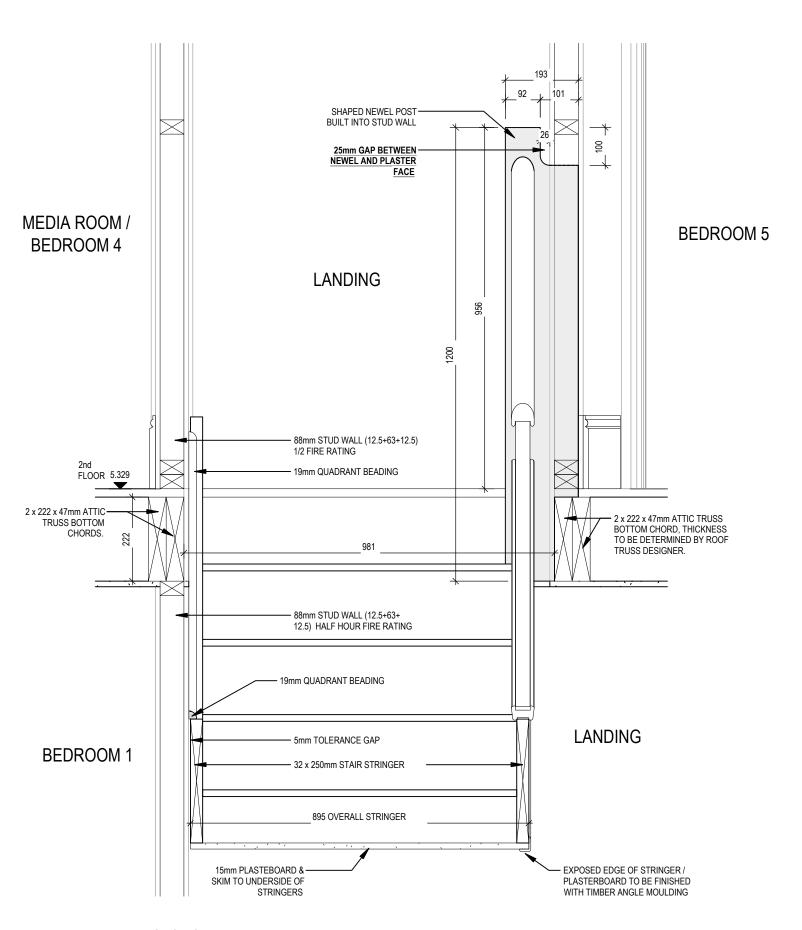

SECTION E-E

504 Dwg Rev Dwg Rev 200 Staircase Details 4 of 4 Highgate M4(2)

- PENDANT TYPE LIGHT FITTING
- BATTEN HOLDER LIGHT FITTING
- SINGLE S/W SOCKET OUTLET (LOW LEVEL)
- DOUBLE S/W SOCKET OUTLET (FILLED AT LOW LEVEL, CLEAR AT HIGH
- USB 💈 DOUBLE S/W SOCKET OUTLET WITH DOUBLE USB SOCKET (FILLED AT LOW LEVEL, CLEAR AT HIGH LEVEL) USB ∹
- EV 💈 ELECTRIC VEHICLE CHARGE POINT (SEE SITE SPECIFICATION)
- EXT -€ EXTERNAL POWER SUPPLY (OPTIONAL)
  - $-\Box$ FUSED OUTLET (IMMERSION)
- ISOLATOR SWITCH
- SINGLE SWITCH, DOUBLE SWITCH, TRIPLE SWITCH
- 88 NOTE: WHERE MULTIPLE SWITCHES ARE INDICATED TOGETHER THESE ARE TO BE SWITCHED ON ONE SINGLE PLATE NOT ON 888 MUI TIPLE PLATES
- COMBINED T.V., SATELLITE AND DATA POINT WITH OPTIONAL HIGH
- T.V. POINT WITH OPTIONAL DATA POINT AND OPTIONAL HIGH LEVEL
- OPTIONAL T.V. POINT WITH OPTIONAL DATA POINT AND OPTIONAL HIGH LEVEL MOUNT
- DATA POINT
- (S) SMOKE DETECTOR
- (H) HEAT DETECTOR
- SHAVER SOCKET
- ROOM THERMOSTAT
- INDIVIDUAL ZONE THERMOSTAT
- PROGRAMMER AND HOT WATER TIMER
- PT ∌∏ PROGRAMMABLE THERMOSTAT
- EXTERNAL WALL LIGHT FITTING WITH INTEGRAL DUSK TO DAWN
- EXTERNAL SURFACE MOUNTED BULKHEAD LIGHT FITTING TO 0
- DOOR BELL PUSH BUTTON IN FRAME
- PV METER SWITCH (SITE UPGRADE/CUSTOMER OPTION)
- SEMI RECESSED CONSUMER UNIT
- DUSK TO DAWN SENSOR  $\triangleleft$
- COMMS ENTRY POINT WITH SLOW RADIUS BEND
  - COMBINATION WALL MOUNTED ELECTRICAL DEVICES (REFER TO STD
  - DETAIL), CONSISTING:
  - DOOR BELL CHIME
  - ALARM KEYPAD (CUSTOMER OPTION)
    - TRIPLE LIGHT SWITCH
- BANK OF SWITCHES
- PASSIVE INFRA-RED DETECTOR TO BE FITTED 2.4m MAX ABOVE FFL (CUSTOMER OPTION)
- DOOR CONTACT (CUSTOMER OPTION)

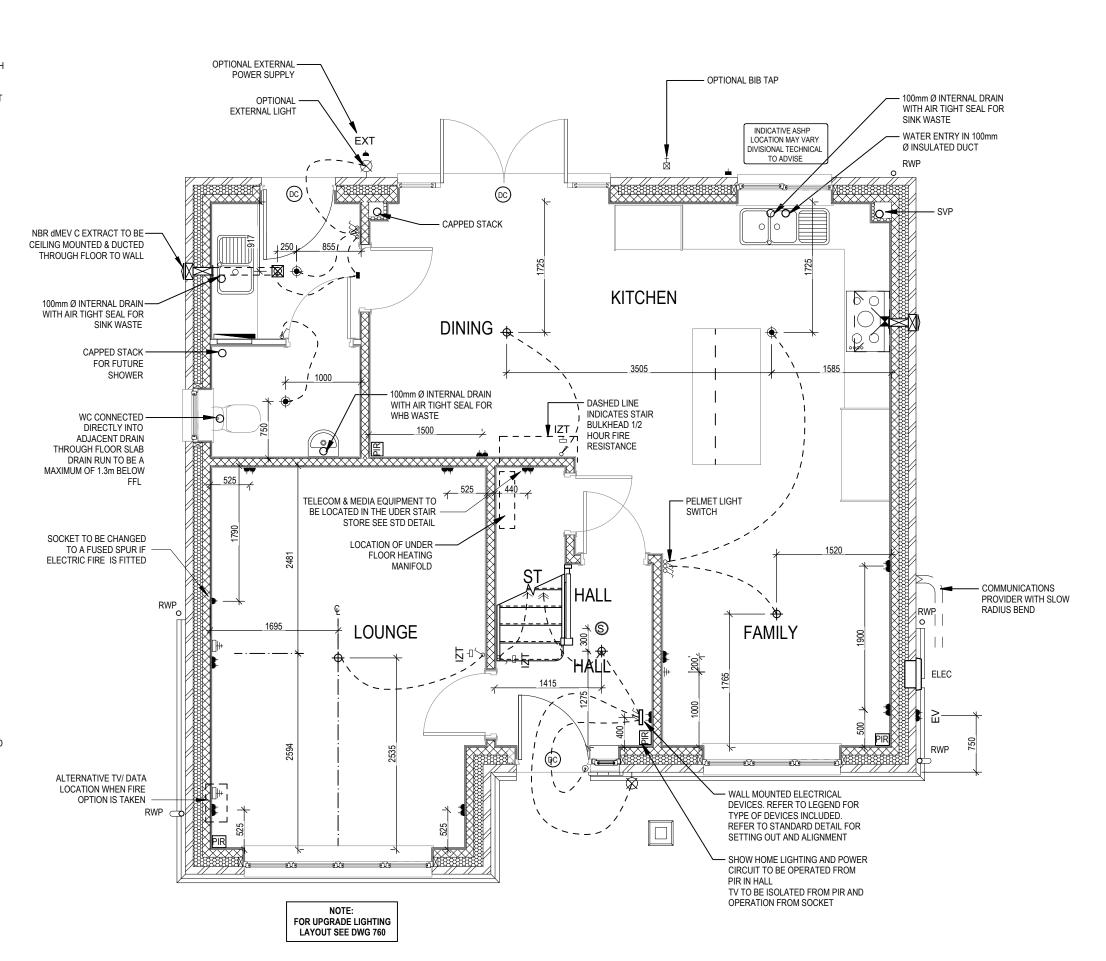

601 601 Dwg Rey Date Services Layo Ground Floor Highgate M4(2)

S N

**Scale** 1:50

Layout


- PENDANT TYPE LIGHT FITTING
- BATTEN HOLDER LIGHT FITTING
- SINGLE S/W SOCKET OUTLET (LOW LEVEL)
- DOUBLE S/W SOCKET OUTLET (FILLED AT LOW LEVEL, CLEAR AT HIGH
- USB 💈 DOUBLE S/W SOCKET OUTLET WITH DOUBLE USB SOCKET (FILLED AT USB ⊋ LOW LEVEL, CLEAR AT HIGH LEVEL)
- EV 🍍 ELECTRIC VEHICLE CHARGE POINT (SEE SITE SPECIFICATION)
- EXT -**4** EXTERNAL POWER SUPPLY (OPTIONAL)
  - -FUSED OUTLET (IMMERSION)
  - ISOLATOR SWITCH
- SINGLE SWITCH, DOUBLE SWITCH, TRIPLE SWITCH
- 88 NOTE: WHERE MULTIPLE SWITCHES ARE INDICATED TOGETHER 999 THESE ARE TO BE SWITCHED ON ONE SINGLE PLATE NOT ON
- COMBINED T.V., SATELLITE AND DATA POINT WITH OPTIONAL HIGH
- T.V. POINT WITH OPTIONAL DATA POINT AND OPTIONAL HIGH LEVEL
- OPTIONAL T.V. POINT WITH OPTIONAL DATA POINT AND OPTIONAL HIGH LEVEL MOUNT
- DATA POINT  $\Box$

S -□

- $\odot$ SMOKE DETECTOR
- $\oplus$ HEAT DETECTOR
- SHAVER SOCKET თ -(
- IZT -□ INDIVIDUAL ZONE THERMOSTAT
- PROGRAMMER AND HOT WATER TIMER
- PROGRAMMABLE THERMOSTAT PT ∄

ROOM THERMOSTAT

- EXTERNAL WALL LIGHT FITTING WITH INTEGRAL DUSK TO DAWN
- EXTERNAL SURFACE MOUNTED BULKHEAD LIGHT FITTING TO
- DOOR BELL PUSH BUTTON IN FRAME
- PV METER SWITCH (SITE UPGRADE/CUSTOMER OPTION)
- SEMI RECESSED CONSUMER UNIT
- DUSK TO DAWN SENSOR
- COMMS ENTRY POINT WITH SLOW RADIUS BEND
- COMBINATION WALL MOUNTED ELECTRICAL DEVICES (REFER TO STD
- CONSISTING
  - DOOR BELL CHIME
  - ALARM KEYPAD (CUSTOMER OPTION)
  - TRIPLE LIGHT SWITCH
- BANK OF SWITCHES
- PASSIVE INFRA-RED DETECTOR TO BE FITTED 2.4m MAX ABOVE FFL (CUSTOMER OPTION)
- DOOR CONTACT (CUSTOMER OPTION)

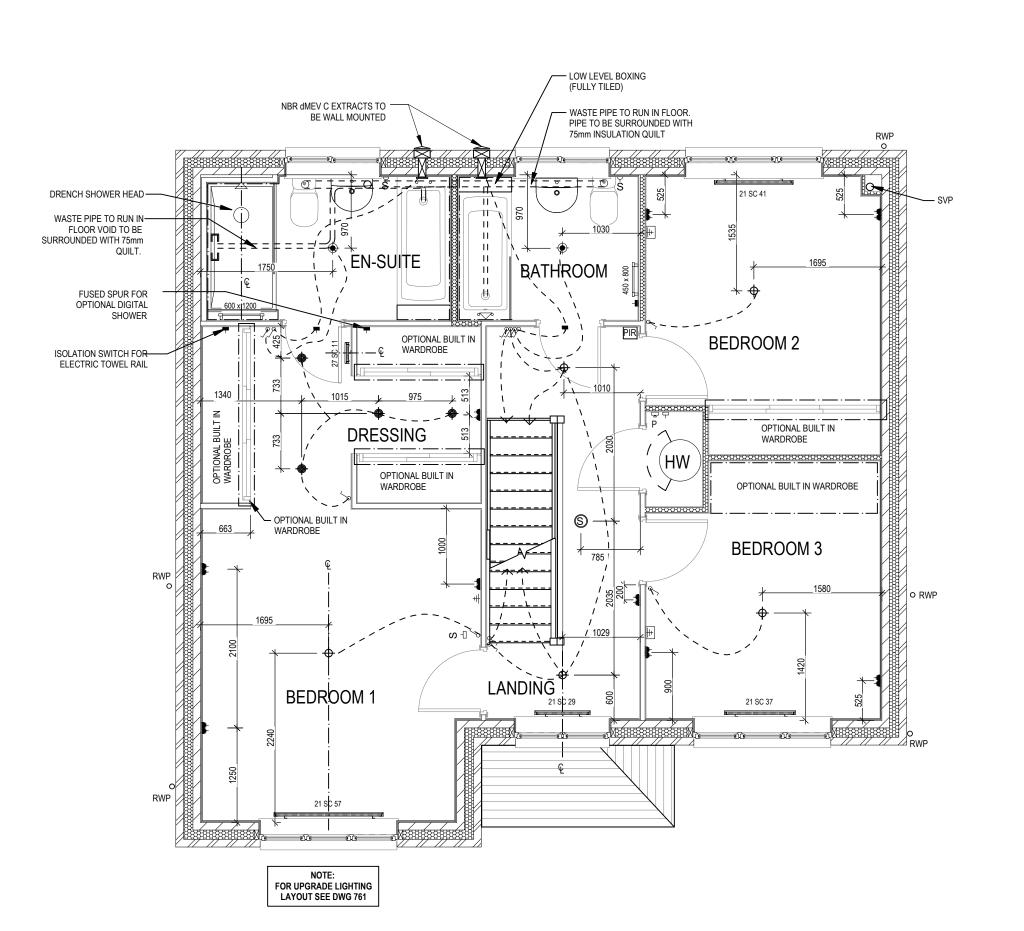

Services Layout First Floor

Highgate M4(2)

80


**Scale** 1:50

Date

- PENDANT TYPE LIGHT FITTING
- BATTEN HOLDER LIGHT FITTING
- SINGLE S/W SOCKET OUTLET (LOW LEVEL)
- DOUBLE S/W SOCKET OUTLET (FILLED AT LOW LEVEL, CLEAR AT HIGH
- USB 💈 DOUBLE S/W SOCKET OUTLET WITH DOUBLE USB SOCKET (FILLED AT LOW LEVEL, CLEAR AT HIGH LEVEL)
- USB ∹ ELECTRIC VEHICLE CHARGE POINT (SEE SITE SPECIFICATION)
- EV 💈
- EXT EXTERNAL POWER SUPPLY (OPTIONAL)
  - -[] FUSED OUTLET (IMMERSION)
  - ISOLATOR SWITCH
  - SINGLE SWITCH, DOUBLE SWITCH, TRIPLE SWITCH
- 88 NOTE: WHERE MULTIPLE SWITCHES ARE INDICATED TOGETHER THESE ARE TO BE SWITCHED ON ONE SINGLE PLATE NOT ON 888
- COMBINED T.V., SATELLITE AND DATA POINT WITH OPTIONAL HIGH
- T.V. POINT WITH OPTIONAL DATA POINT AND OPTIONAL HIGH LEVEL MOUNT
- OPTIONAL T.V. POINT WITH OPTIONAL DATA POINT AND OPTIONAL HIGH LEVEL MOUNT
- $\Box$ DATA POINT
- (S) SMOKE DETECTOR
- (H) HEAT DETECTOR
- SHAVER SOCKET
- ROOM THERMOSTAT
- INDIVIDUAL ZONE THERMOSTAT
- PROGRAMMER AND HOT WATER TIMER
- PROGRAMMABLE THERMOSTAT
- EXTERNAL WALL LIGHT FITTING WITH INTEGRAL DUSK TO DAWN
- EXTERNAL SURFACE MOUNTED BULKHEAD LIGHT FITTING TO 0
- DOOR BELL PUSH BUTTON IN FRAME
- PV METER SWITCH (SITE UPGRADE/CUSTOMER OPTION)
- SEMI RECESSED CONSUMER UNIT DUSK TO DAWN SENSOR
- COMMS ENTRY POINT WITH SLOW RADIUS BEND
- COMBINATION WALL MOUNTED ELECTRICAL DEVICES (REFER TO STD DETAIL).
  - CONSISTING:

 $\triangleleft$ 

- DOOR BELL CHIME
- ALARM KEYPAD (CUSTOMER OPTION) - TRIPLE LIGHT SWITCH
- BANK OF SWITCHES
- PASSIVE INFRA-RED DETECTOR TO BE FITTED 2.4m MAX ABOVE FFL
- DOOR CONTACT (CUSTOMER OPTION)
- JUNCTION BOX (IF REQUIRED)

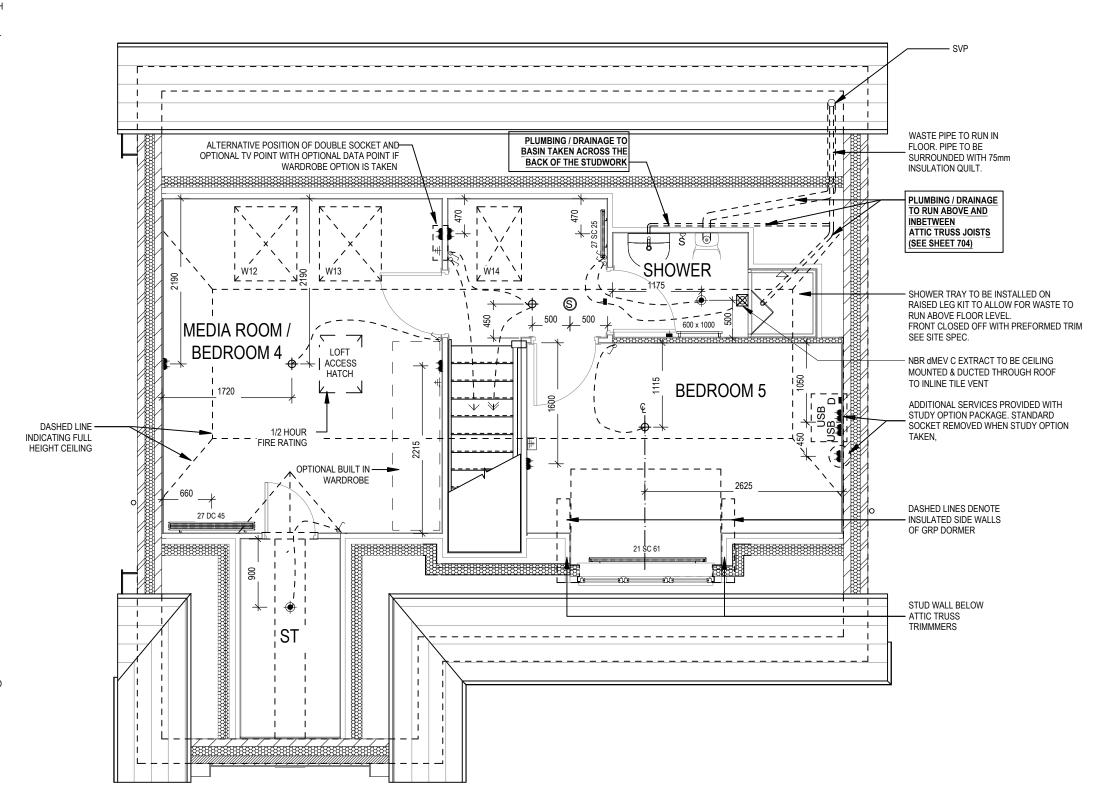

**603**Dwg Rev Date Services Floor M4(2) ate **Highg** 

S N

**Scale** 1:50


Second

Layout

## **CLOAKS LAYOUT**

Scale: 1:50

Scale: 1:20

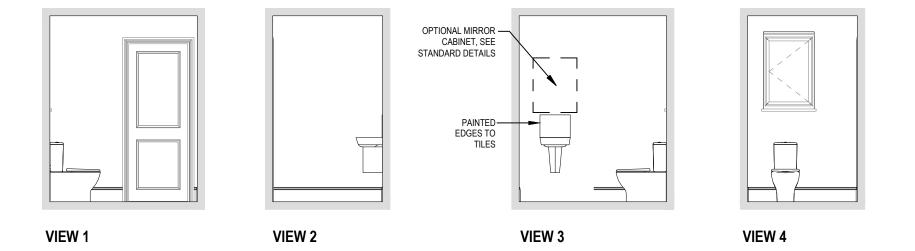

**ELECTRICAL LEGEND** 

FUSED OUTLET (BOILER, IMMERSION)

ISOLATOR SWITCH

UFH OPTIONAL ELECTRIC UNDER FLOOR HEATING WITH CONTROLLER AND STAT

SINGLE SWITCH

88 DOUBLE SWITCH

TRIPLE SWITCH

NOTE: WHERE MULTIPLE SWITCHES ARE INDICATED TOGETHER THESE ARE TO BE SWITCHED ON ONE SINGLE PLATE NOT ON MULTIPLE PLATES.

SHAVER SOCKET

OPTIONAL DIGITAL SHOWER SWITCH

Dwg No 701 Dwg Rev

of Brick/Block & Studwork. This drawing is subject to copyright law. Do Not Scale Off This Dra

82


**Cloaks Details** 

Highgate M4(2)

- FUSED OUTLET (BOILER, IMMERSION)
- ISOLATOR SWITCH
- OPTIONAL ELECTRIC UNDER FLOOR HEATING WITH CONTROLLER AND STAT UFH **4**
- SINGLE SWITCH
- 88 DOUBLE SWITCH
- TRIPLE SWITCH


NOTE: WHERE MULTIPLE SWITCHES ARE INDICATED TOGETHER THESE ARE TO BE SWITCHED ON ONE SINGLE PLATE NOT ON MULTIPLE PLATES.

- S SHAVER SOCKET
- OPTIONAL DIGITAL SHOWER SWITCH

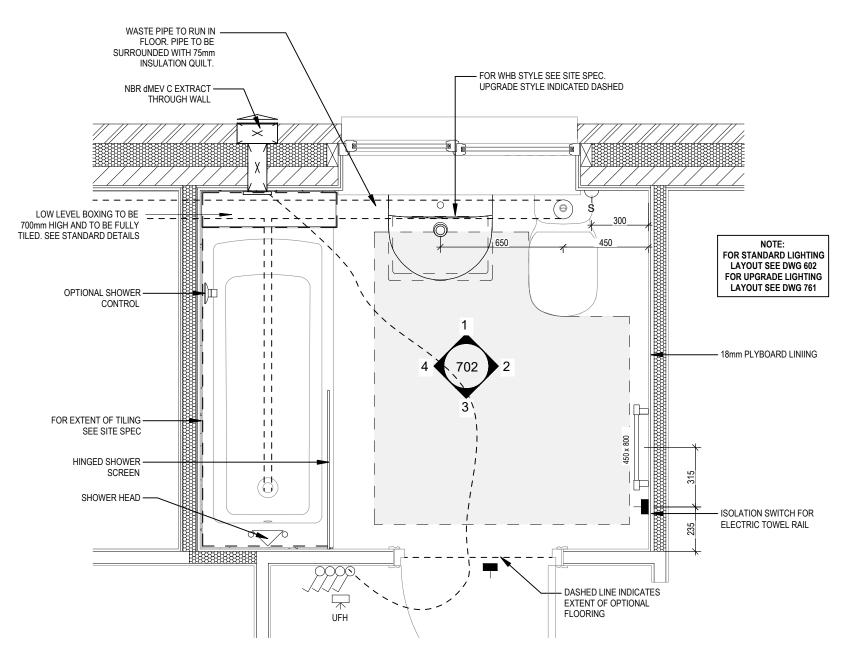



#### **BATHROOM LAYOUT**


Scale: 1:20

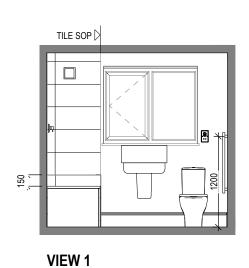

Scale: 1:50

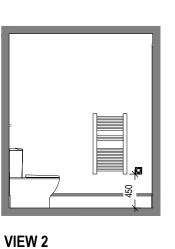

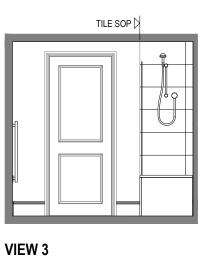

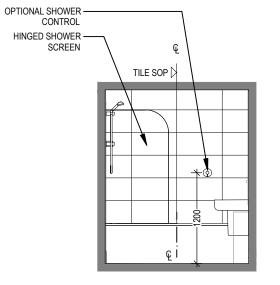


VIEW 4

Highgate M4(2)


702 702 Dwg Rev

S<sub>N</sub>

**Bathroom Details** 

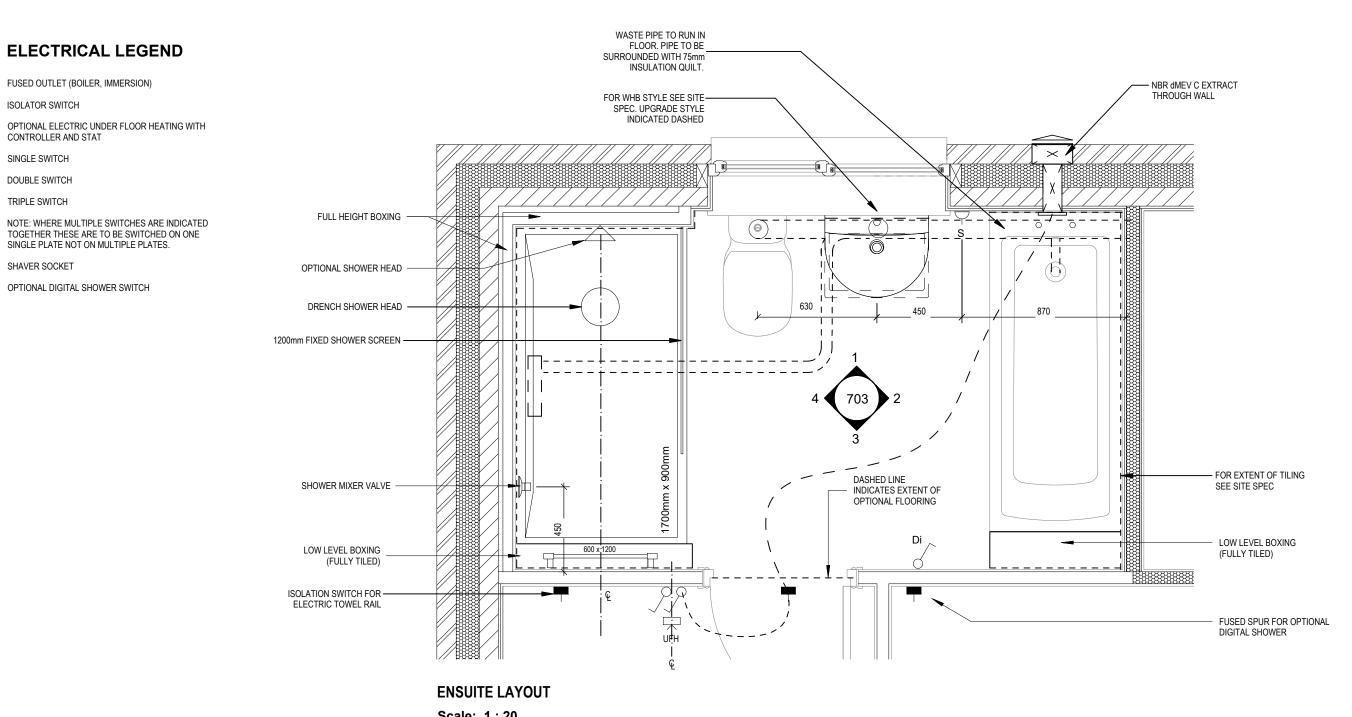

Scale: 1:20

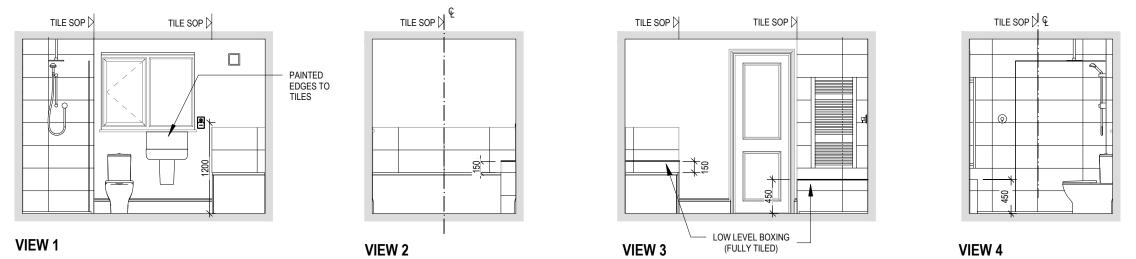

Scale: 1:50


99

999


Dwg No 703 Dwg Rev Highgate M4(2)

80

**Ensuite Details** 

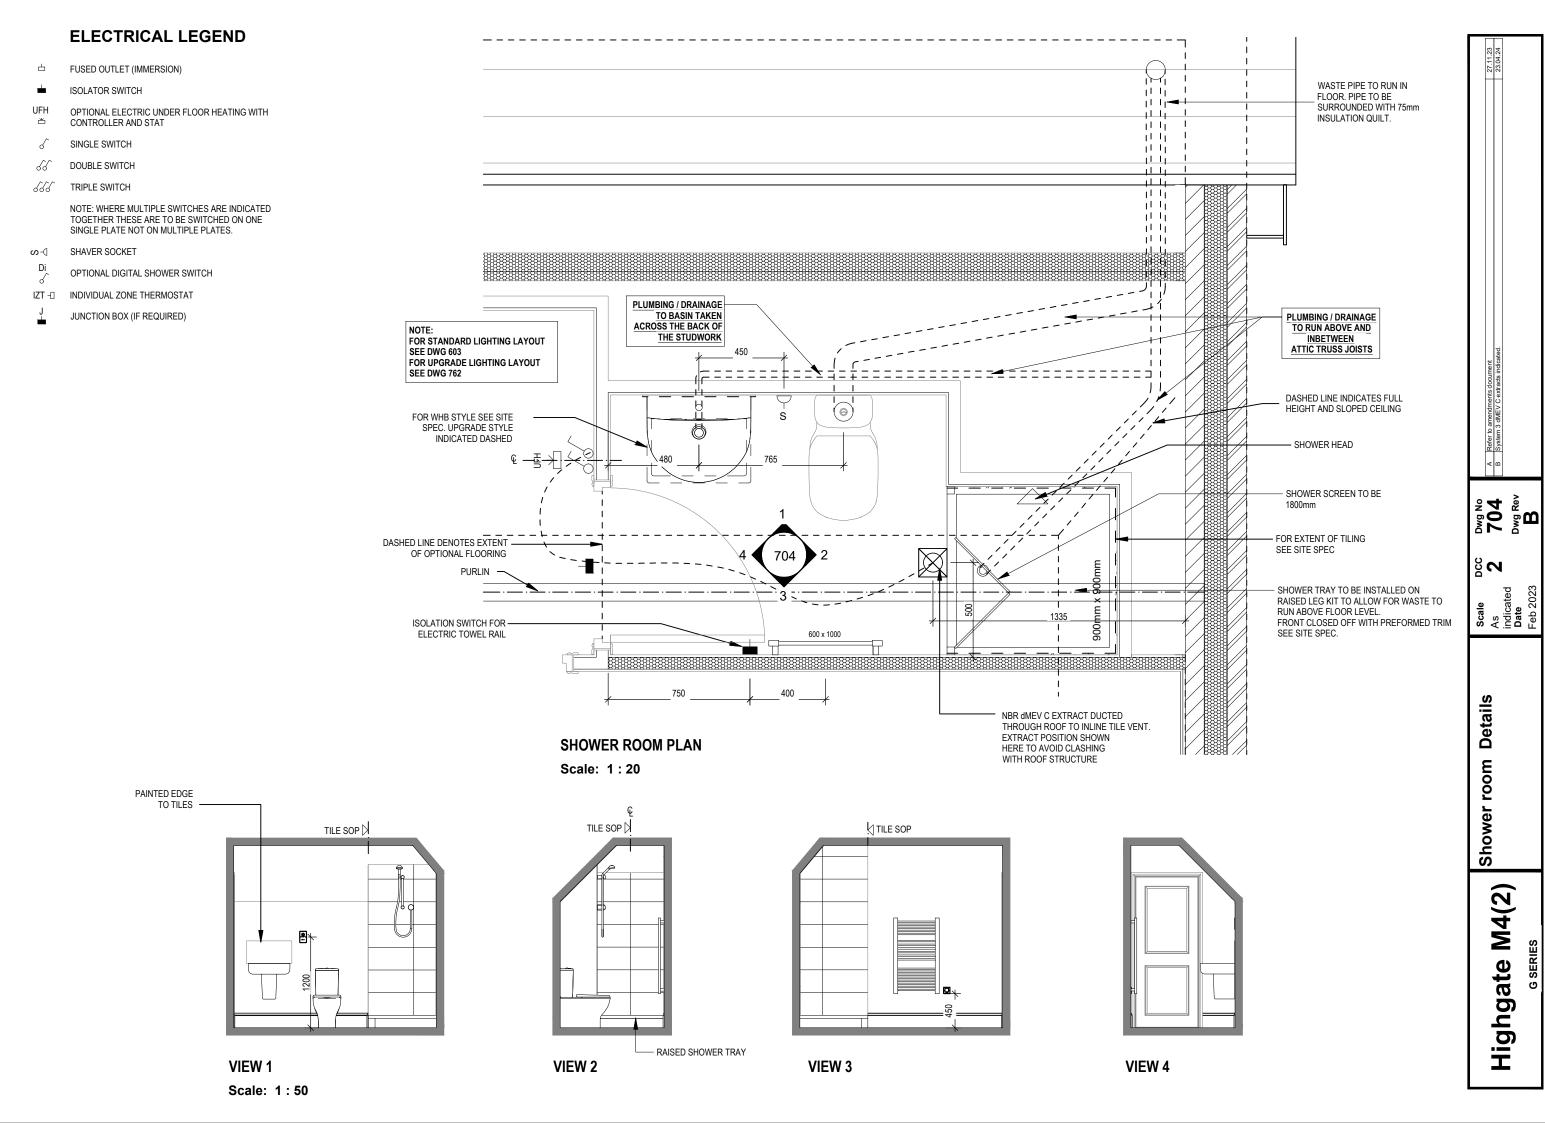

law. Do Not \$

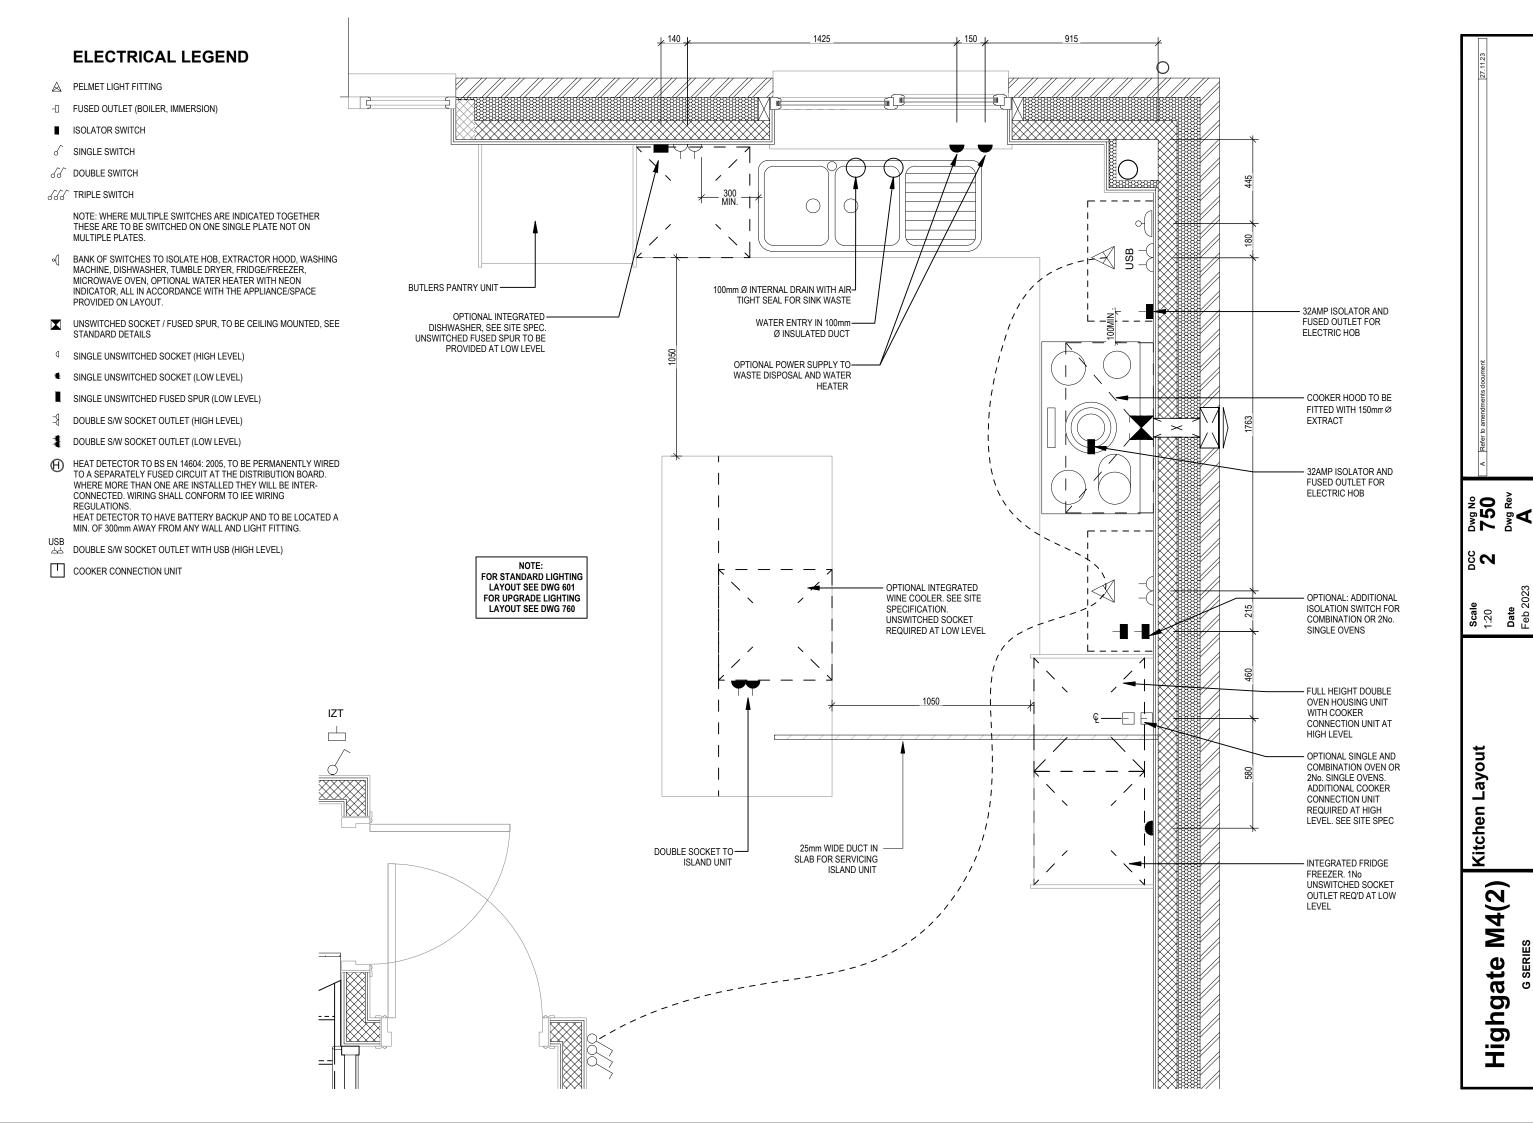


- A PELMET LIGHT FITTING
- FUSED OUTLET (BOILER, IMMERSION)
- ISOLATOR SWITCH
- SINGLE SWITCH
- S DOUBLE SWITCH
- STATE SWITCH

NOTE: WHERE MULTIPLE SWITCHES ARE INDICATED TOGETHER THESE ARE TO BE SWITCHED ON ONE SINGLE PLATE NOT ON MULTIPLE PLATES.

- o() BANK OF SWITCHES TO ISOLATE HOB, EXTRACTOR HOOD, WASHING MACHINE, DISHWASHER, TUMBLE DRYER, FRIDGE/FREEZER, MICROWAYE OVEN, OPTIONAL WATER HEATER WITH NEON INDICATOR, ALL IN ACCORDANCE WITH THE APPLIANCE/SPACE PROVIDED ON LAYOUT.
- UNSWITCHED SOCKET / FUSED SPUR, TO BE CEILING MOUNTED, SEE STANDARD DETAILS
- SINGLE UNSWITCHED SOCKET (HIGH LEVEL)
- SINGLE UNSWITCHED SOCKET (LOW LEVEL)
- SINGLE UNSWITCHED FUSED SPUR (LOW LEVEL)
- DOUBLE S/W SOCKET OUTLET (HIGH LEVEL)
- DOUBLE S/W SOCKET OUTLET (LOW LEVEL)
- HEAT DETECTOR TO BS EN 14604: 2005, TO BE PERMANENTLY WIRED TO A SEPARATELY FUSED CIRCUIT AT THE DISTRIBUTION BOARD. WHERE MORE THAN ONE ARE INSTALLED THEY WILL BE INTERCONNECTED. WIRING SHALL CONFORM TO IEE WIRING REGULATIONS.

  HEAT DETECTOR TO HAVE BATTERY BACKUP AND TO BE LOCATED A MIN. OF 300mm AWAY FROM ANY WALL AND LIGHT FITTING.
- DOUBLE S/W SOCKET OUTLET WITH USB (HIGH LEVEL)
- COOKER CONNECTION UNIT

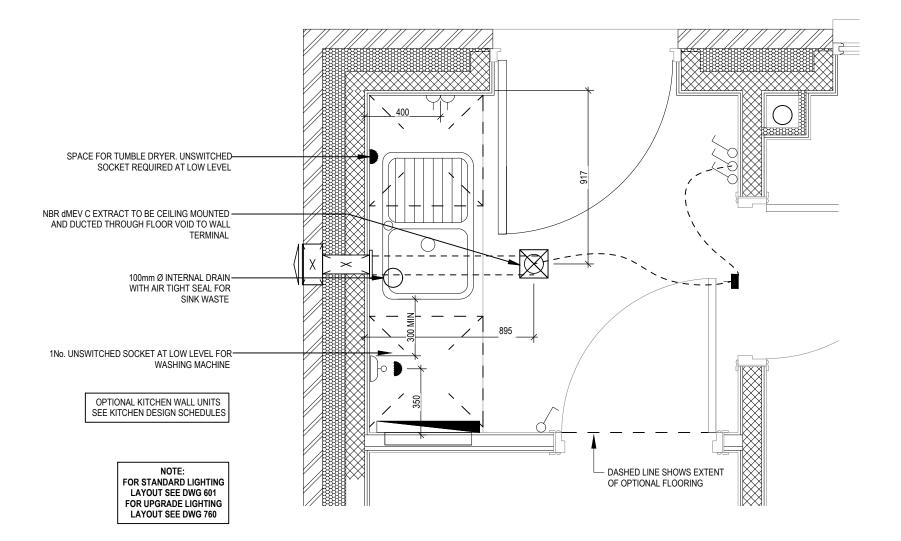


Dwg No 751 Dwg Rev 80 **Scale** 1:20 **Date** Feb 2 **Utility Layout** Highgate M4(2)


OPTIONAL LOW VOLTAGE DOWNLIGHTER FITTING

SINGLE SWITCH

O DOUBLE SWITCH

√√√ TRIPLE SWITCH

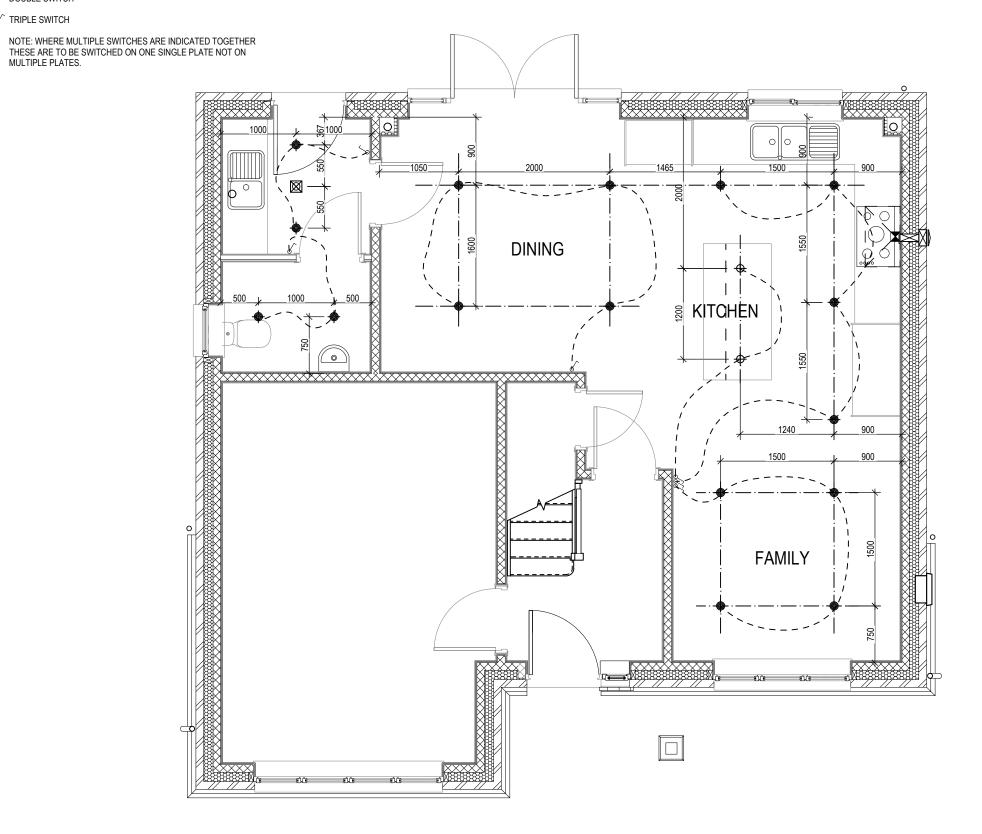

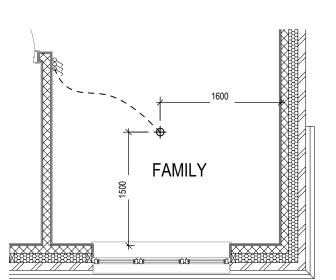

**SHOW HOME LIGHTING LAYOUT** 


Dwg No 760 Dwg Rev Optional Lighting Layout Ground Floor

**7** 

Highgate M4(2)

- OPTIONAL LOW VOLTAGE DOWNLIGHTER FITTING
- SINGLE SWITCH
- SO DOUBLE SWITCH
- SSS TRIPLE SWITCH

NOTE: WHERE MULTIPLE SWITCHES ARE INDICATED TOGETHER THESE ARE TO BE SWITCHED ON ONE SINGLE PLATE NOT ON MULTIPLE PLATES.

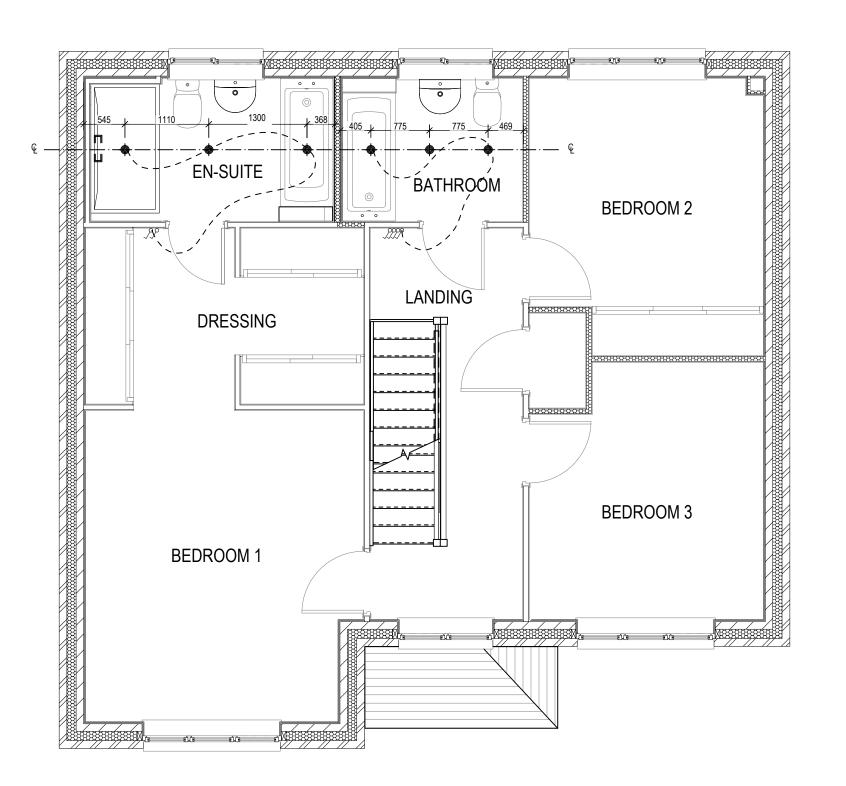

Dwg No 761 Dwg Rev Optional Lighting Layout First Floor Highgate M4(2)

**7** 


OPTIONAL LOW VOLTAGE DOWNLIGHTER FITTING

SINGLE SWITCH

SS DOUBLE SWITCH

SSS TRIPLE SWITCH

NOTE: WHERE MULTIPLE SWITCHES ARE INDICATED TOGETHER THESE ARE TO BE SWITCHED ON ONE SINGLE PLATE NOT ON

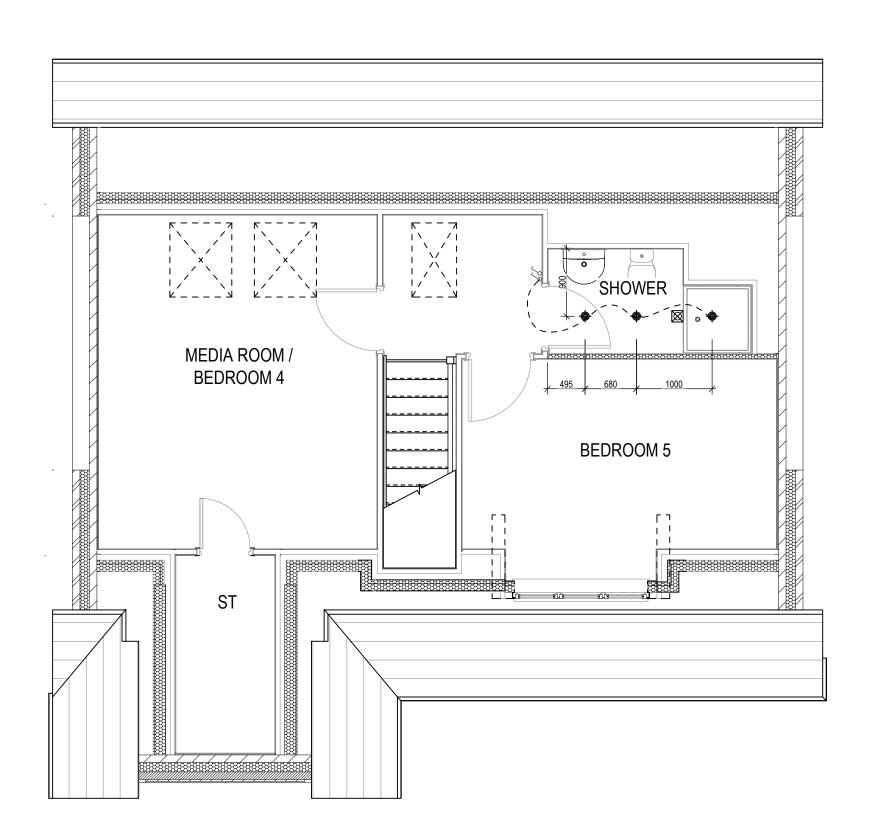

Dwg No 762 Dwg Rev A

Optional Lighting Layout Second Floor

**7** 

Highgate M4(2)

Highgate M4(2)

Porch Canopy

200 **Date** Feb 2023

Bwg No **801** Dwg Rev