

Harrogate M4(2)

2544G\_HARR\_DM.1.A 2544G\_HARC\_DM.1.A


ARCH REF: 1553 ft<sup>2</sup>

144.29 m<sup>2</sup>

SQ M:

SQFE

**G SERIES** 

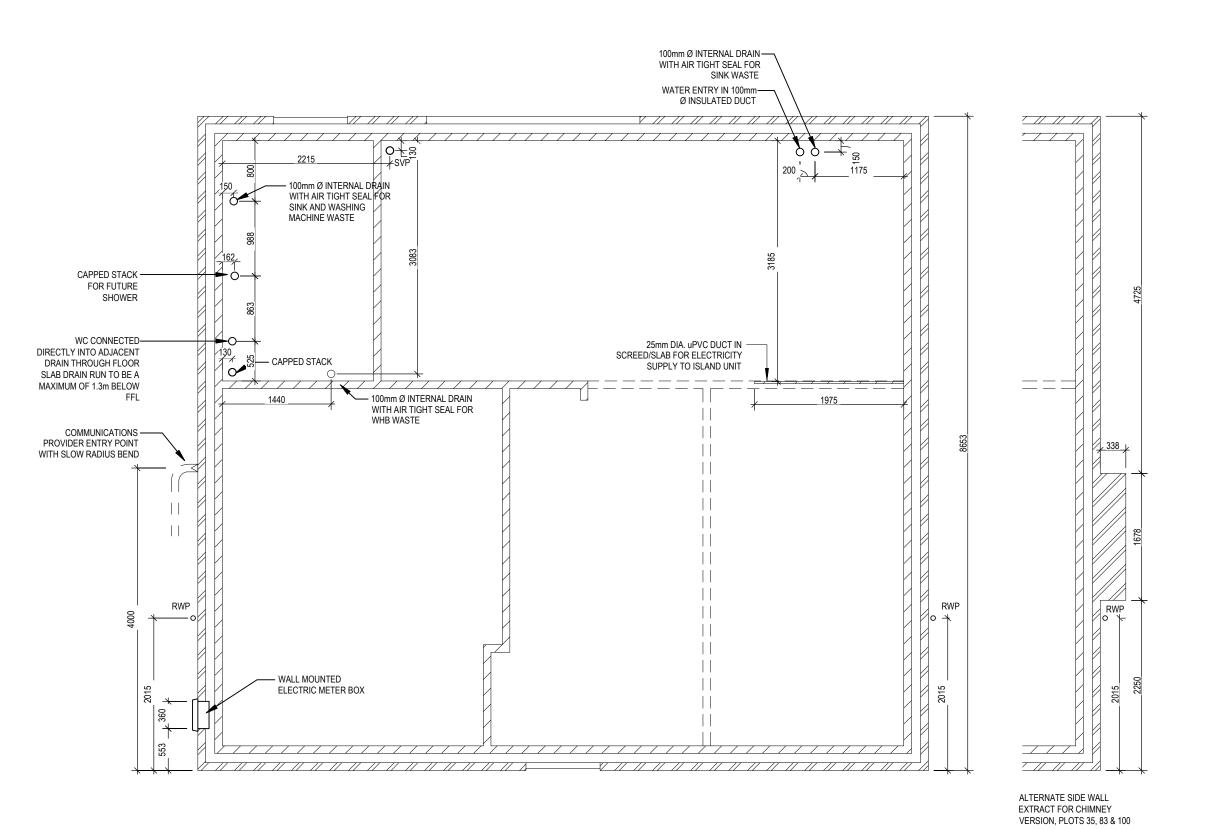


Harrogate M4(2)

Slab Penetration Layout

200 **Scale** 1 : 50

Dwg No 160 Dwg Rev

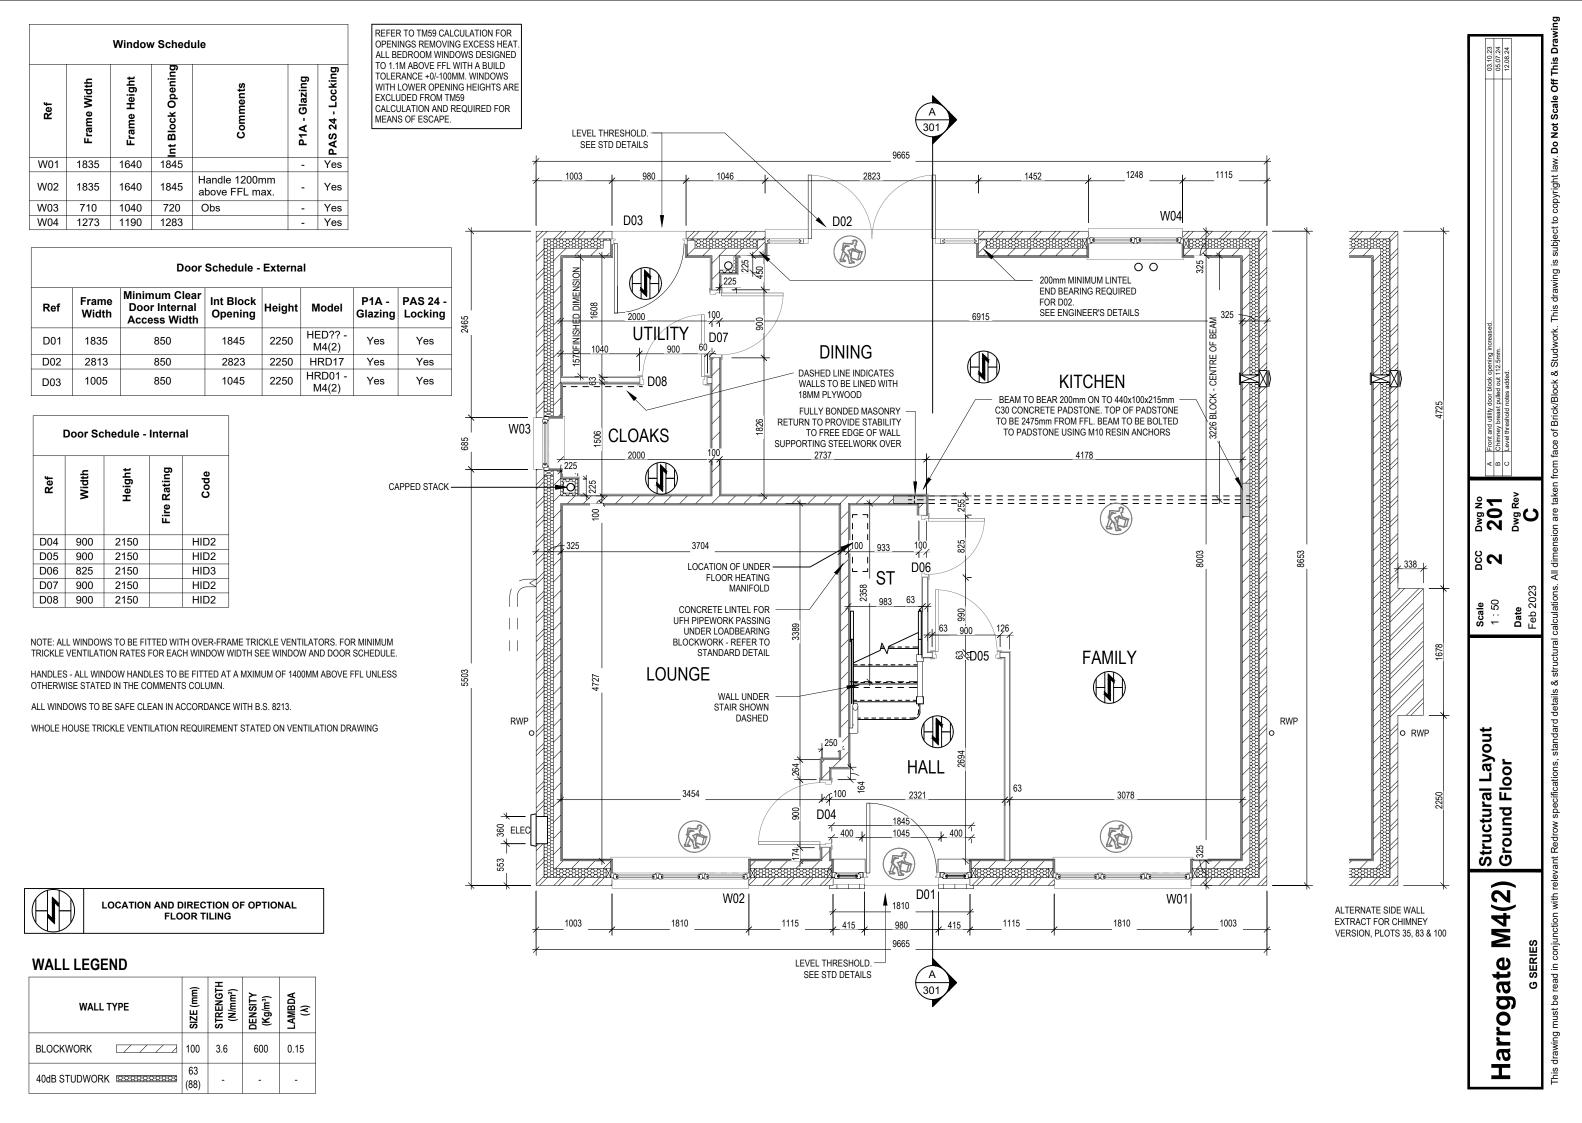

Window Schedule								
Ref	Frame Width	Frame Height	Int Block Opening	Comments	P1A - Glazing	PAS 24 - Locking		
W05	1835	1040	1845	Esc	-	-		
W06	1160	890	1170		-	-		
W07	1835	1040	1845	Esc	-	-		
W08	1835	1040	1845	Esc	-			
W09	1273	1040	1283	Obs	-	-		
W10	1835	1040	1845	Esc	-	-		
W11	710	1040	720	Plots 35, 83, 100 only	-	-		

REFER TO TM59 CALCULATION FOR OPENINGS REMOVING EXCESS HEAT ALL BEDROOM WINDOWS DESIGNED TO 1.1M ABOVE FFL WITH A BUILD

Ref	Frame Width	Frame Height	Int Block Opening	Comments	P1A - Glazing	PAS 24 - Locking
W05	1835	1040	1845	Esc	-	-
W06	1160	890	1170		-	-
W07	1835	1040	1845	Esc	-	-
W08	1835	1040	1845	Esc	-	-
W09	1273	1040	1283	Obs	-	-
W10	1835	1040	1845	Esc	-	-
W11	710	1040	720	Plots 35, 83, 100	-	-


Door Schedule - Internal					
Ref	Width	Height	Fire Rating	Code	
D09	900	2150		HID2	
D10	900	2150		HID2	
D11	900	2150		HID2	
D12	825	2150		HID3	
D13	900	2150		HID2	
D14	900	2150		HID2	
D15	825	2150		HID3	

NOTE: ALL WINDOWS TO BE FITTED WITH OVER-FRAME TRICKLE VENTILATORS. FOR MINIMUM TRICKLE VENTILATION RATES FOR EACH WINDOW WIDTH SEE WINDOW AND DOOR SCHEDULE.

HANDLES - ALL WINDOW HANDLES TO BE FITTED AT A MXIMUM OF 1400MM ABOVE FFL UNLESS OTHERWISE STATED IN THE COMMENTS COLUMN.

ALL WINDOWS TO BE SAFE CLEAN IN ACCORDANCE WITH B.S. 8213.

WHOLE HOUSE TRICKLE VENTILATION REQUIREMENT STATED ON VENTILATION DRAWING

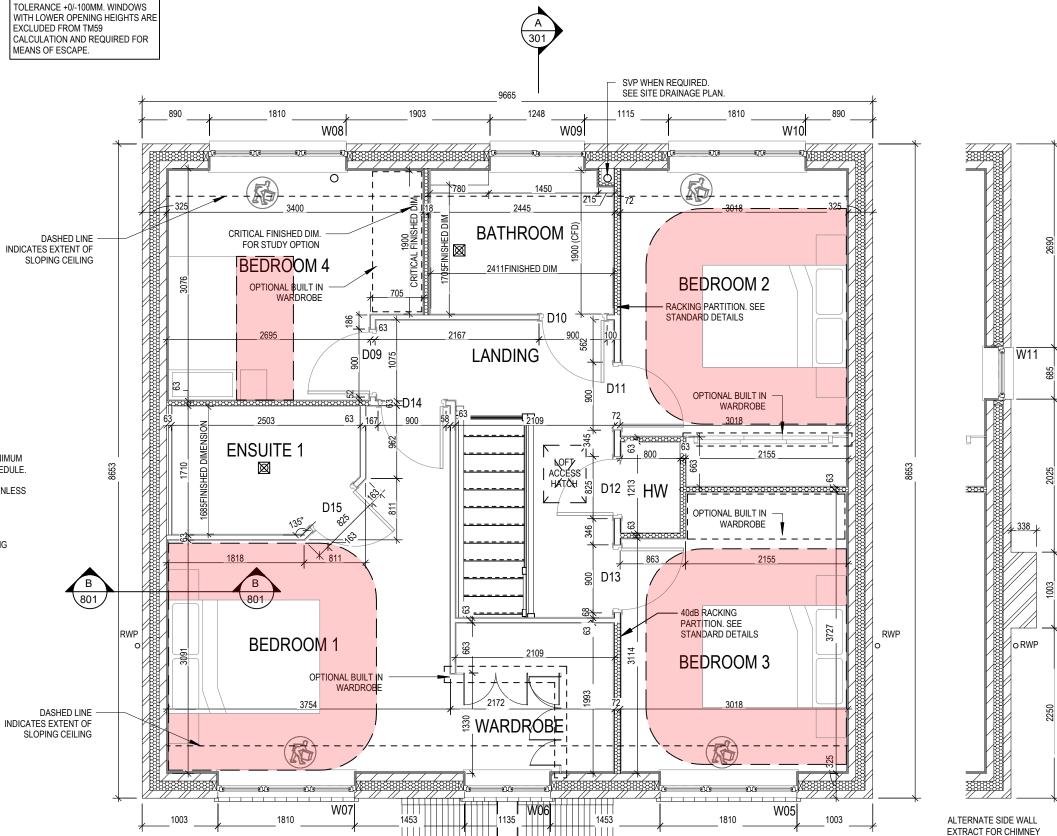

# **WALL LEGEND**

WALL TYPE	SIZE (mm)	STRENGTH (N/mm²)	DENSITY (Kg/m³)	LAMBDA (A)
BLOCKWORK	100	3.6	600	0.15
40dB STUDWORK	63 (88)	-	-	-

Structural Layout First Floor M4(2)

VERSION, PLOTS 35, 83 & 100


Harrogate

**Date** Feb :

202 202 Dwg Rev

80

**Scale** 1:50

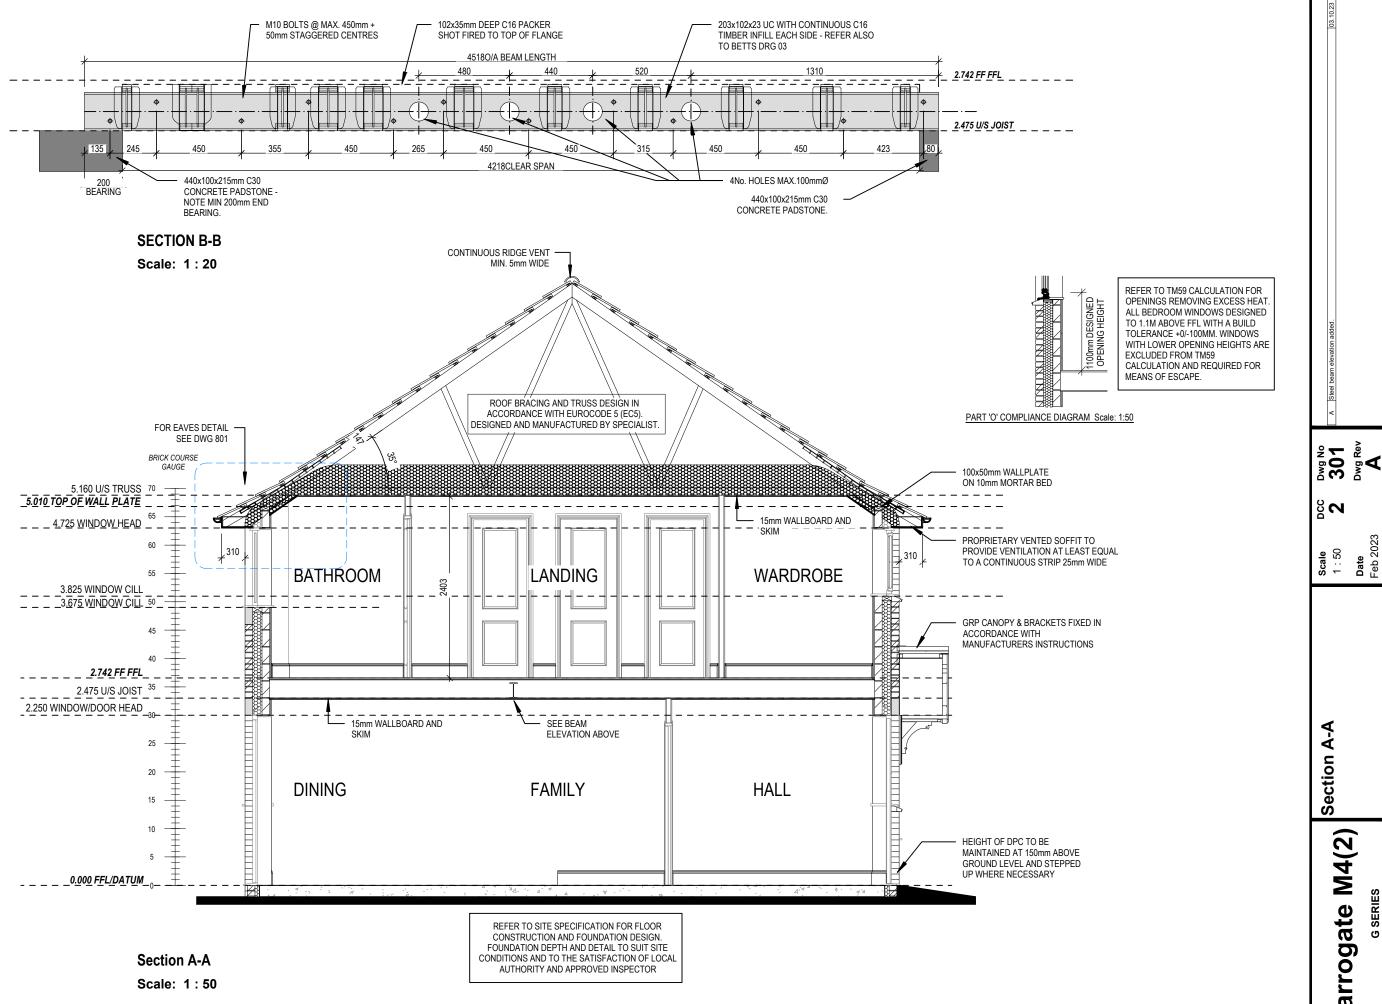


**Date** Feb 2

Section A-A

arrogate M4(2)

I

REFER TO TM59 CALCULATION FOR OPENINGS REMOVING EXCESS HEAT. ALL BEDROOM WINDOWS DESIGNED TO 1.1M ABOVE FFL WITH A BUILD TOLERANCE +0/-100MM. WINDOWS WITH LOWER OPENING HEIGHTS ARE EXCLUDED FROM TM59 CALCULATION AND REQUIRED FOR MEANS OF ESCAPE.

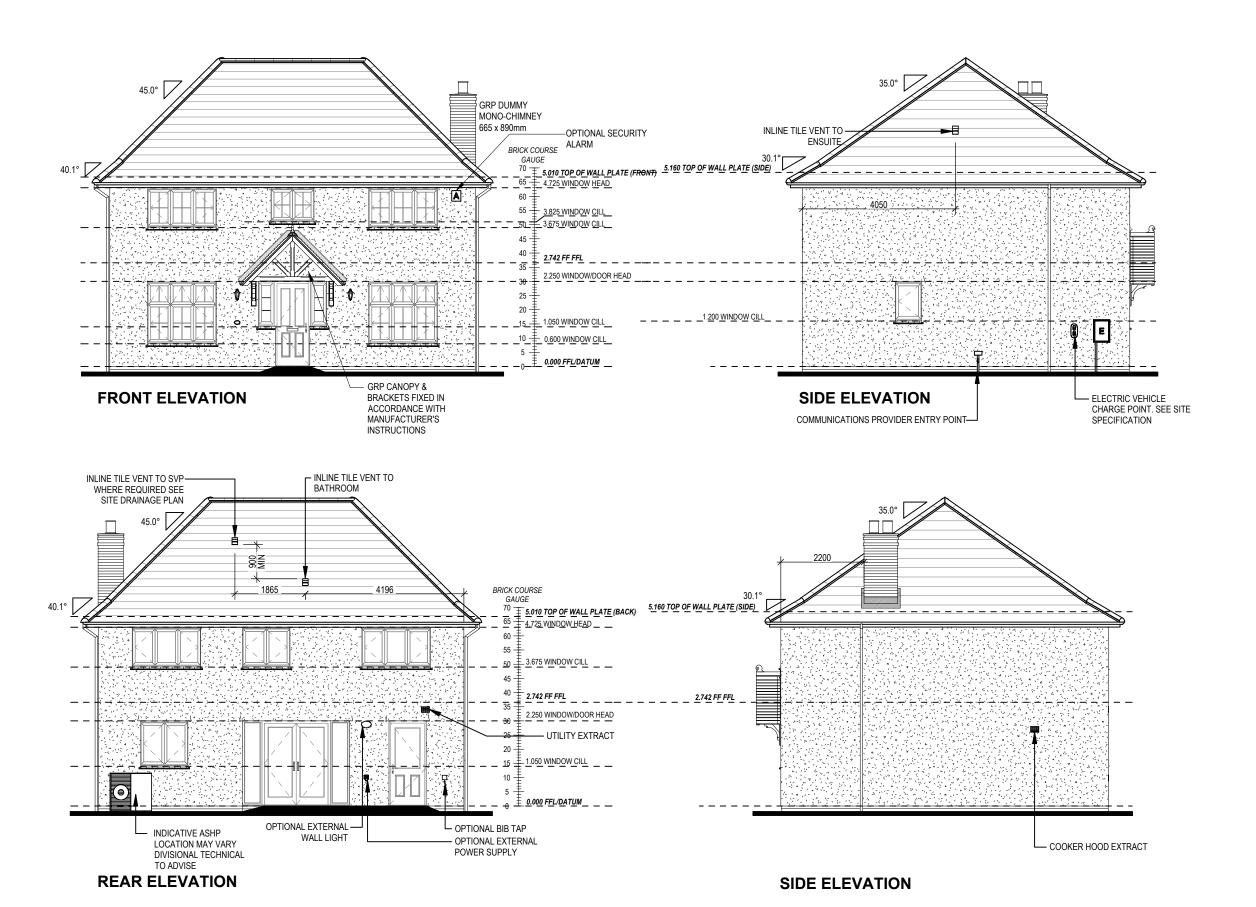

Do Not

Elevations A1


**402** Dwg Rev


80

Harrogate M4(2)

REFER TO TM59 CALCULATION FOR OPENINGS REMOVING EXCESS HEAT. ALL BEDROOM WINDOWS DESIGNED TO 1.1M ABOVE FFL WITH A BUILD TOLERANCE +0/-100MM. WINDOWS WITH LOWER OPENING HEIGHTS ARE EXCLUDED FROM TM59 CALCULATION AND REQUIRED FOR MEANS OF ESCAPE.

**REAR ELEVATION** 

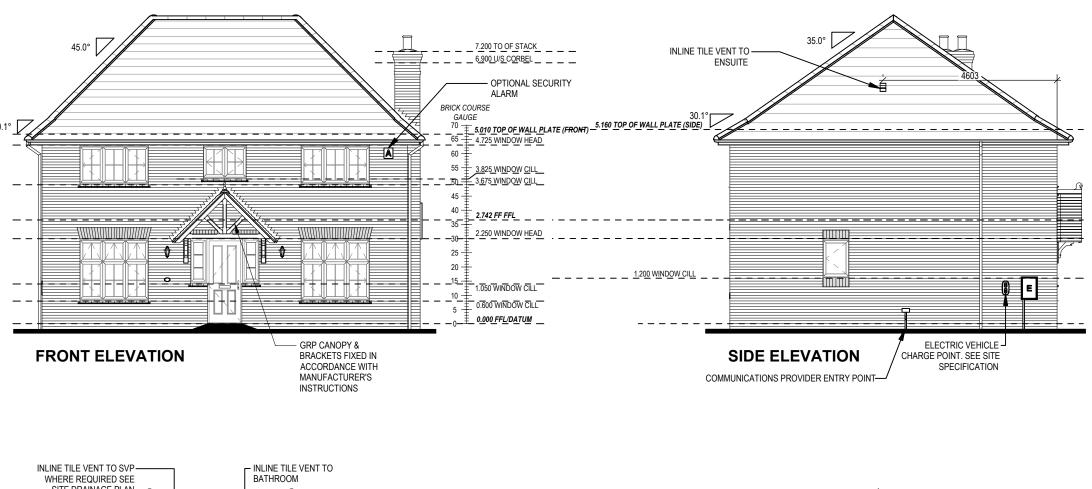

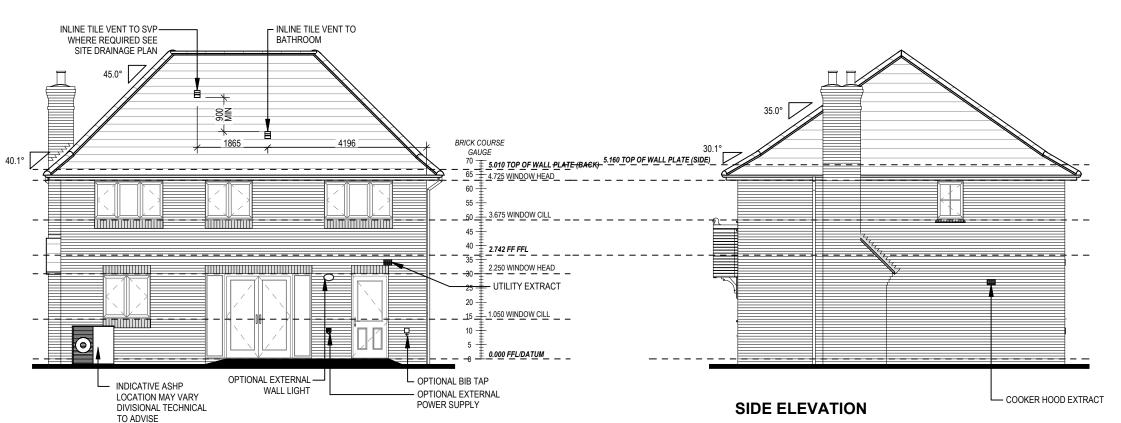


Harrogate M4(2)

Elevations B2 Chimney Version

Do Not

Dwg No **403** Dwg Rev

S<sub>N</sub>

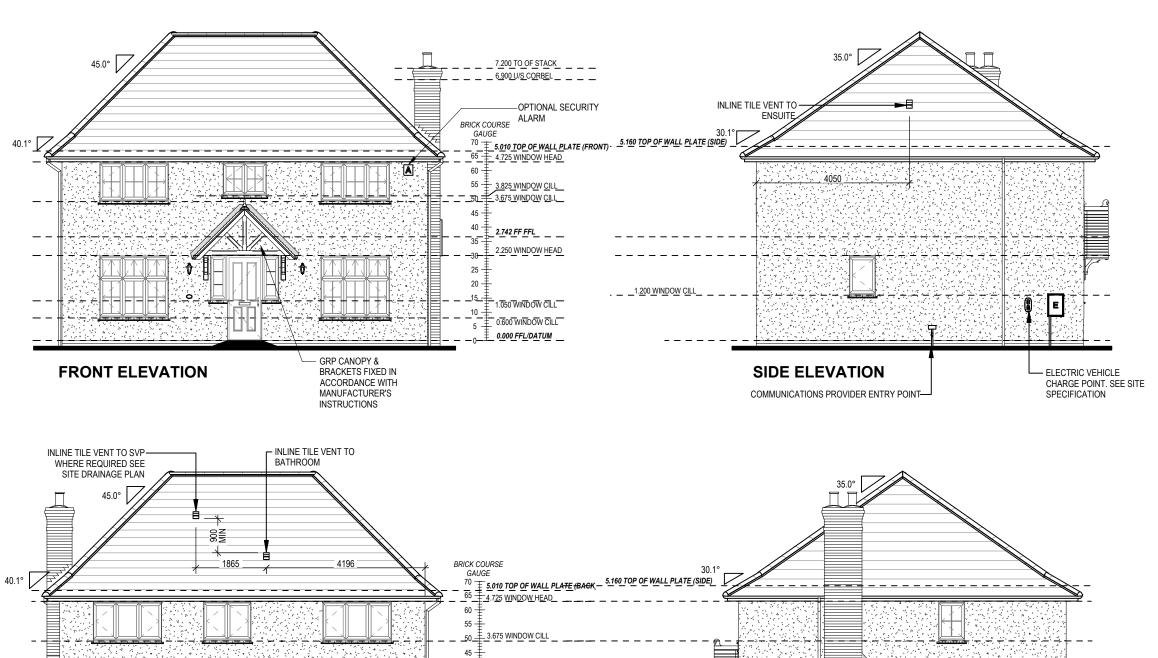

2.742 FF FFL
2.250 WINDOW HEAD
UTILITY EXTRACT

1.050 WINDOW CILL

<u> 0.000 FFL/DATUM \_\_\_\_</u>

C OPTIONAL BIB TAP

POWER SUPPLY

- OPTIONAL EXTERNAL

OPTIONAL EXTERNAL

WALL LIGHT

INDICATIVE ASHP

LOCATION MAY VARY

DIVISIONAL TECHNICAL TO ADVISE

REAR ELEVATION

COOKER HOOD EXTRACT

SIDE ELEVATION


Harrogate M4(2) Chimney Version

Dwg No **404** Dwg Rev

> **Date** Feb 2023

80


Do Not

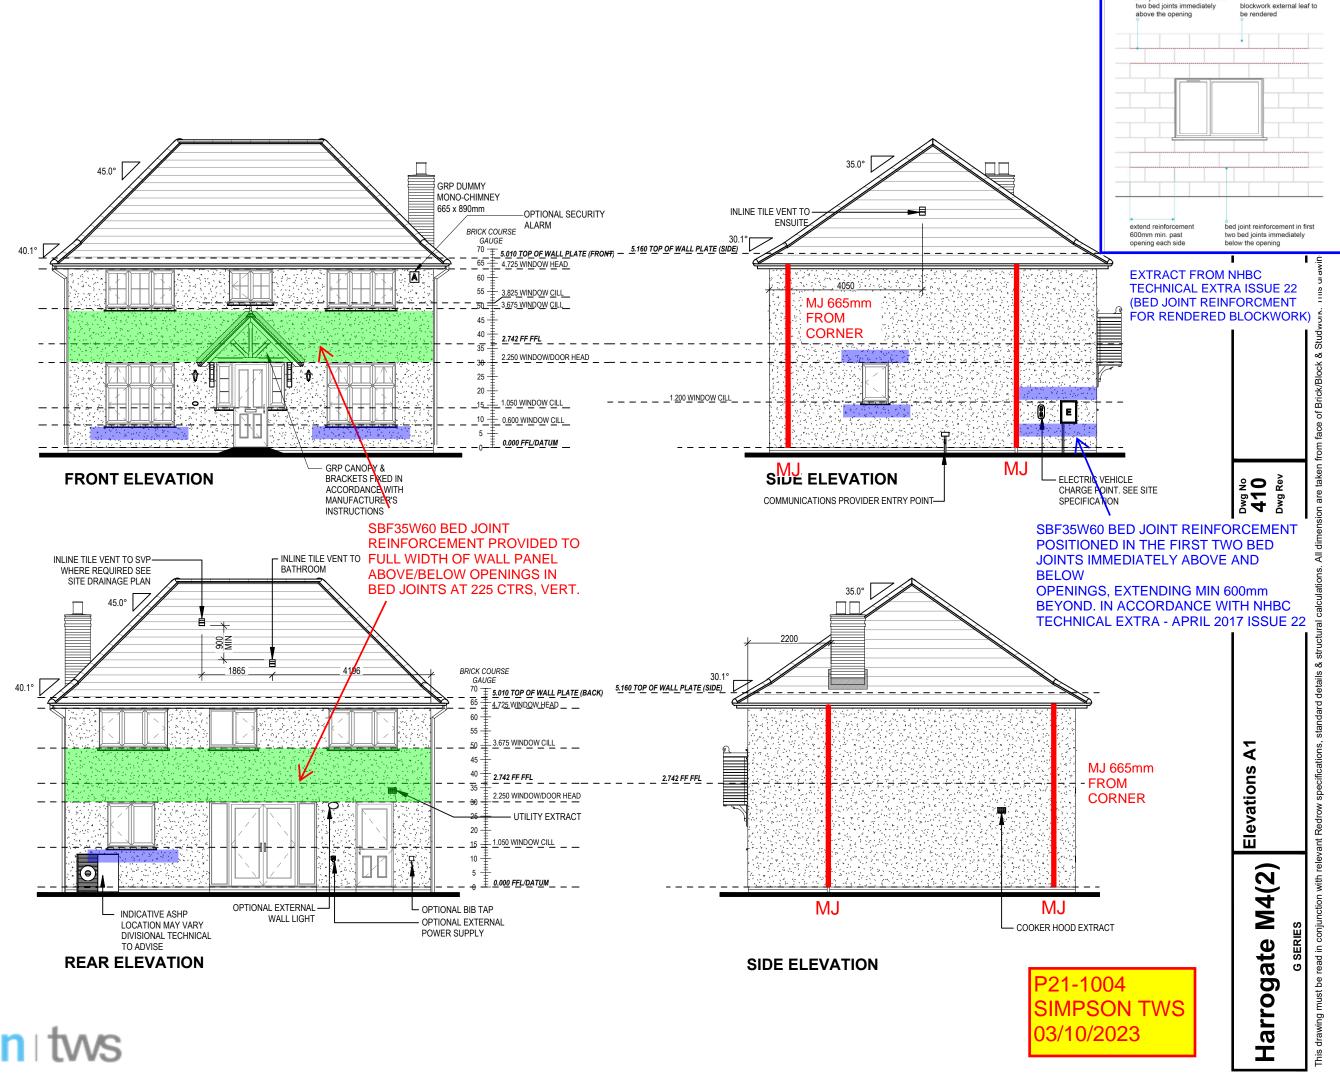

bed joint reinforcement in first






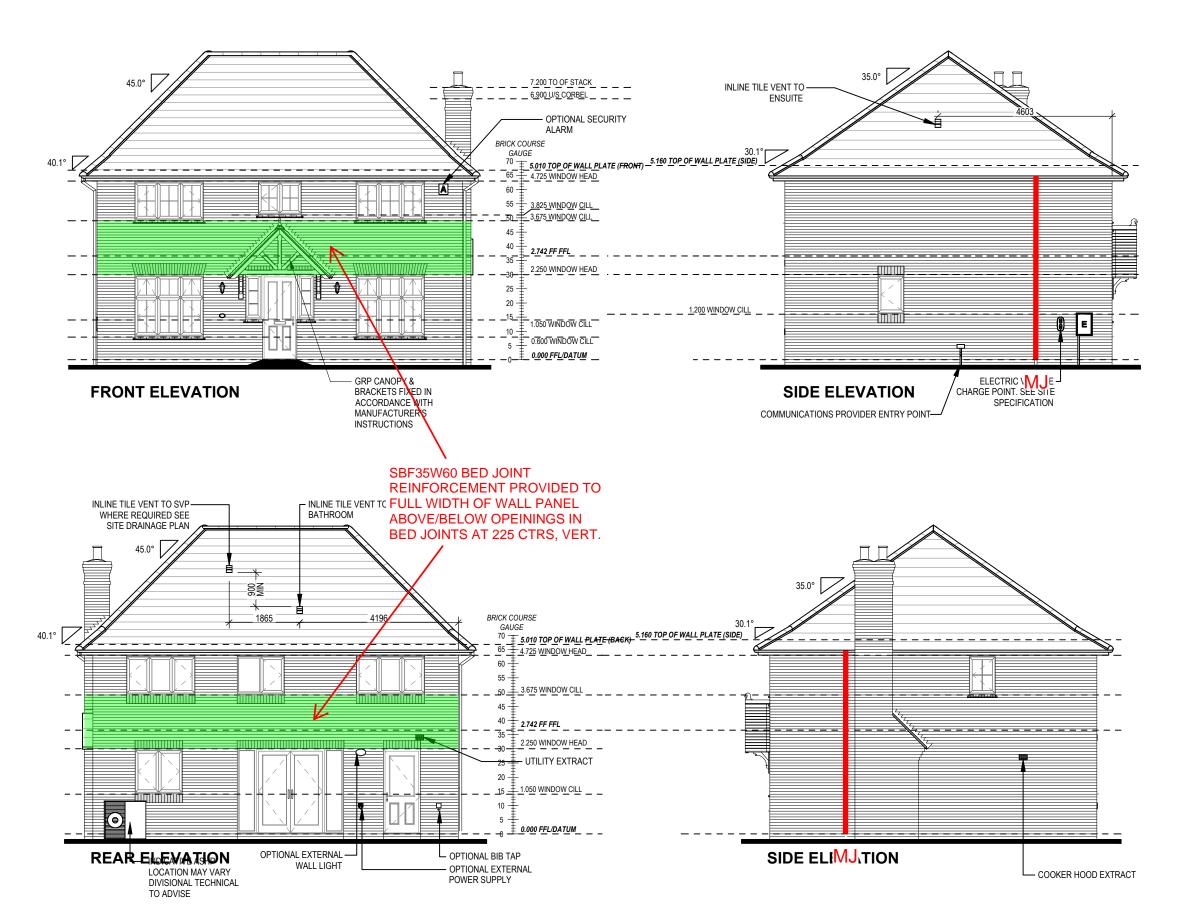


Harrogate M4(2)

Elevations B2 Chimney Version

Dwg No **411** Dwg Rev 80

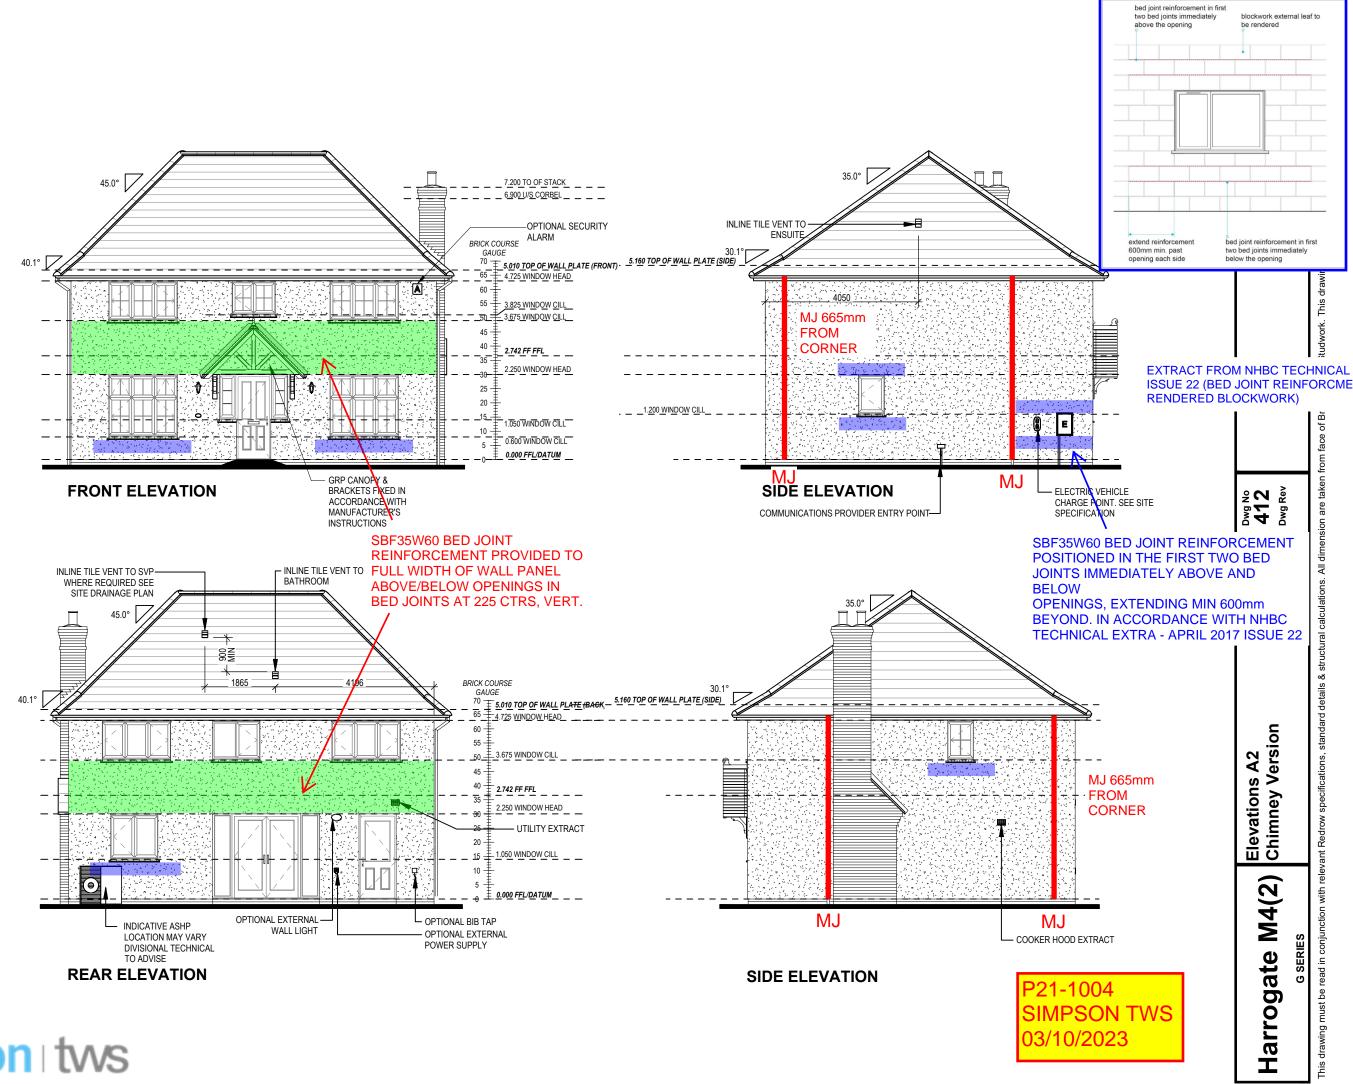



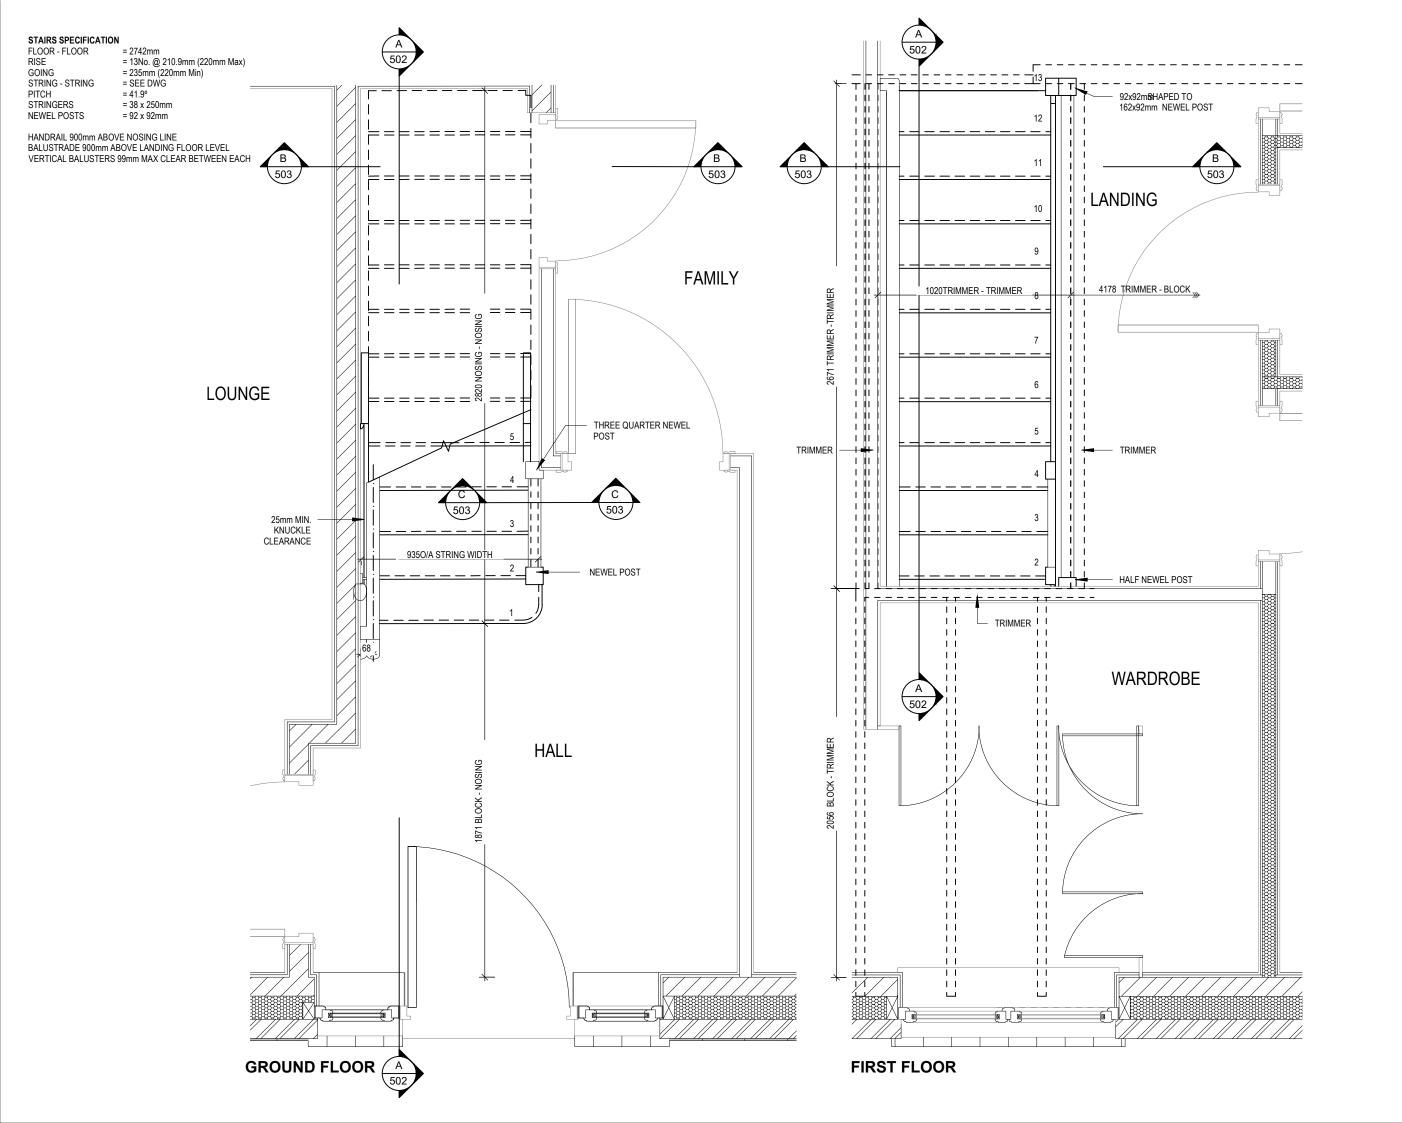

Harrogate M4(2)

of


Dwg No **501** Dwg Rev

82

**Scale** 1 : 20

Staircase Details 1

face of Brick/Block & Studwork. This drawing is subject to copyright law. **Do Not Scale Off This Dra** Dwg No **502** Dwg Rev S **∼** Staircase Details 2 of 3 Harrogate M4(2)

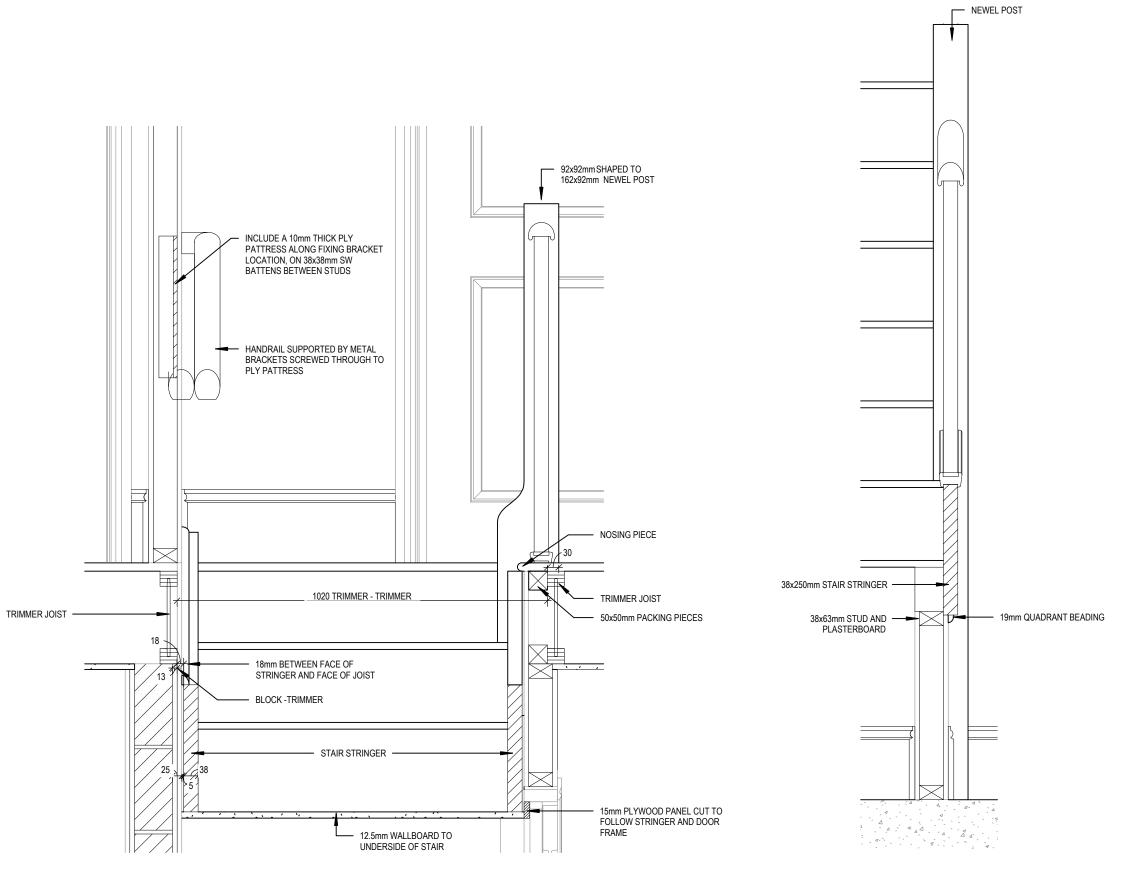

**SECTION B-B** Scale: 1:10

**SECTION C-C** Scale: 1:10


Harrogate M4(2)

Dwg No **503** Dwg Rev

200

Staircase Details 3 of

- PENDANT TYPE LIGHT FITTING
- BATTEN HOLDER LIGHT FITTING
- SINGLE S/W SOCKET OUTLET (LOW LEVEL)
- DOUBLE S/W SOCKET OUTLET (FILLED AT LOW LEVEL, CLEAR AT HIGH
- USB 💈 DOUBLE S/W SOCKET OUTLET WITH DOUBLE USB SOCKET (FILLED AT USB ⅓ LOW LEVEL, CLEAR AT HIGH LEVEL)
- EV 💈 ELECTRIC VEHICLE CHARGE POINT (SEE SITE SPECIFICATION)
- EXTERNAL POWER SUPPLY (OPTIONAL)
- $-\Box$ FUSED OUTLET (IMMERSION)
- ISOLATOR SWITCH
- SINGLE SWITCH, DOUBLE SWITCH, TRIPLE SWITCH
- 88 NOTE: WHERE MULTIPLE SWITCHES ARE INDICATED TOGETHER THESE ARE TO BE SWITCHED ON ONE SINGLE PLATE NOT ON 999
- COMBINED T.V., SATELLITE AND DATA POINT WITH OPTIONAL HIGH # LEVEL MOUNT
- T.V. POINT WITH OPTIONAL DATA POINT AND OPTIONAL HIGH LEVEL
- OPTIONAL T.V. POINT WITH OPTIONAL DATA POINT AND OPTIONAL HIGH LEVEL MOUNT
- DATA POINT
- (S) SMOKE DETECTOR
- $\Theta$ HEAT DETECTOR
- SHAVER SOCKET s -(
- ROOM THERMOSTAT S -
- INDIVIDUAL ZONE THERMOSTAT IZT -□
- 2 ZONE PROGRAMMER AND HOT WATER TIMER
- PROGRAMMABLE THERMOSTAT PT ∄
- EXTERNAL WALL LIGHT FITTING WITH INTEGRAL DUSK TO DAWN
- EXTERNAL SURFACE MOUNTED BULKHEAD LIGHT FITTING TO
- DOOR BELL PUSH BUTTON IN FRAME 0
- PV METER SWITCH (SITE UPGRADE/CUSTOMER OPTION)
- SEMI RECESSED CONSUMER UNIT
- DUSK TO DAWN SENSOR
- COMMS ENTRY POINT WITH SLOW RADIUS BEND
  - COMBINATION WALL MOUNTED ELECTRICAL DEVICES (REFER TO STD DETAIL)
  - CONSISTING:
    - DOOR BELL CHIME - ALARM KEYPAD (CUSTOMER OPTION)
    - DOUBLE LIGHT SWITCH
  - BANK OF SWITCHES ೭
  - PASSIVE INFRA-RED DETECTOR TO BE FITTED 2.4m MAX ABOVE FFL PIR (CUSTOMER OPTION)
- CENTRAL PROCESSOR UNIT, HEIGHT TO UNDERSIDE 2100mm CPU (CUSTOMER OPTION)
- (DC) DOOR CONTACT (CUSTOMER OPTION)

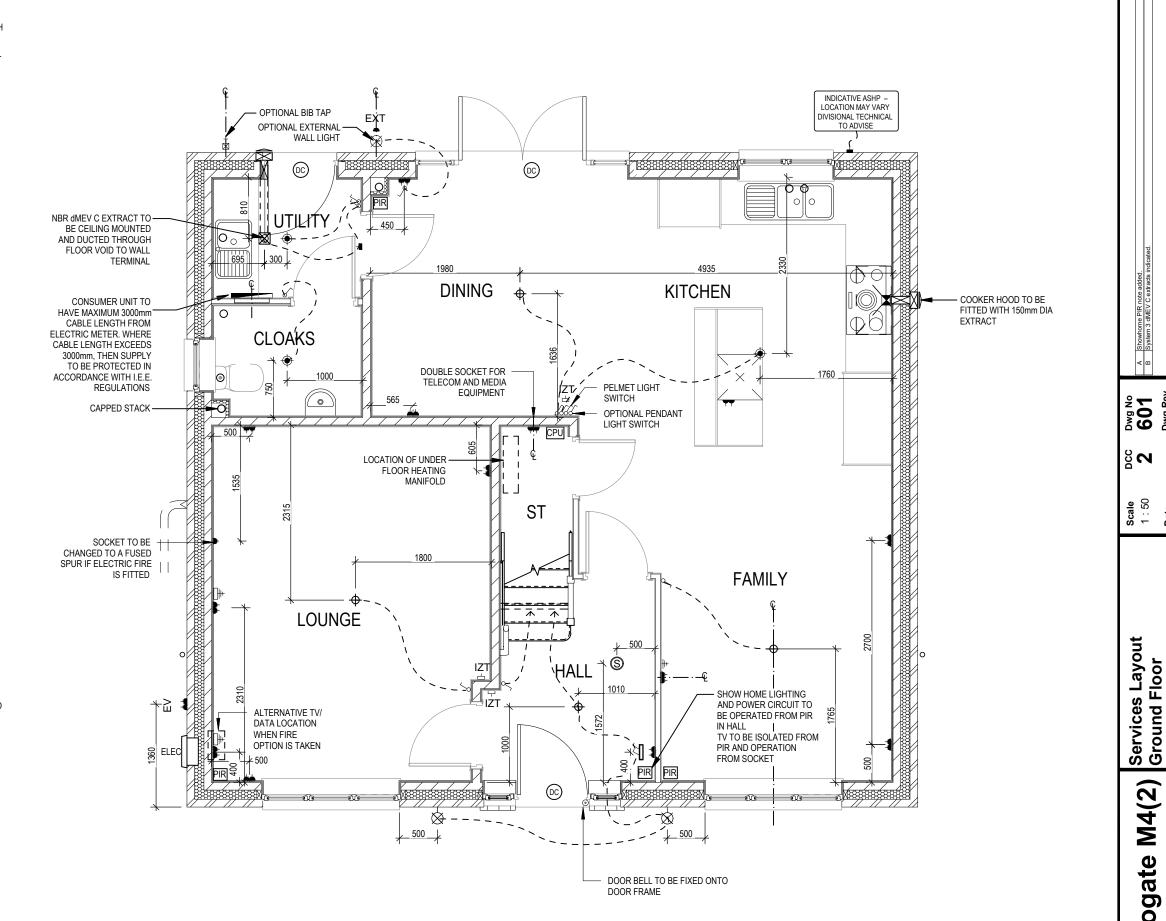

arrogate M4(2)

I

USB 💈

USB ∹

EV 🧵

EXT 📲

88

(H)

თ -(]

S -□

IZT -□


 $\bigcirc$ 

(CUSTOMER OPTION)

DOOR CONTACT (CUSTOMER OPTION)

CENTRAL PROCESSOR UNIT, HEIGHT TO UNDERSIDE 2100mm

888

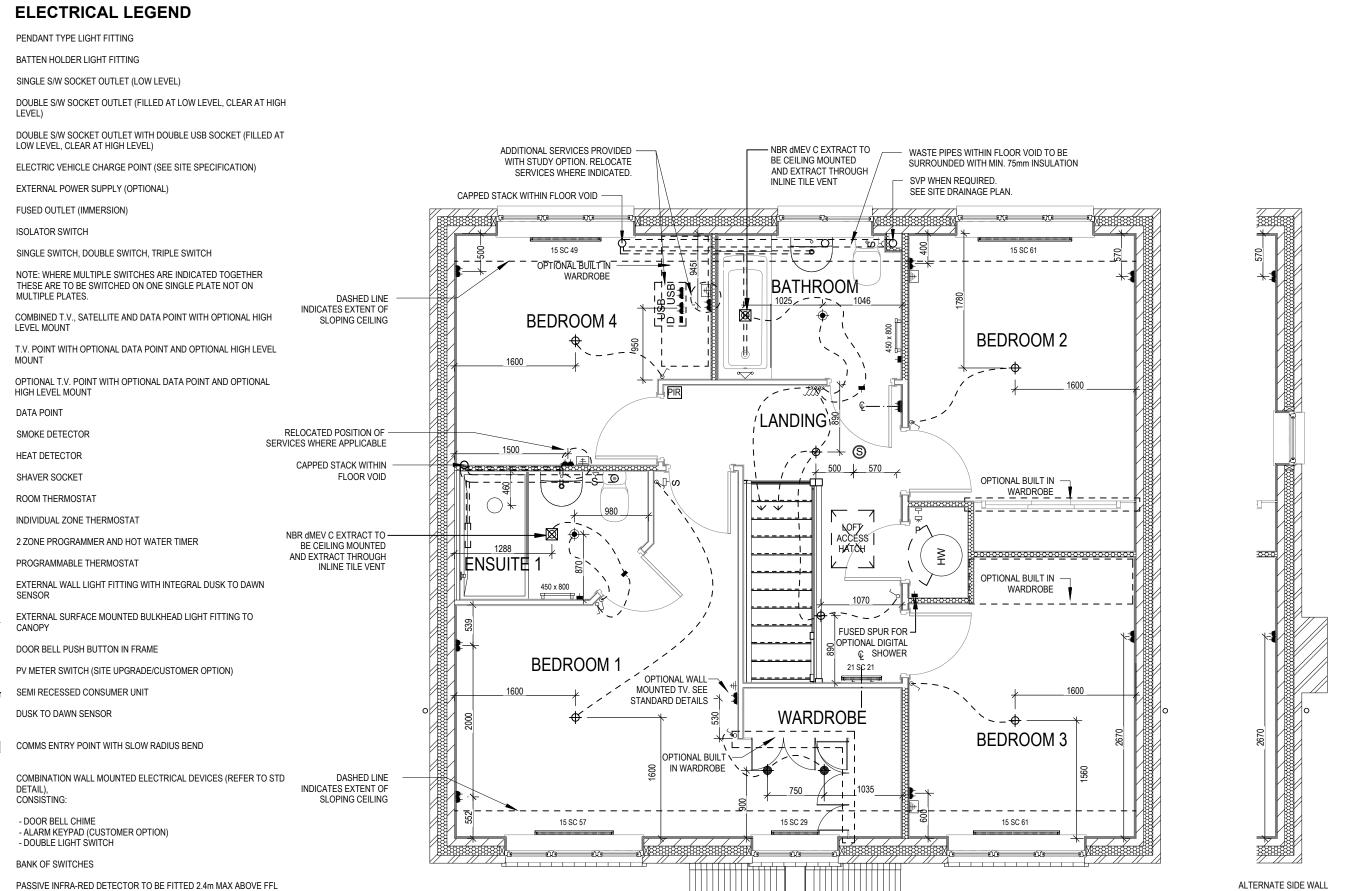

Services Layout First Floor 4(2) Ì ate 0 0 arr I

EXTRACT FOR CHIMNEY

VERSION, PLOTS 35, 83 & 100

602 602 Dwg Rev

ဗ္ဂ လ

**Scale** 1:50

Date

OPTIONAL ELECTRIC UNDER FLOOR HEATING WITH CONTROLLER AND STAT

SINGLE SWITCH


DOUBLE SWITCH


TRIPLE SWITCH

NOTE: WHERE MULTIPLE SWITCHES ARE INDICATED TOGETHER THESE ARE TO BE SWITCHED ON ONE SINGLE PLATE NOT ON MULTIPLE PLATES.

SHAVER SOCKET

OPTIONAL DIGITAL SHOWER SWITCH

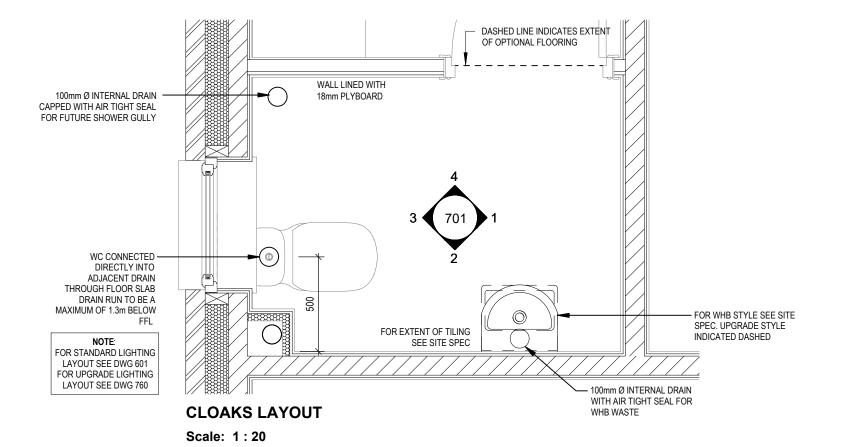

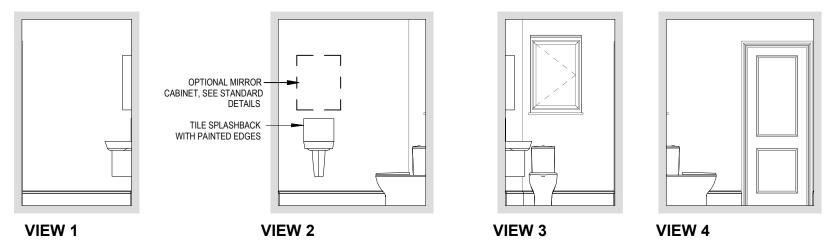

Scale: 1:50


Harrogate M4(2)

Dwg No 701 Dwg Rev

82

**Cloaks Details** 

Scale: 1:50

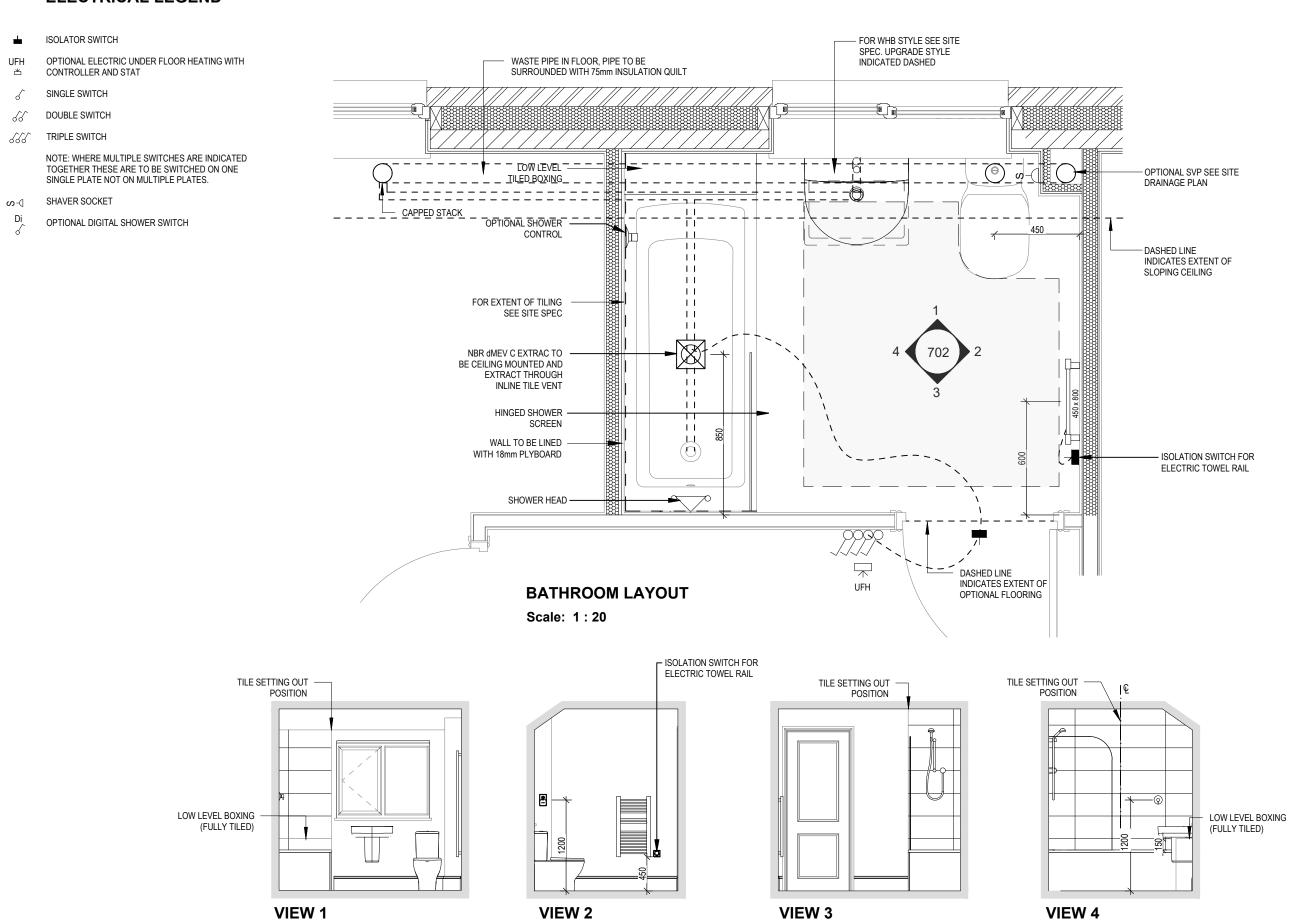

702 702 Dwg Rev

ဗ္ဂလ

**Bathroom Details** 

arrogate M4(2)

I

ISOLATOR SWITCH

OPTIONAL ELECTRIC UNDER FLOOR HEATING WITH CONTROLLER AND STAT UFH

SINGLE SWITCH


DOUBLE SWITCH

TRIPLE SWITCH


NOTE: WHERE MULTIPLE SWITCHES ARE INDICATED TOGETHER THESE ARE TO BE SWITCHED ON ONE SINGLE PLATE NOT ON MULTIPLE PLATES.

SHAVER SOCKET so-(

OPTIONAL DIGITAL SHOWER SWITCH

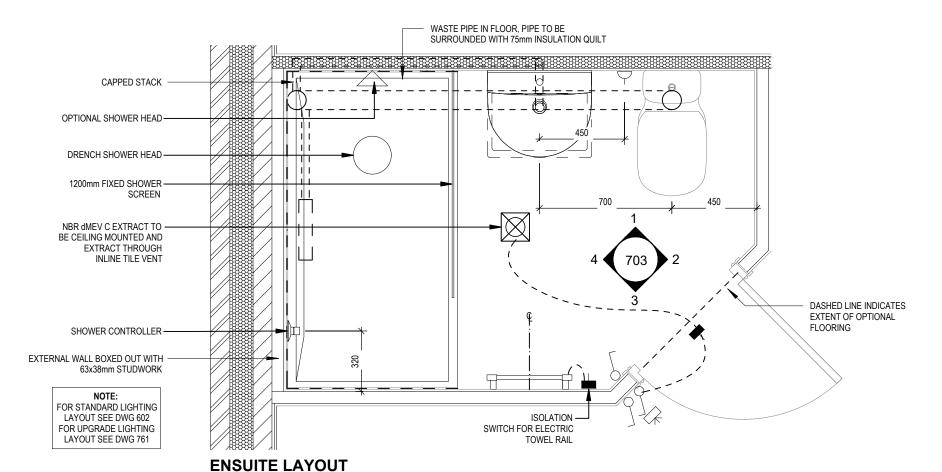

Scale: 1:20

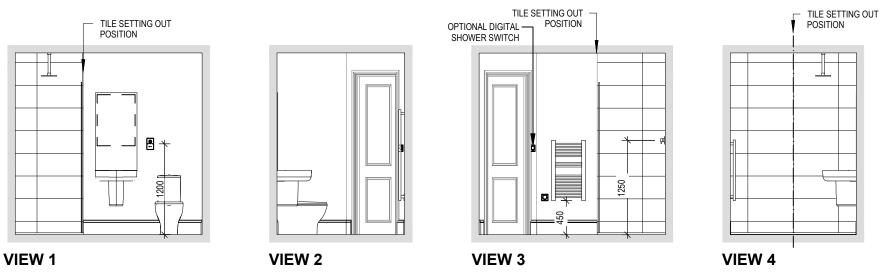

Scale: 1:50

Dwg No 703 Dwg Rev 82 Harrogate M4(2)

**Ensuite Details** 

PELMET LIGHT FITTING

- FUSED OUTLET (IMMERSION)

ISOLATOR SWITCH

SINGLE SWITCH

OUBLE SWITCH

STRIPLE SWITCH

NOTE: WHERE MULTIPLE SWITCHES ARE INDICATED TOGETHER THESE ARE TO BE SWITCHED ON ONE SINGLE PLATE NOT ON MULTIPLE PLATES.


- BANK OF SWITCHES TO ISOLATE HOB, EXTRACTOR HOOD, WASHING MACHINE, DISHWASHER, TUMBLE DRYER, FRIDGE/FREEZER, MICROWAVE OVEN, OPTIONAL WATER HEATER WITH NEON INDICATOR, ALL IN ACCORDANCE WITH THE APPLIANCE/SPACE PROVIDED ON LAYOUT.
- UNSWITCHED SOCKET / FUSED SPUR, TO BE CEILING MOUNTED, SEE STANDARD DETAILS
- SINGLE UNSWITCHED SOCKET (HIGH LEVEL)
- SINGLE UNSWITCHED SOCKET (LOW LEVEL)
- SINGLE UNSWITCHED FUSED SPUR (LOW LEVEL)
- DOUBLE S/W SOCKET OUTLET (HIGH LEVEL)
- DOUBLE S/W SOCKET OUTLET (LOW LEVEL)
- HEAT DETECTOR TO BS EN 14604: 2005, TO BE PERMANENTLY WIRED TO A SEPARATELY FUSED CIRCUIT AT THE DISTRIBUTION BOARD. WHERE MORE THAN ONE ARE INSTALLED THEY WILL BE INTER-CONNECTED. WIRING SHALL CONFORM TO IEE WIRING HEAT DETECTOR TO HAVE BATTERY BACKUP AND TO BE LOCATED A MIN. OF 300mm AWAY FROM ANY WALL AND LIGHT FITTING.

DOUBLE S/W SOCKET OUTLET WITH USB (HIGH LEVEL)

COOKER CONNECTION UNIT

P ⋊ PROGRAMMER & HOT WATER TIMER

PT ∜□ PROGRAMMABLE THERMOSTAT

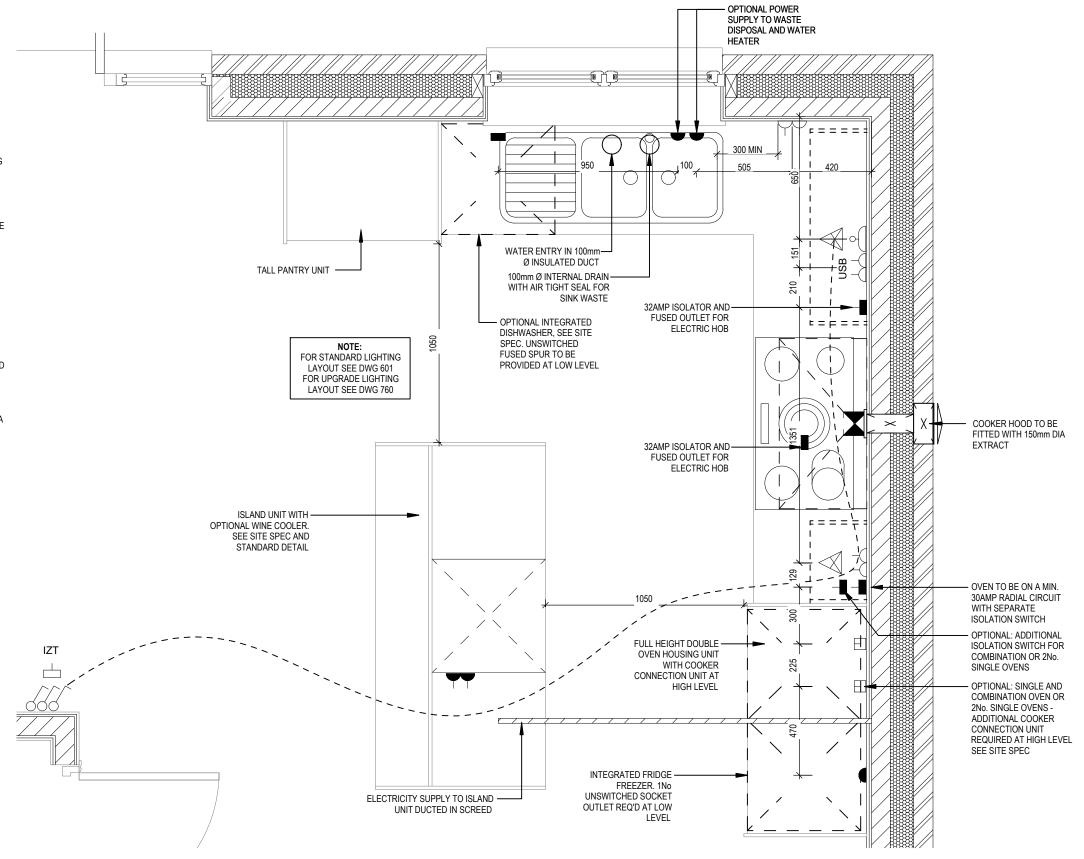

KITCHEN LAYOUT

Dwg No 750 Dwg Rev Date Feb 2 gate M4(2) arro

S N

**Scale** 1:20


Kitchen Layout

I

- FUSED OUTLET (IMMERSION)
- ISOLATOR SWITCH
- SINGLE SWITCH
- O DOUBLE SWITCH
- √√√ TRIPLE SWITCH

NOTE: WHERE MULTIPLE SWITCHES ARE INDICATED TOGETHER THESE ARE TO BE SWITCHED ON ONE SINGLE PLATE NOT ON MULTIPLE PLATES.

- BANK OF SWITCHES TO ISOLATE HOB, EXTRACTOR HOOD, WASHING MACHINE, DISHWASHER, TUMBLE DRYER, FRIDGE/FREEZER, MICROWAVE OVEN, OPTIONAL WATER HEATER WITH NEON INDICATOR, ALL IN ACCORDANCE WITH THE APPLIANCE/SPACE PROVIDED ON LAYOUT
- UNSWITCHED SOCKET / FUSED SPUR, TO BE CEILING MOUNTED, SEE
- SINGLE UNSWITCHED SOCKET (HIGH LEVEL)
- SINGLE UNSWITCHED SOCKET (LOW LEVEL)
- SINGLE UNSWITCHED FUSED SPUR (LOW LEVEL)
- DOUBLE S/W SOCKET OUTLET (HIGH LEVEL)
- DOUBLE S/W SOCKET OUTLET (LOW LEVEL)
- HEAT DETECTOR TO BS EN 14604: 2005, TO BE PERMANENTLY WIRED TO A SEPARATELY FUSED CIRCUIT AT THE DISTRIBUTION BOARD. WHERE MORE THAN ONE ARE INSTALLED THEY WILL BE INTERCONNECTED. WIRING SHALL CONFORM TO IEE WIRING  $\Theta$ HEAT DETECTOR TO HAVE BATTERY BACKUP AND TO BE LOCATED A
- MIN. OF 300mm AWAY FROM ANY WALL AND LIGHT FITTING.
- DOUBLE S/W SOCKET OUTLET WITH USB (HIGH LEVEL)
- COOKER CONNECTION UNIT
- P ⋊ PROGRAMMER & HOT WATER TIMER
- PT ⋊ PROGRAMMABLE THERMOSTAT

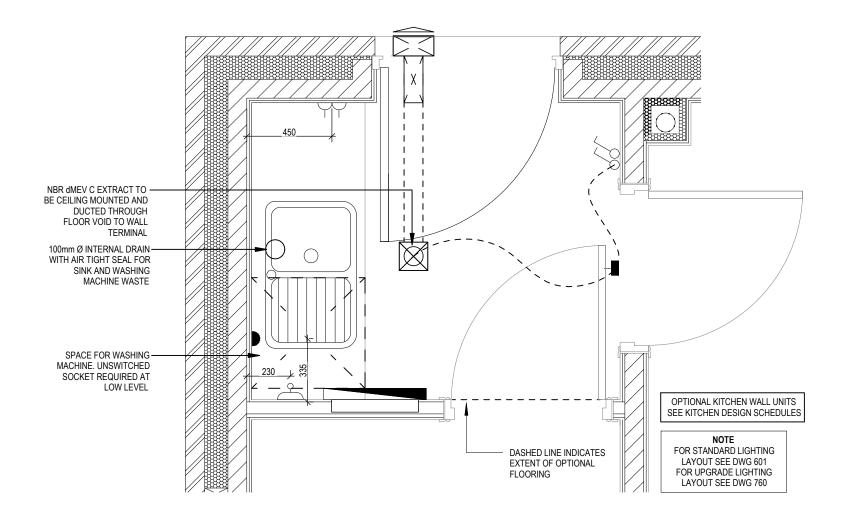

**UTILITY LAYOUT** 

Harrogate M4(2)

**Utility Layout** 

Dwg No 751 Dwg Rev


80


Scale 1:20

**Date** Feb 2

- OPTIONAL LOW VOLTAGE DOWNLIGHTER FITTING
- OPTIONAL PENDANT LIGHT FITTING
- SINGLE SWITCH
- O DOUBLE SWITCH
- TRIPLE SWITCH
- MEV INTERMITTENT CEILING MOUNTED EXTRACT

NOTE: WHERE MULTIPLE SWITCHES ARE INDICATED TOGETHER THESE ARE TO BE SWITCHED ON ONE SINGLE PLATE NOT ON MULTIPLE PLATES.

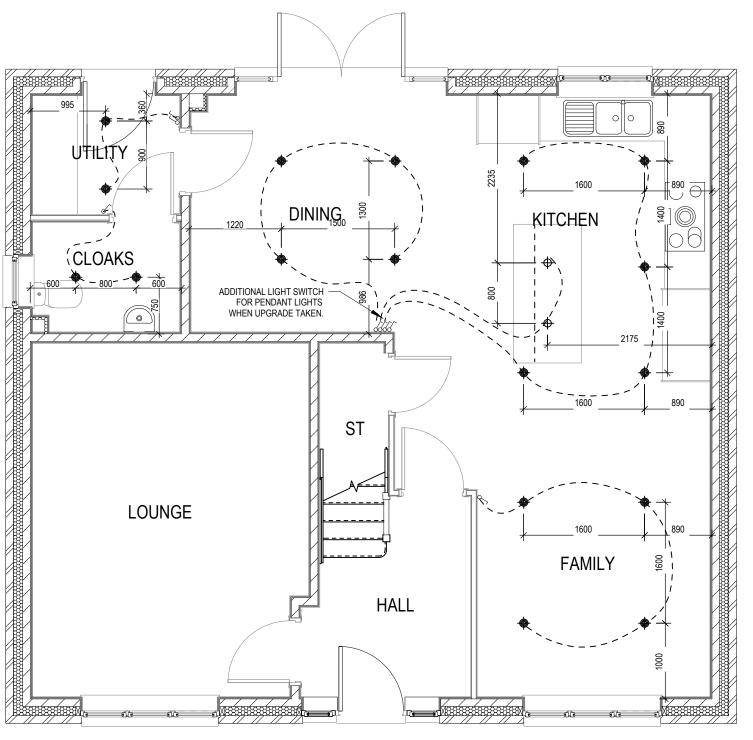

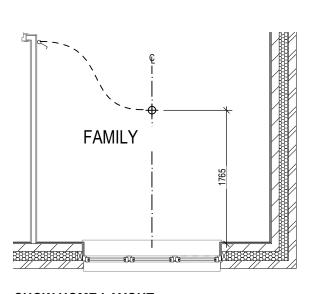

**SHOW HOME LAYOUT** 

Dwg No 760 Dwg Rev


200

Optional Lighting Layout Ground Floor

Harrogate M4(2)

- OPTIONAL LOW VOLTAGE DOWNLIGHTER FITTING
- OPTIONAL PENDANT LIGHT FITTING
- SINGLE SWITCH
- O DOUBLE SWITCH
- SSS TRIPLE SWITCH
- MEV INTERMITTENT CEILING MOUNTED EXTRACT

NOTE: WHERE MULTIPLE SWITCHES ARE INDICATED TOGETHER THESE ARE TO BE SWITCHED ON ONE SINGLE PLATE NOT ON MULTIPLE PLATES.

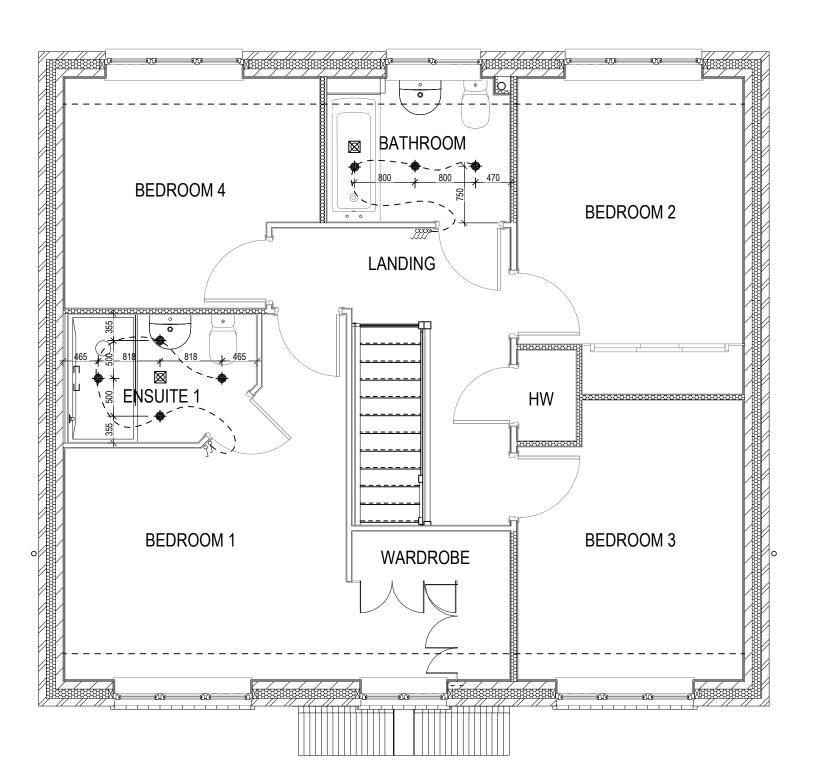

Harrogate M4(2)

Optional Lighting Layout First Floor

Dwg No **761** Dwg Rev

200

**EAVES SPROCKET DETAIL** 45° MAIN PITCH WITH 40.1° SPROCKET **801** Dwg Rev

Non-Standard Eaves Details

S<sub>N</sub>

Harrogate M4(2)