	Shaftesbury G SERIES	Slab Penetration Layout			Scale 1 : 50	DCC 2	Dwg No 160
					Date Feb 2023	Dwg Rev	

This drawing must be read in conjunction with relevant Redrow specifications, standard details & structural calculations. All dimension are taken from face of Brick/Block & Studwork. This drawing is subject to copyright law. Do Not Scale Off This Drawing.

Window Schedule						
Ref	Frame Width	Frame Height	Int Block Opening	Comments	P1A - Glazing	PAS 24 - Locking
W01	2510	1490	2520			Yes
W02	1835	1490	1845			Yes
W03	1273	1490	1283			Yes
W04	1273	1490	1283			Yes
W05	1835	1190	1845			Yes
W06	1835	1340	1845	ESC		
W07	1273	1040	1283			
W08	1835	1340	1845	ESC		
W09	1273	1340	1283			
W10	1273	1340	1283	ESC		
W11	710	1040	720	OBS		
W12	1273	1190	1283	ESC		
W13	710	1040	720	OBS		



REFER TO TM59 CALCULATION FOR OPENINGS REMOVING EXCESS HEAT. ALL BEDROOM WINDOWS DESIGNED TO 1.1M ABOVE FFL WITH A BUILD TOLERANCE +0/-100MM. WINDOWS WITH LOWER OPENING HEIGHTS ARE EXCLUDED FROM TM59 CALCULATION AND REQUIRED FOR MEANS OF ESCAPE.

Door Schedule - Internal				
Ref	Width	Height	Fire Rating	Code
D04	745	1400		ID13
D05	900	2150		HID2
D06	900	2150		HID2
D07	900	2150		HID2
D08	900	2150		HID2
D09	825	2150		HID3
D10	825	2150		HID3
D11	825	2150		HID3
D12	825	2150		HID3
D13	825	2150		HID3
D14	825	2150		HID3
D15	825	2150		HID3

Door Schedule - External						
Ref	Frame Width	Int Block Opening	Height	Model	P1A - Glazing	PAS 24 - Locking
D01	935	975	2250	HED03	Yes	Yes
D02	935	975	2250	HRD01	Yes	Yes
D03	2475	2485	2250	HRD16	Yes	Yes

WALL LEGEND

WALL TYPE	SIZE (mm)	STRENGTH (N/mm ²)	DENSITY (Kg/m ³)	LAMBDA (λ)
BLOCKWORK	100	3.6	600	0.15
BLOCKWORK	100	3.6	MIN 1350	-
40dB STUDWORK	63 (88)	-	-	-

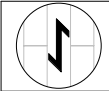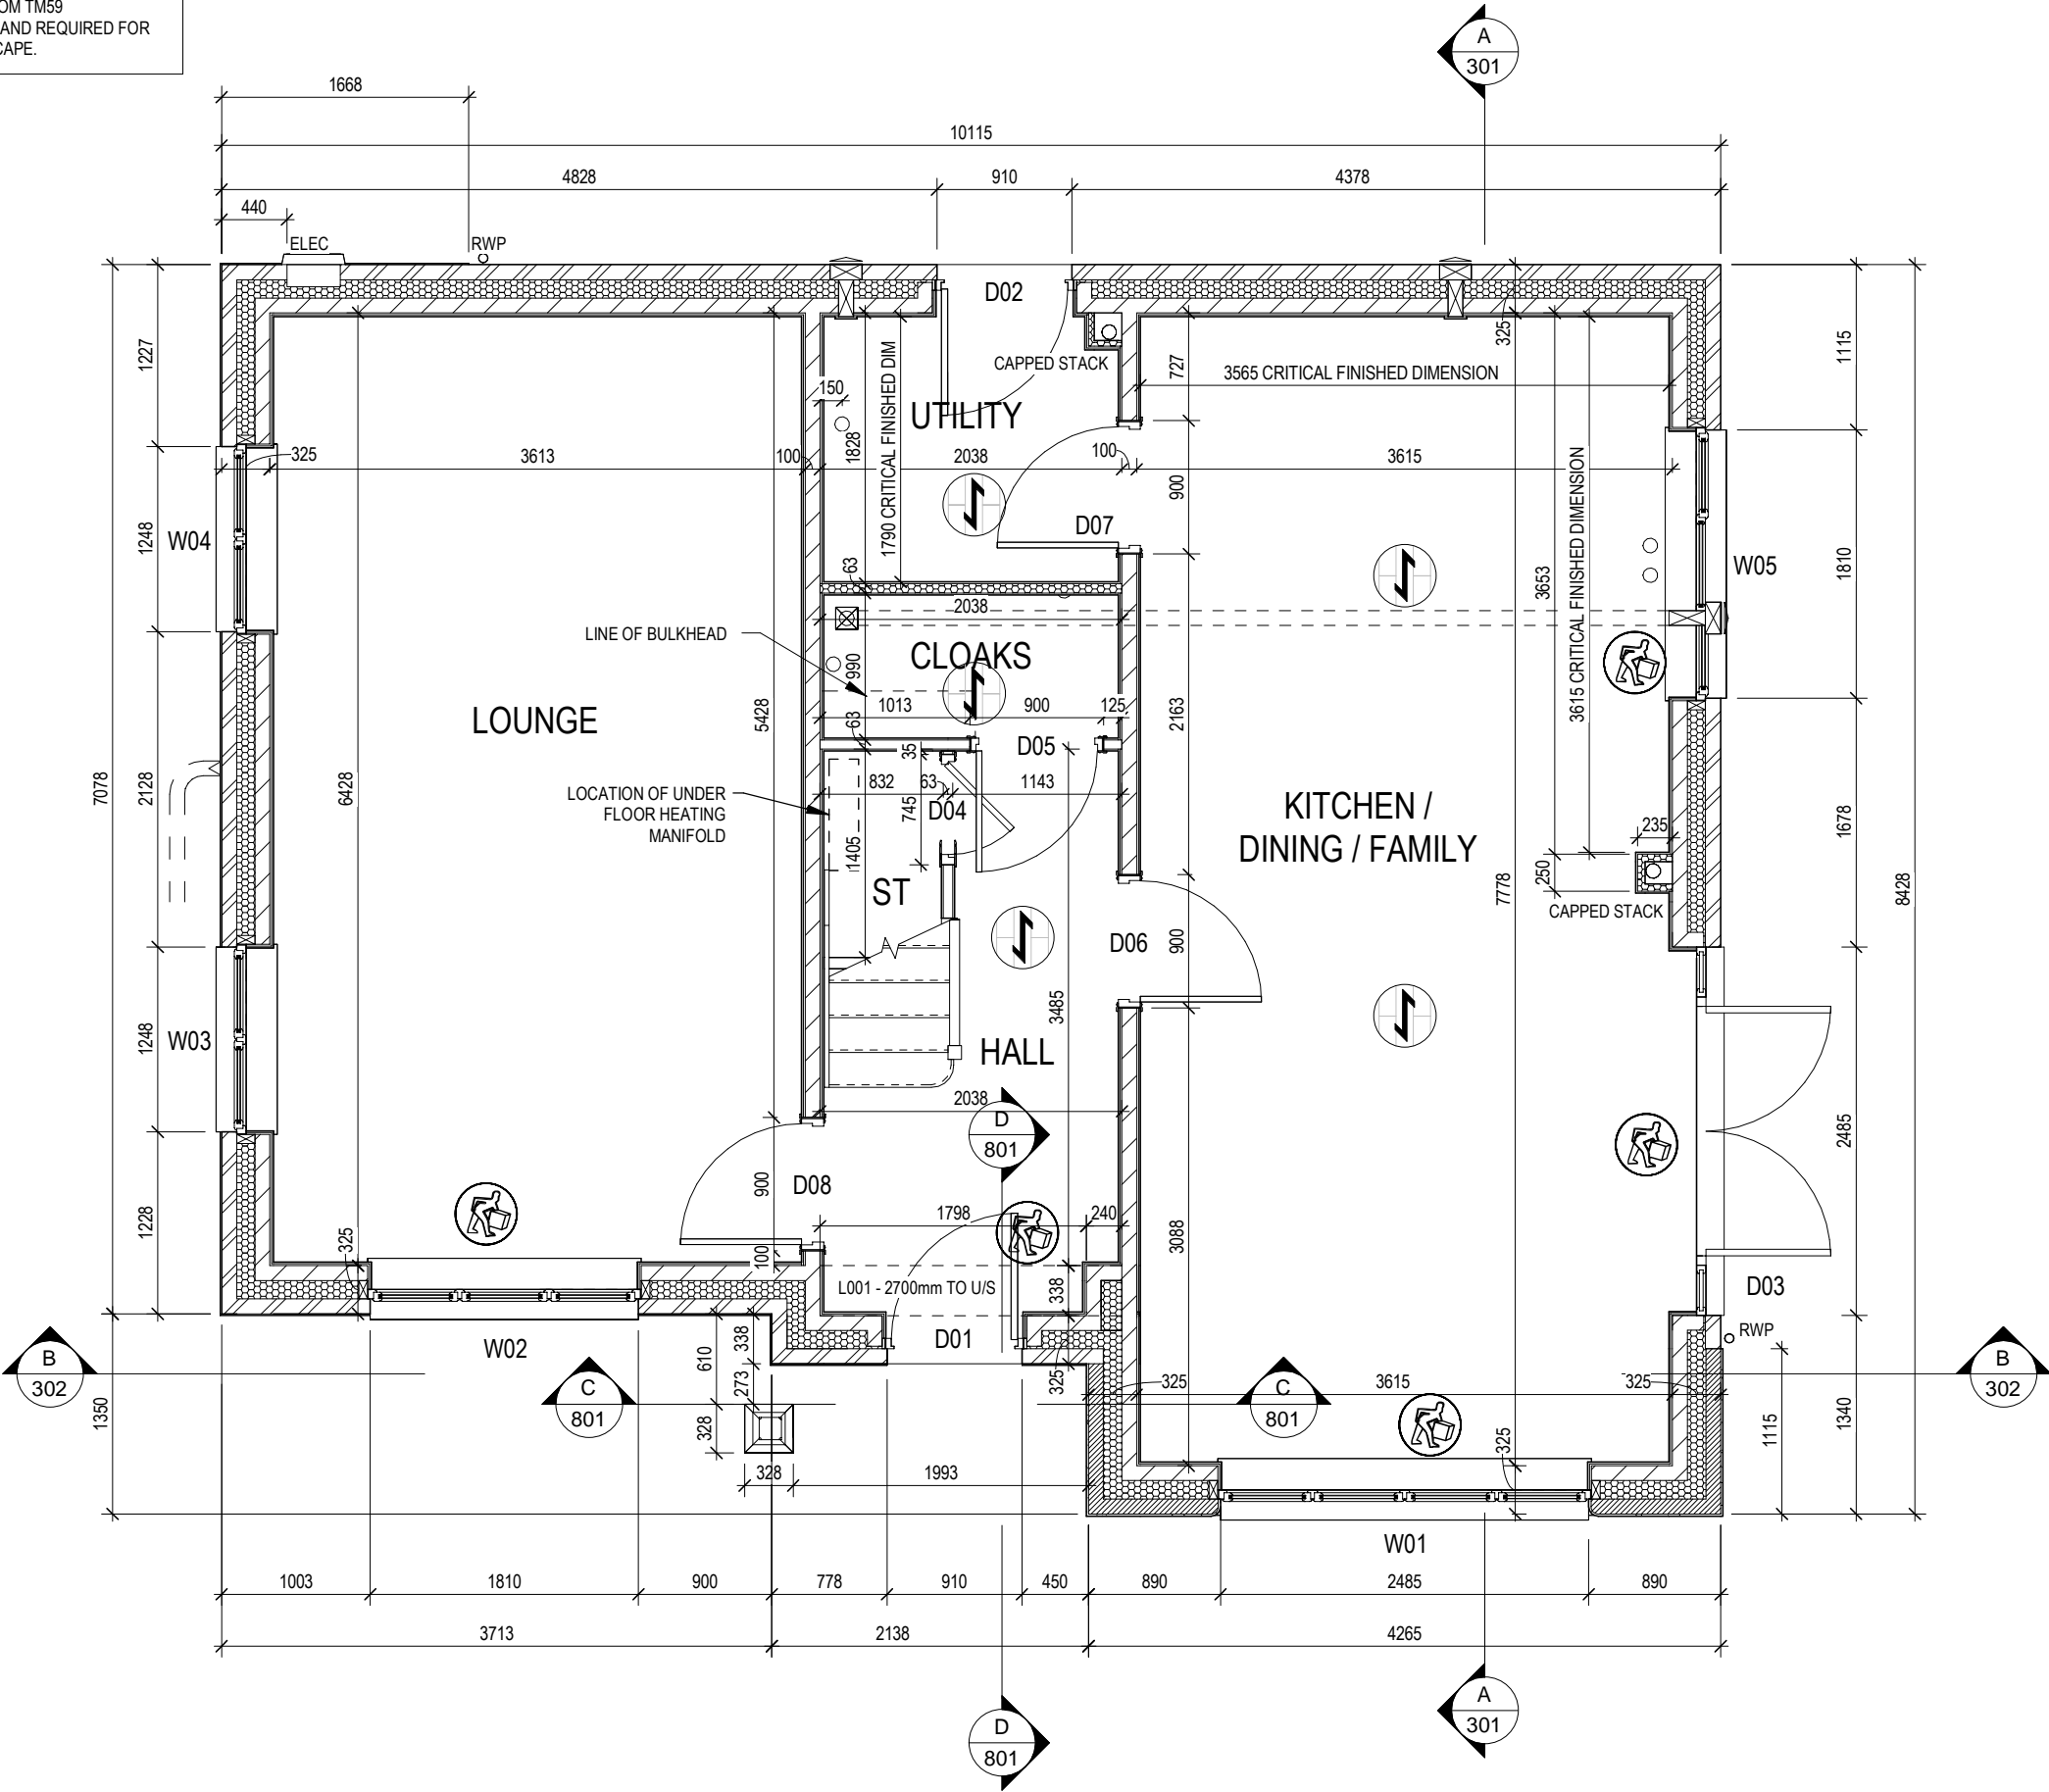

LOCATION AND DIRECTION OF OPTIONAL FLOOR TILING

Structural Layout Ground Floor

Shaftesbury

G SERIES

DCC

Scale

1 : 50

Dwg No

201

Dwg Rev

Date

Feb 2023

This drawing must be read in conjunction with relevant Redrow specifications, standard details & structural calculations. All dimension are taken from face of Brick/Block & Studwork. This drawing is subject to copyright law. Do Not Scale Off This Drawing.

Window Schedule						
Ref	Frame Width	Frame Height	Int Block Opening	Comments	P1A - Glazing	PAS 24 - Locking
W01	2510	1490	2520			Yes
W02	1835	1490	1845			Yes
W03	1273	1490	1283			Yes
W04	1273	1490	1283			Yes
W05	1835	1190	1845			Yes
W06	1835	1340	1845	ESC		
W07	1273	1040	1283			
W08	1835	1340	1845	ESC		
W09	1273	1340	1283			
W10	1273	1340	1283	ESC		
W11	710	1040	720	OBS		
W12	1273	1190	1283	ESC		
W13	710	1040	720	OBS		


Door Schedule - Internal				
Ref	Width	Height	Fire Rating	Code
D04	745	1400		ID13
D05	900	2150		HID2
D06	900	2150		HID2
D07	900	2150		HID2
D08	900	2150		HID2
D09	825	2150		HID3
D10	825	2150		HID3
D11	825	2150		HID3
D12	825	2150		HID3
D13	825	2150		HID3
D14	825	2150		HID3
D15	825	2150		HID3

Door Schedule - External						
Ref	Frame Width	Int Block Opening	Height	Model	P1A - Glazing	PAS 24 - Locking
D01	935	975	2250	HED03	Yes	Yes
D02	935	975	2250	HRD01	Yes	Yes
D03	2475	2485	2250	HRD16	Yes	Yes

WALL LEGEND

WALL TYPE	SIZE (mm)	STRENGTH (N/mm²)	DENSITY (kg/m³)	LAMBDA (m)
BLOCKWORK	100	3.6	600	0.15
BLOCKWORK	100	7.3	750	0.19
BLOCKWORK	100	3.6	MIN 1350	-
40dB STUDWORK	63 (88)	-	-	-

REFER TO TM59 CALCULATION FOR OPENINGS REMOVING EXCESS HEAT. ALL BEDROOM WINDOWS DESIGNED TO 1.1M ABOVE FFL WITH A BUILD TOLERANCE +0/-100MM. WINDOWS WITH LOWER OPENING HEIGHTS ARE EXCLUDED FROM TM59 CALCULATION AND REQUIRED FOR MEANS OF ESCAPE.

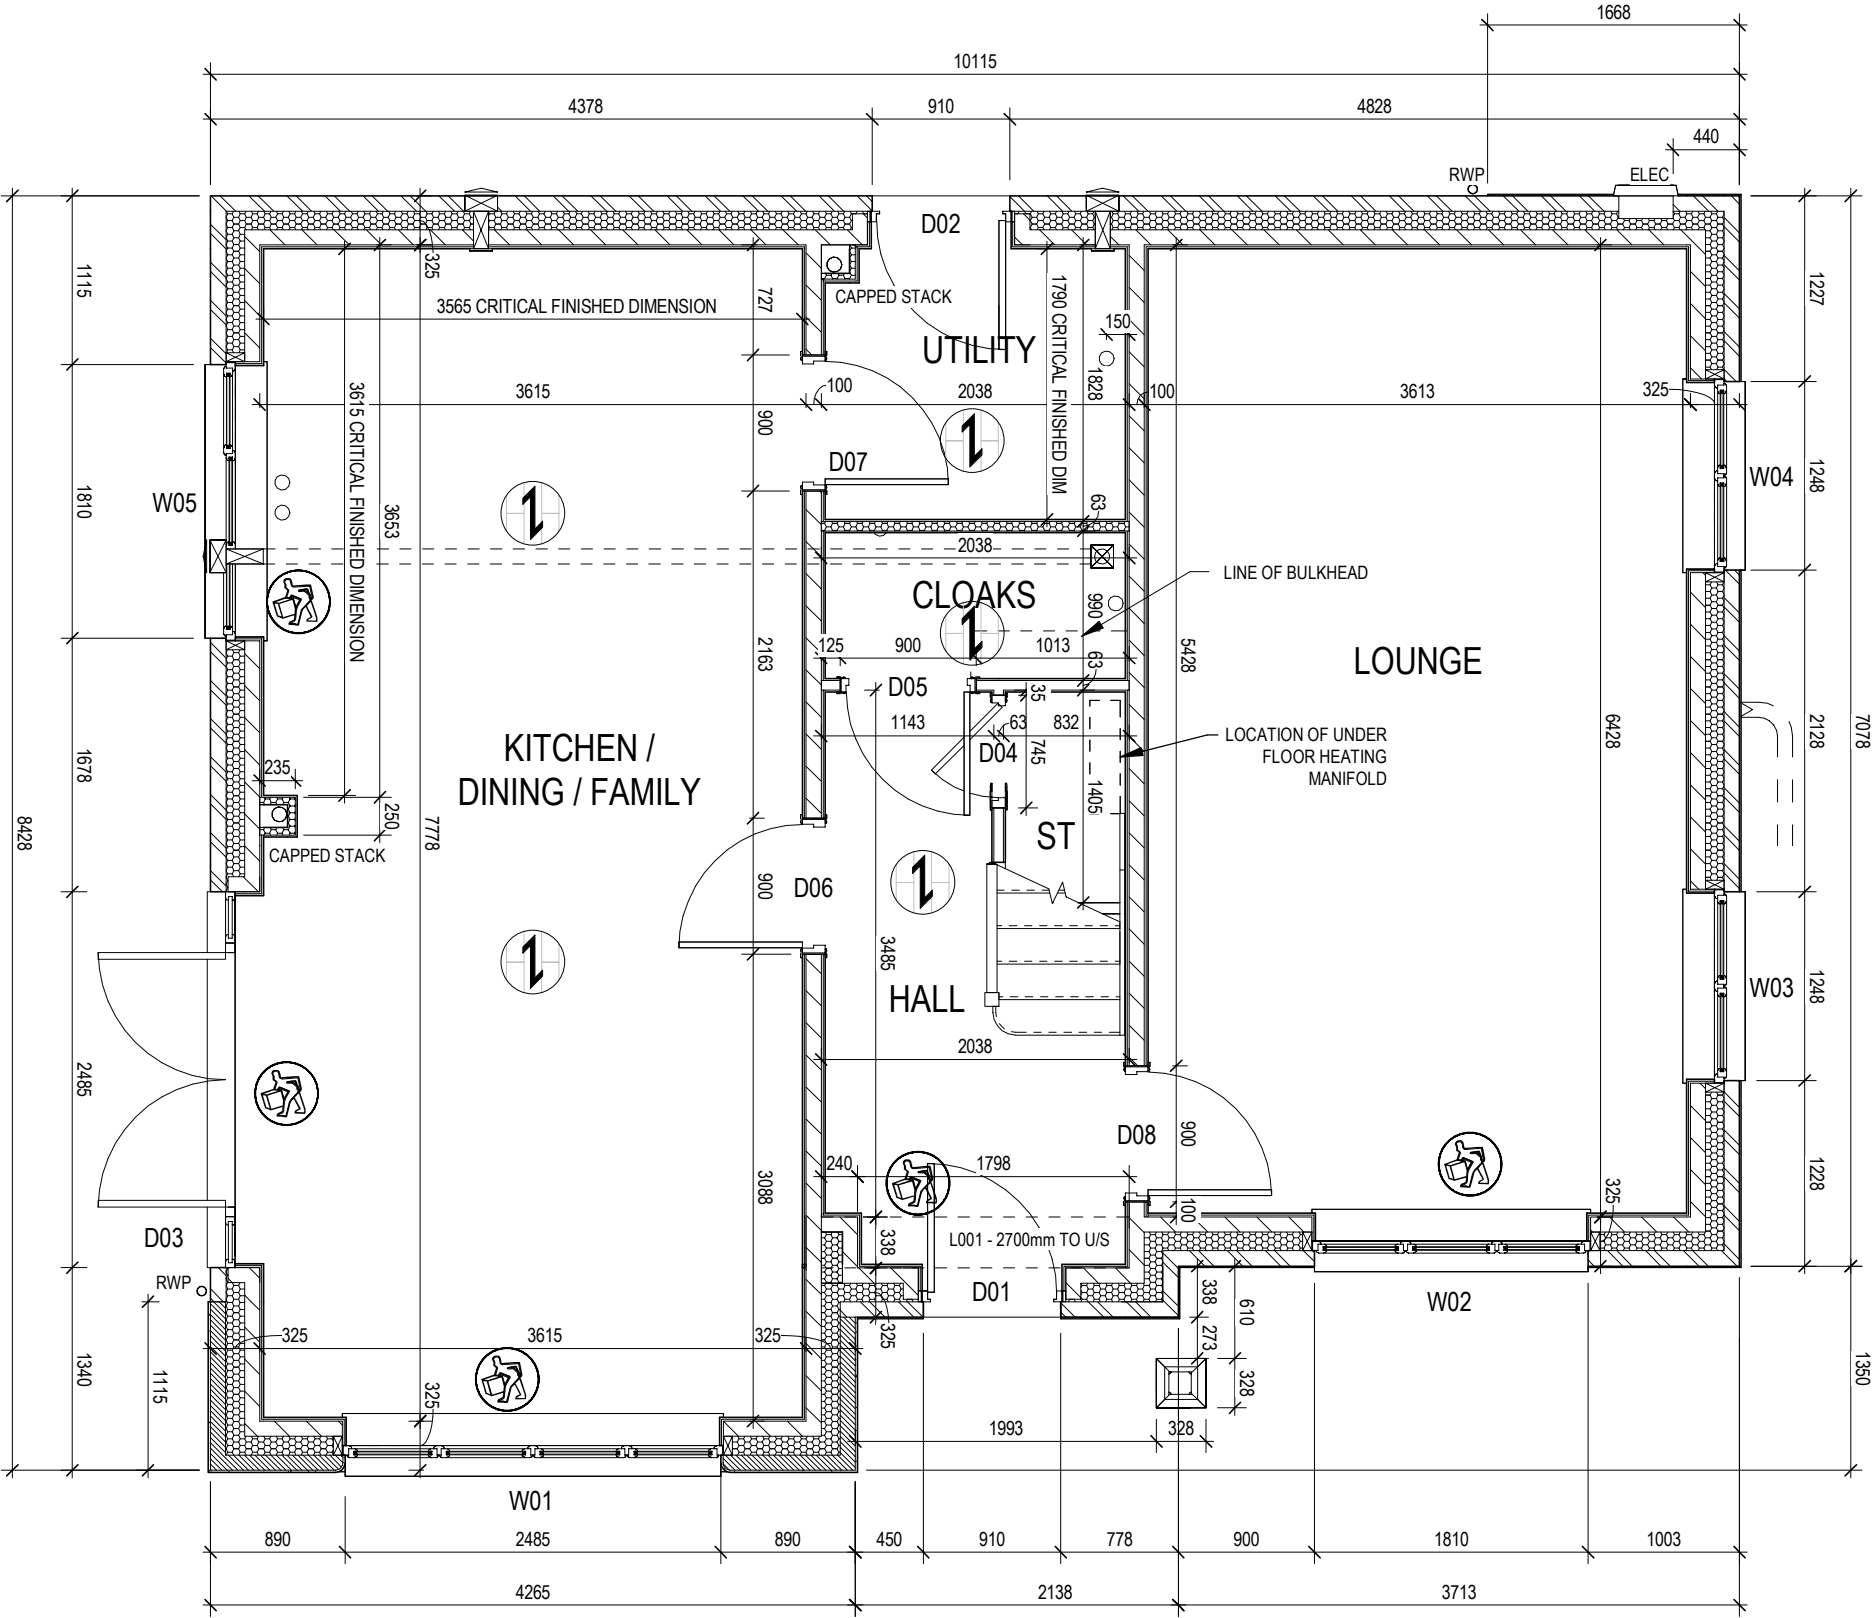

OPPOSITE

Shatesbury

G SERIES

Structural Layout Ground

Floor - Opp

DCC

Scale

Date

Dwg No

2

1

Dwg Rev

211

50

Feb 2023





REDROW

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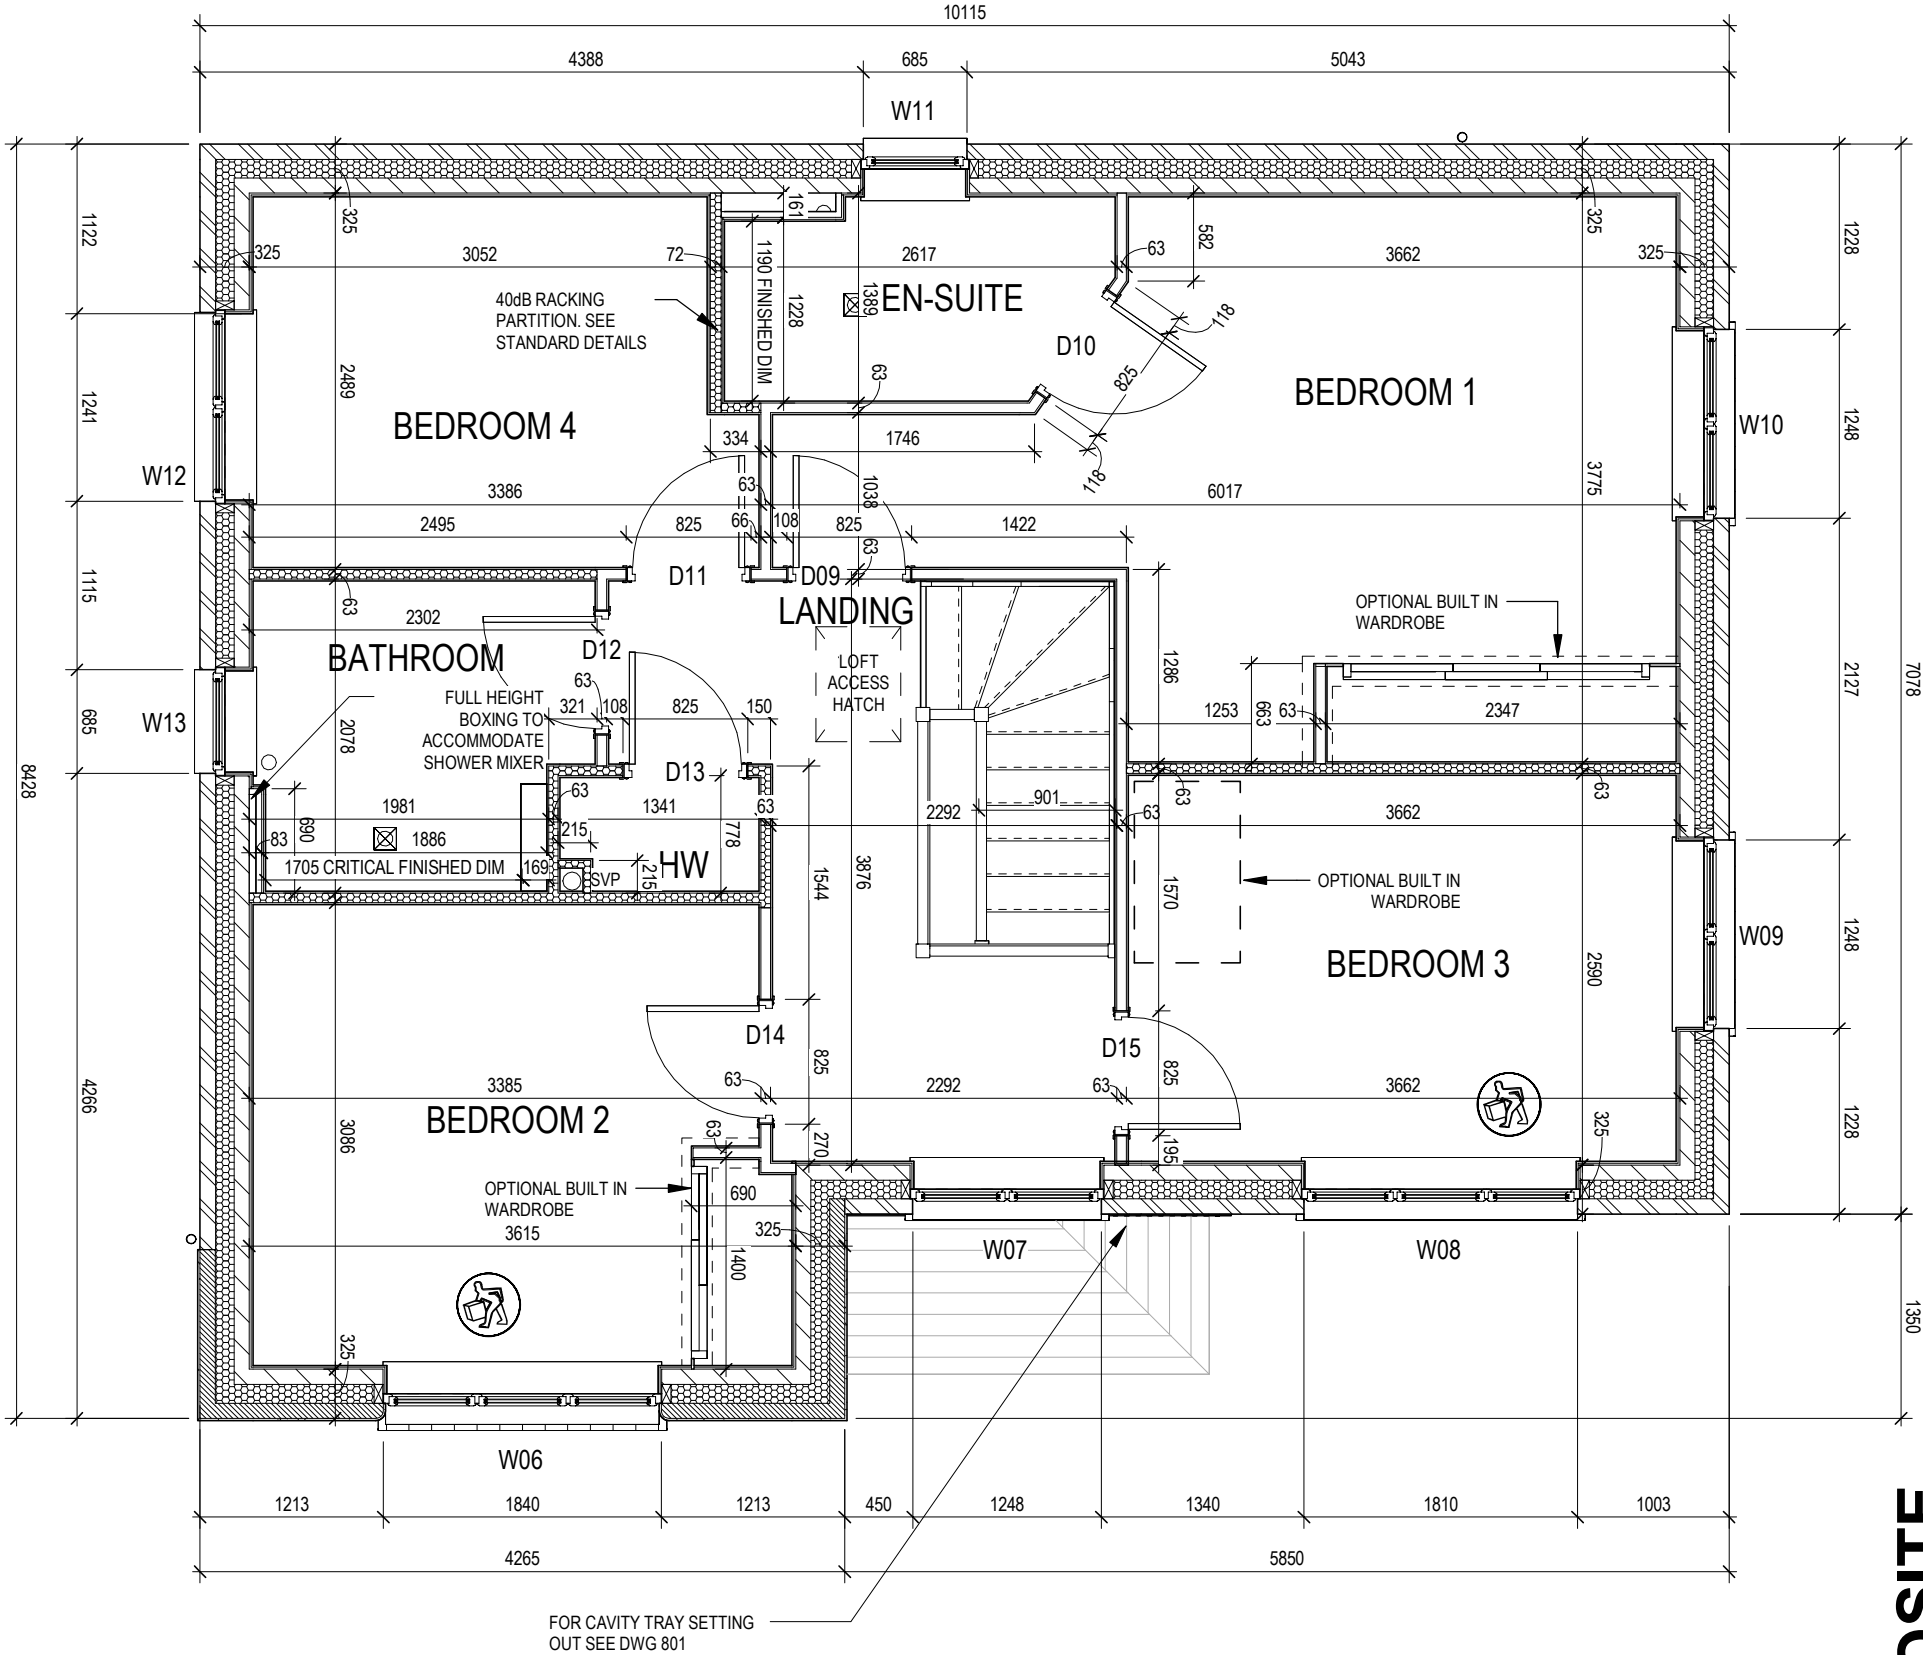
Window Schedule						
Ref	Frame Width	Frame Height	Int Block Opening	Comments	P1A - Glazing	PAS 24 - Locking
W01	2510	1490	2520			Yes
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W03	1273	1490	1283			Yes
W04	1273	1490	1283			Yes
W05	1835	1190	1845			Yes
W06	1835	1340	1845	ESC		
W07	1273	1040	1283			
W08	1835	1340	1845	ESC		
W09	1273	1340	1283	ESC		
W10	1273	1340	1283	ESC		
W11	710	1040	720	OBS		
W12	1273	1190	1283	ESC		
W13	710	1040	720	OBS		

Door Schedule - Internal				
Ref	Width	Height	Fire Rating	Code
D04	745	1400		ID13
D05	900	2150		HID2
D06	900	2150		HID2
D07	900	2150		HID2
D08	900	2150		HID2
D09	825	2150		HID3
D10	825	2150		HID3
D11	825	2150		HID3
D12	825	2150		HID3
D13	825	2150		HID3
D14	825	2150		HID3
D15	825	2150		HID3

WALL LEGEND

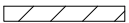WALL TYPE	SIZE (mm)	STRENGTH (N/mm ²)	DENSITY (Kg/m ³)	LAMBDA (λ)
BLOCKWORK 	100	3.6	600	0.15
BLOCKWORK 	100	7.3	750	0.19
BLOCKWORK 	100	3.6	MIN 1350	-
40dB STUDWORK 	63 (88)	-	-	-

REFER TO TM59 CALCULATION FOR OPENINGS REMOVING EXCESS HEAT. ALL BEDROOM WINDOWS DESIGNED TO 1.1M ABOVE FFL WITH A BUILD TOLERANCE +0/-100MM. WINDOWS WITH LOWER OPENING HEIGHTS ARE EXCLUDED FROM TM59 CALCULATION AND REQUIRED FOR MEANS OF ESCAPE.



OPPOSITE

02/10/23

Bedroom 2 optional built in wardrobe opening increased to 1400mm

V

Dwg No

DCC

Scale

Structural Layout First Floor

Shaftesbury

REDROW

Dwg Rev

2

1 : 50


Date

Feb 2023

- Opp

G SERIES

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Section A-A

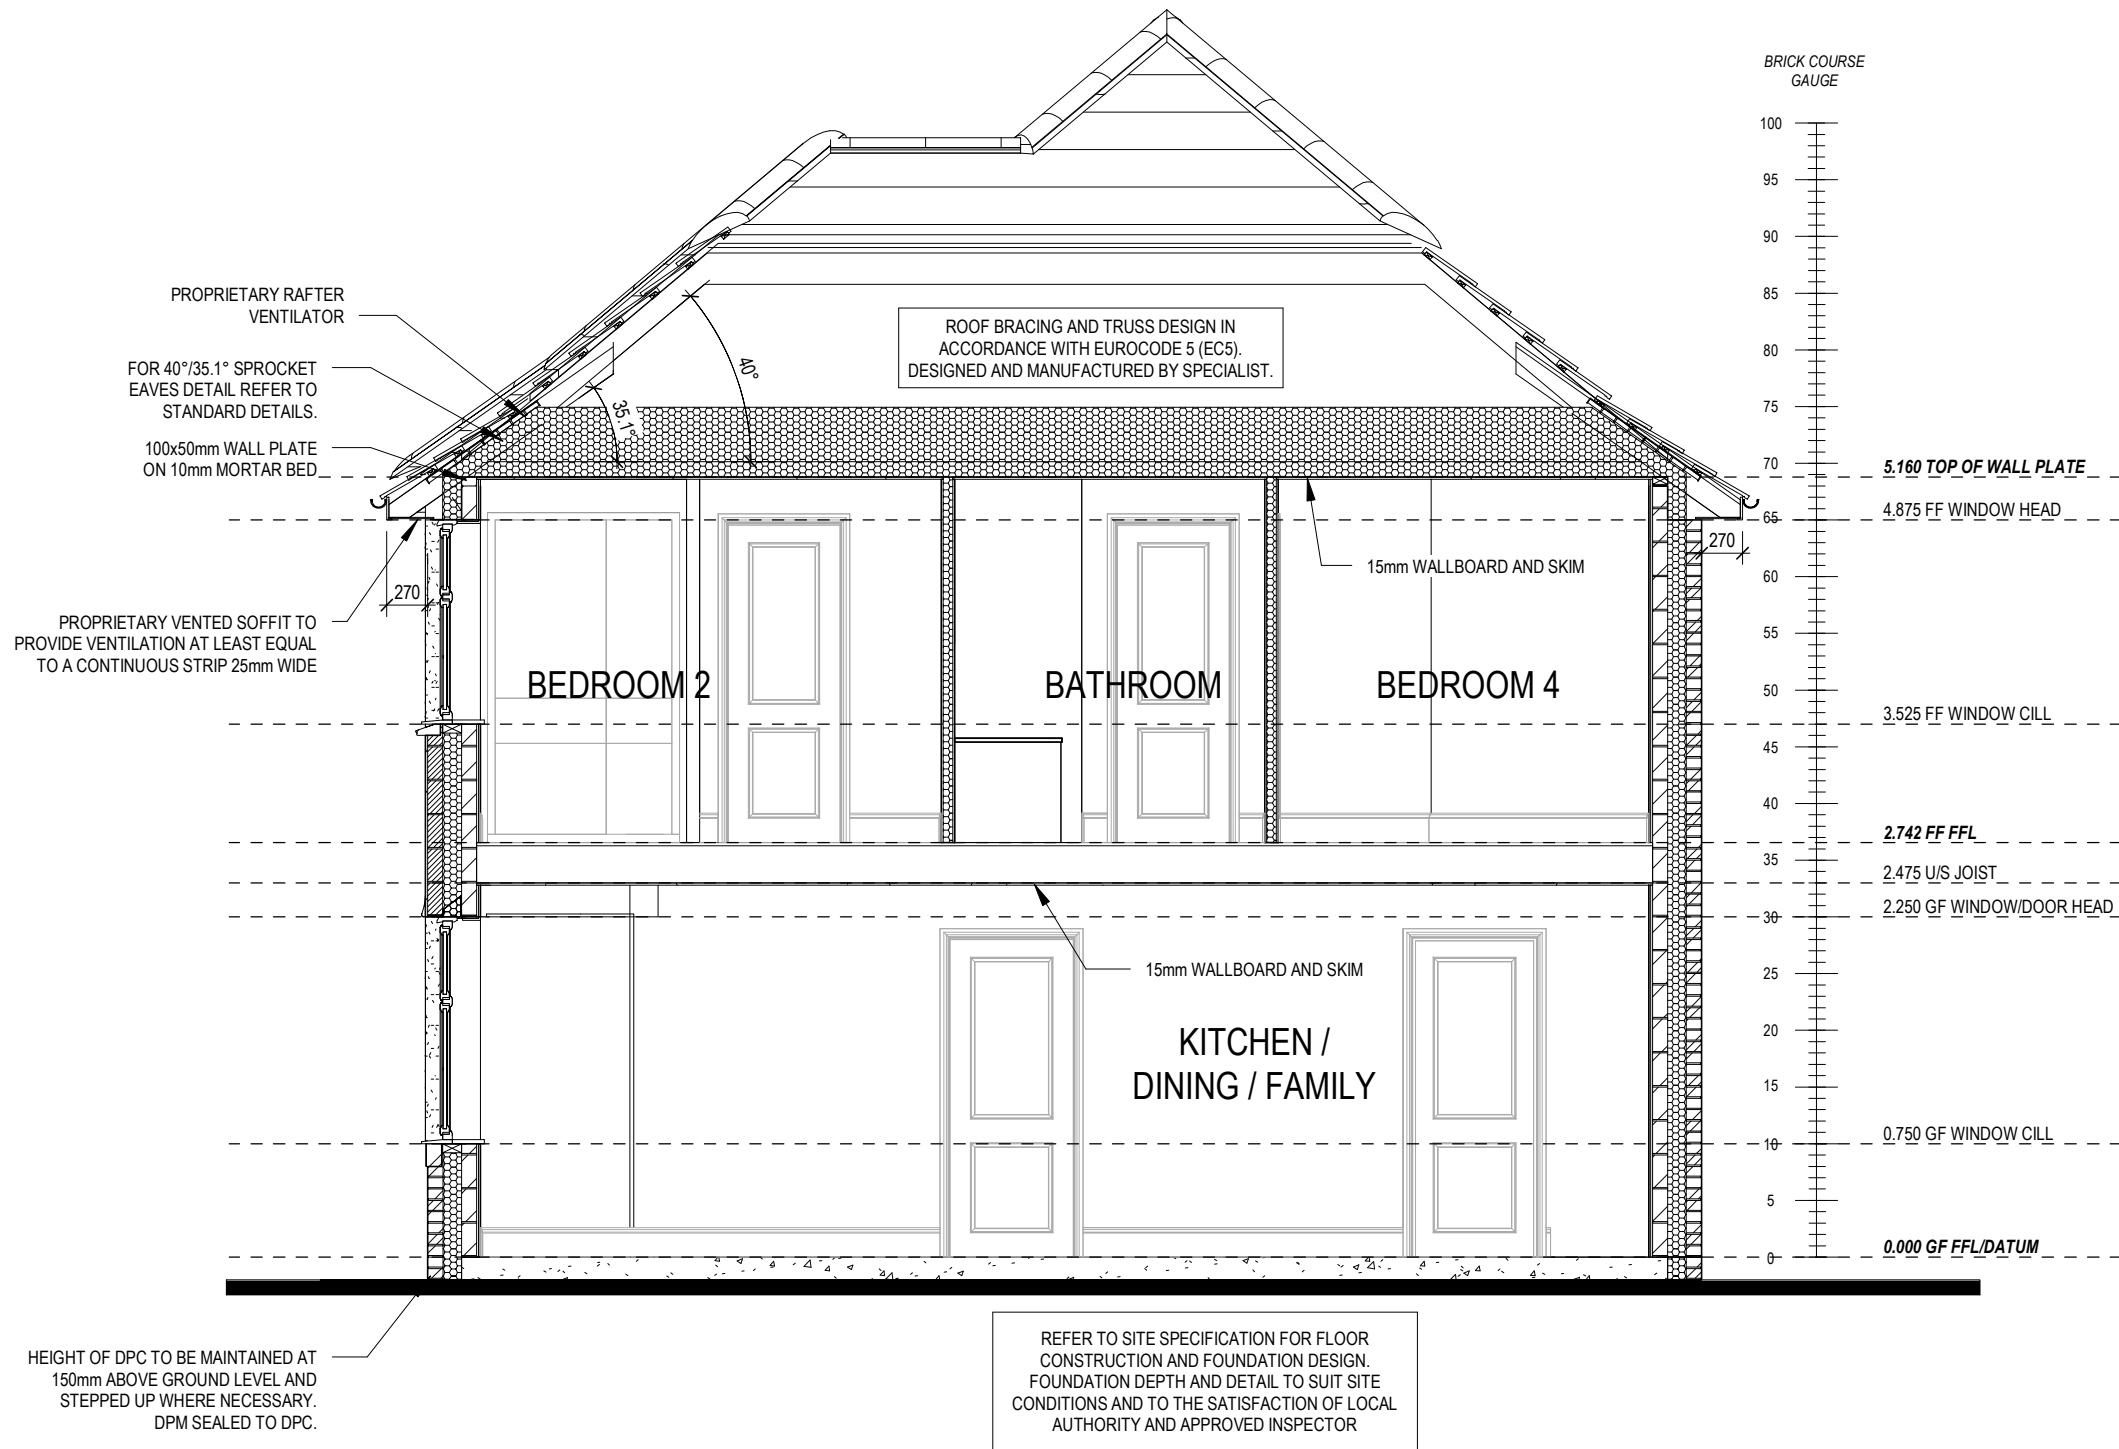Shaftesbury

G SERIES

Dwg No

DCC

Scale

Section A-A

Shaftesbury

G SERIES

Dwg No

DCC

Scale

Section A-A

Shaftesbury

G SERIES

Dwg No

DCC

Scale

Section A-A

Shaftesbury

G SERIES

Dwg No

DCC

Scale

Section A-A

Shaftesbury

G SERIES

Dwg No

DCC

Scale

Section A-A

Shaftesbury

G SERIES

Dwg No

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Section A-A

Shaftesbury

G SERIES

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Section A-A

Shaftesbury

G SERIES


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DCC


Scale

Section A-A

Shaftesbury</

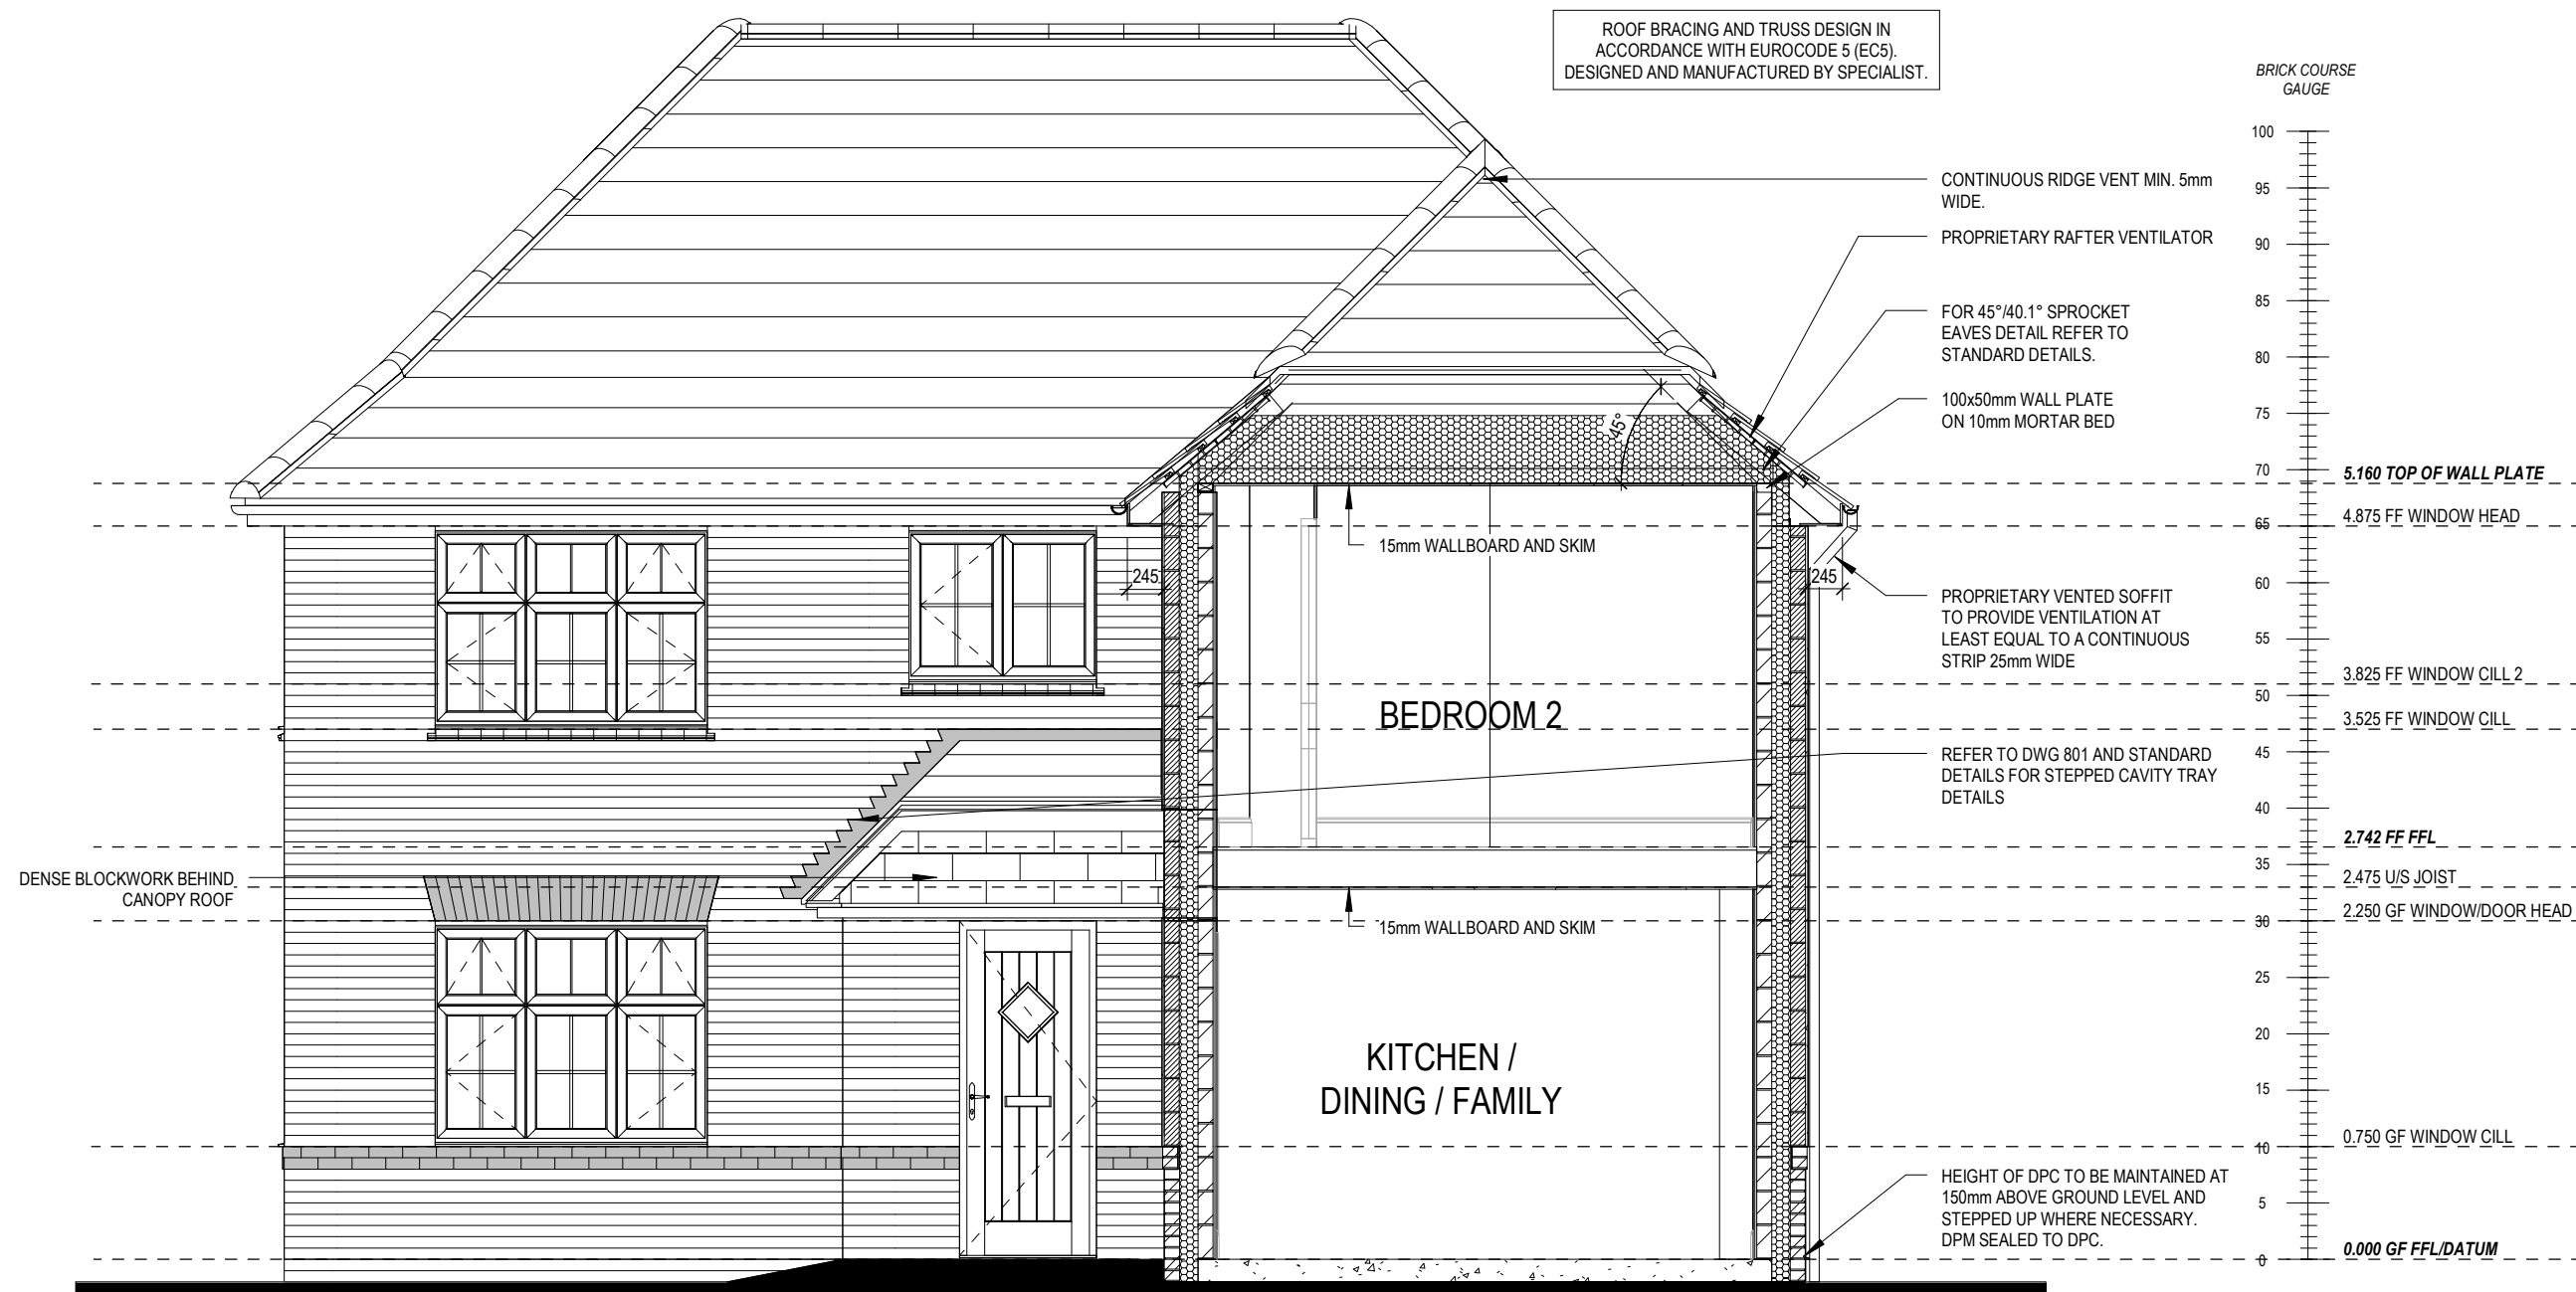

REFER TO SITE SPECIFICATION FOR FLOOR CONSTRUCTION AND FOUNDATION DESIGN. FOUNDATION DEPTH AND DETAIL TO SUIT SITE CONDITIONS AND TO THE SATISFACTION OF LOCAL AUTHORITY AND APPROVED INSPECTOR

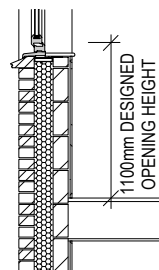

REFER TO TM59 CALCULATION FOR OPENINGS REMOVING EXCESS HEAT. ALL BEDROOM WINDOWS DESIGNED TO 1.1M ABOVE FFL WITH A BUILD TOLERANCE +0/-100MM. WINDOWS WITH LOWER OPENING HEIGHTS ARE EXCLUDED FROM TM59 CALCULATION AND REQUIRED FOR MEANS OF ESCAPE.

PART 'O' COMPLIANCE DIAGRAM Scale: 1:50

Section B-B

Shaftesbury

G SERIES

Dwg No 302

DCC 2

Scale 1:50

Date Feb 2023

Dwg Rev



REFER TO TM59 CALCULATION FOR OPENINGS REMOVING EXCESS HEAT. ALL BEDROOM WINDOWS DESIGNED TO 1.1M ABOVE FFL WITH A BUILD TOLERANCE +0/-100MM. WINDOWS WITH LOWER OPENING HEIGHTS ARE EXCLUDED FROM TM59 CALCULATION AND REQUIRED FOR MEANS OF ESCAPE.




FRONT ELEVATION



SIDE ELEVATION

COMMUNICATIONS PROVIDER ENTRY POINT

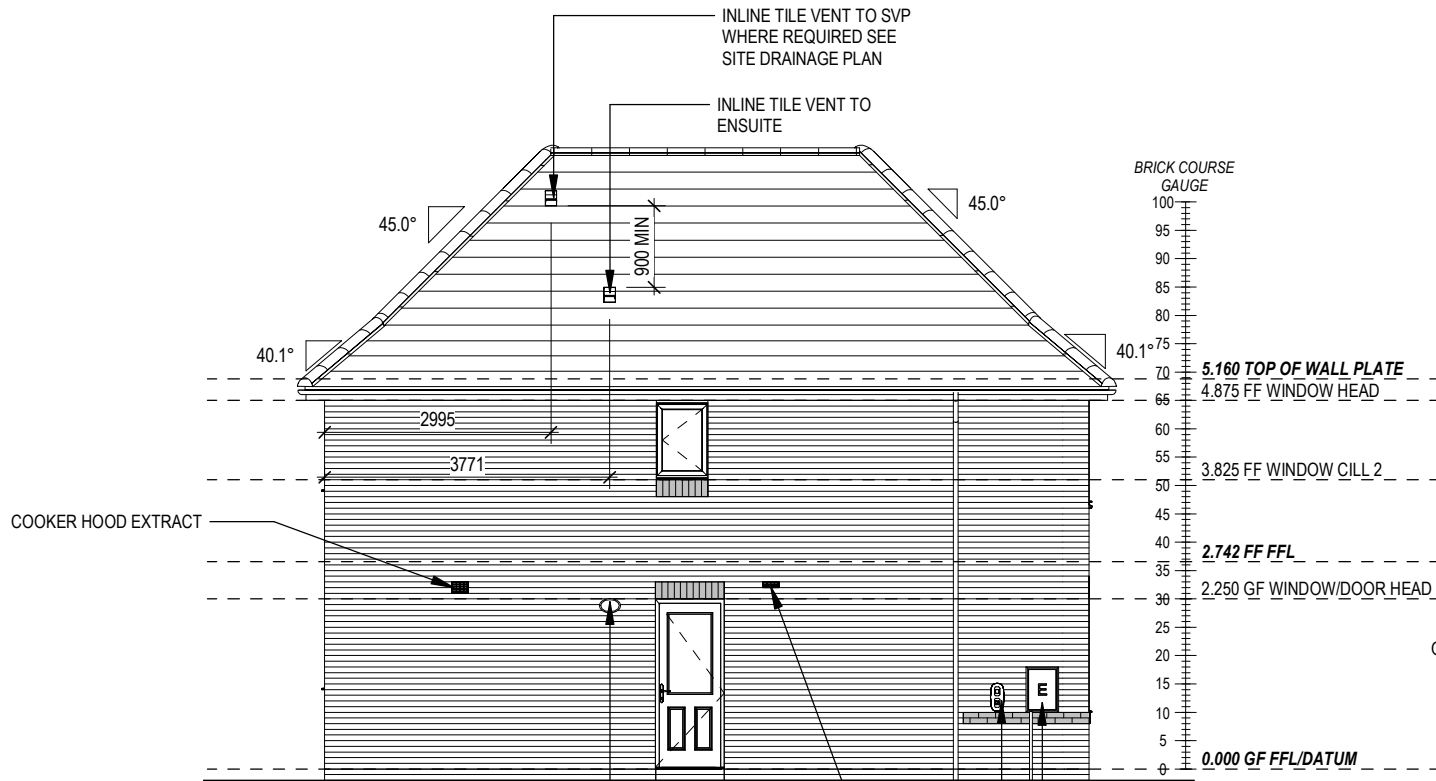


REAR ELEVATION

OPTIONAL EXTERNAL WALL LIGHT

WALL MOUNTED ELECTRIC METER BOX

ELECTRIC VEHICLE CHARGE POINT. SEE SITE SPECIFICATION

UTILITY EXTRACT OUTLET

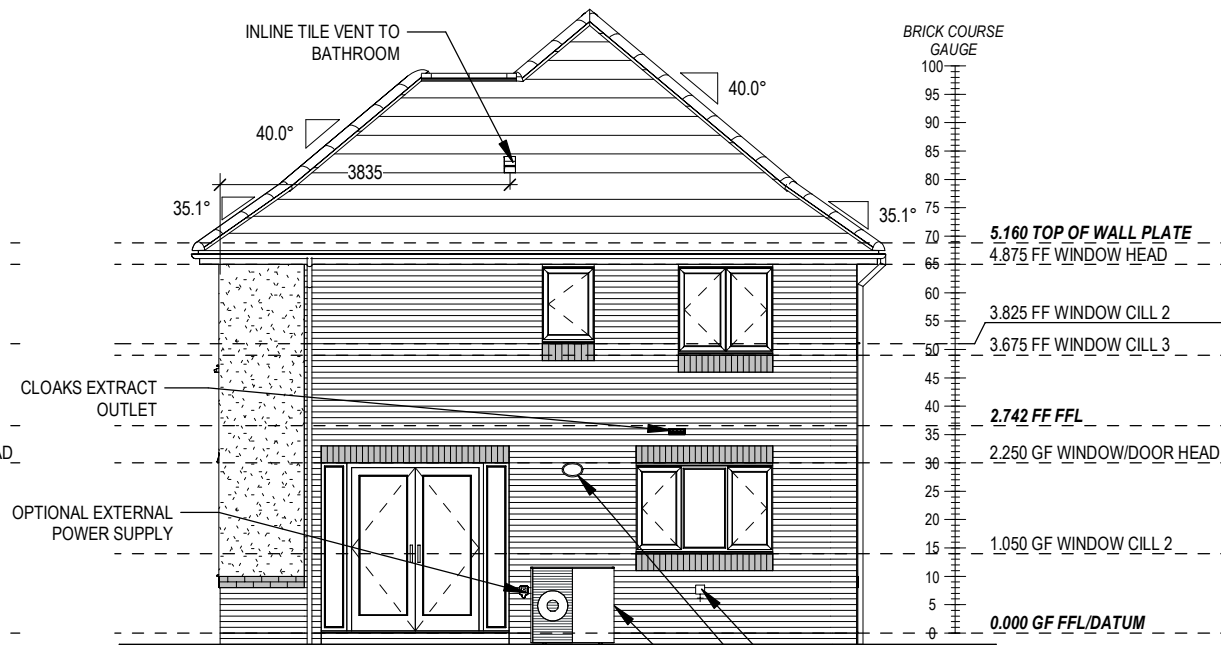

SIDE ELEVATION

OPTIONAL BIB TAP

OPTIONAL EXTERNAL WALL LIGHT

INDICATIVE ASHP - LOCATION MAY VARY DIVISIONAL TECHNICAL TO ADVISE


Dwg No
DCC
Scale
Date

Elevations A1

Shaftesbury


G SERIES



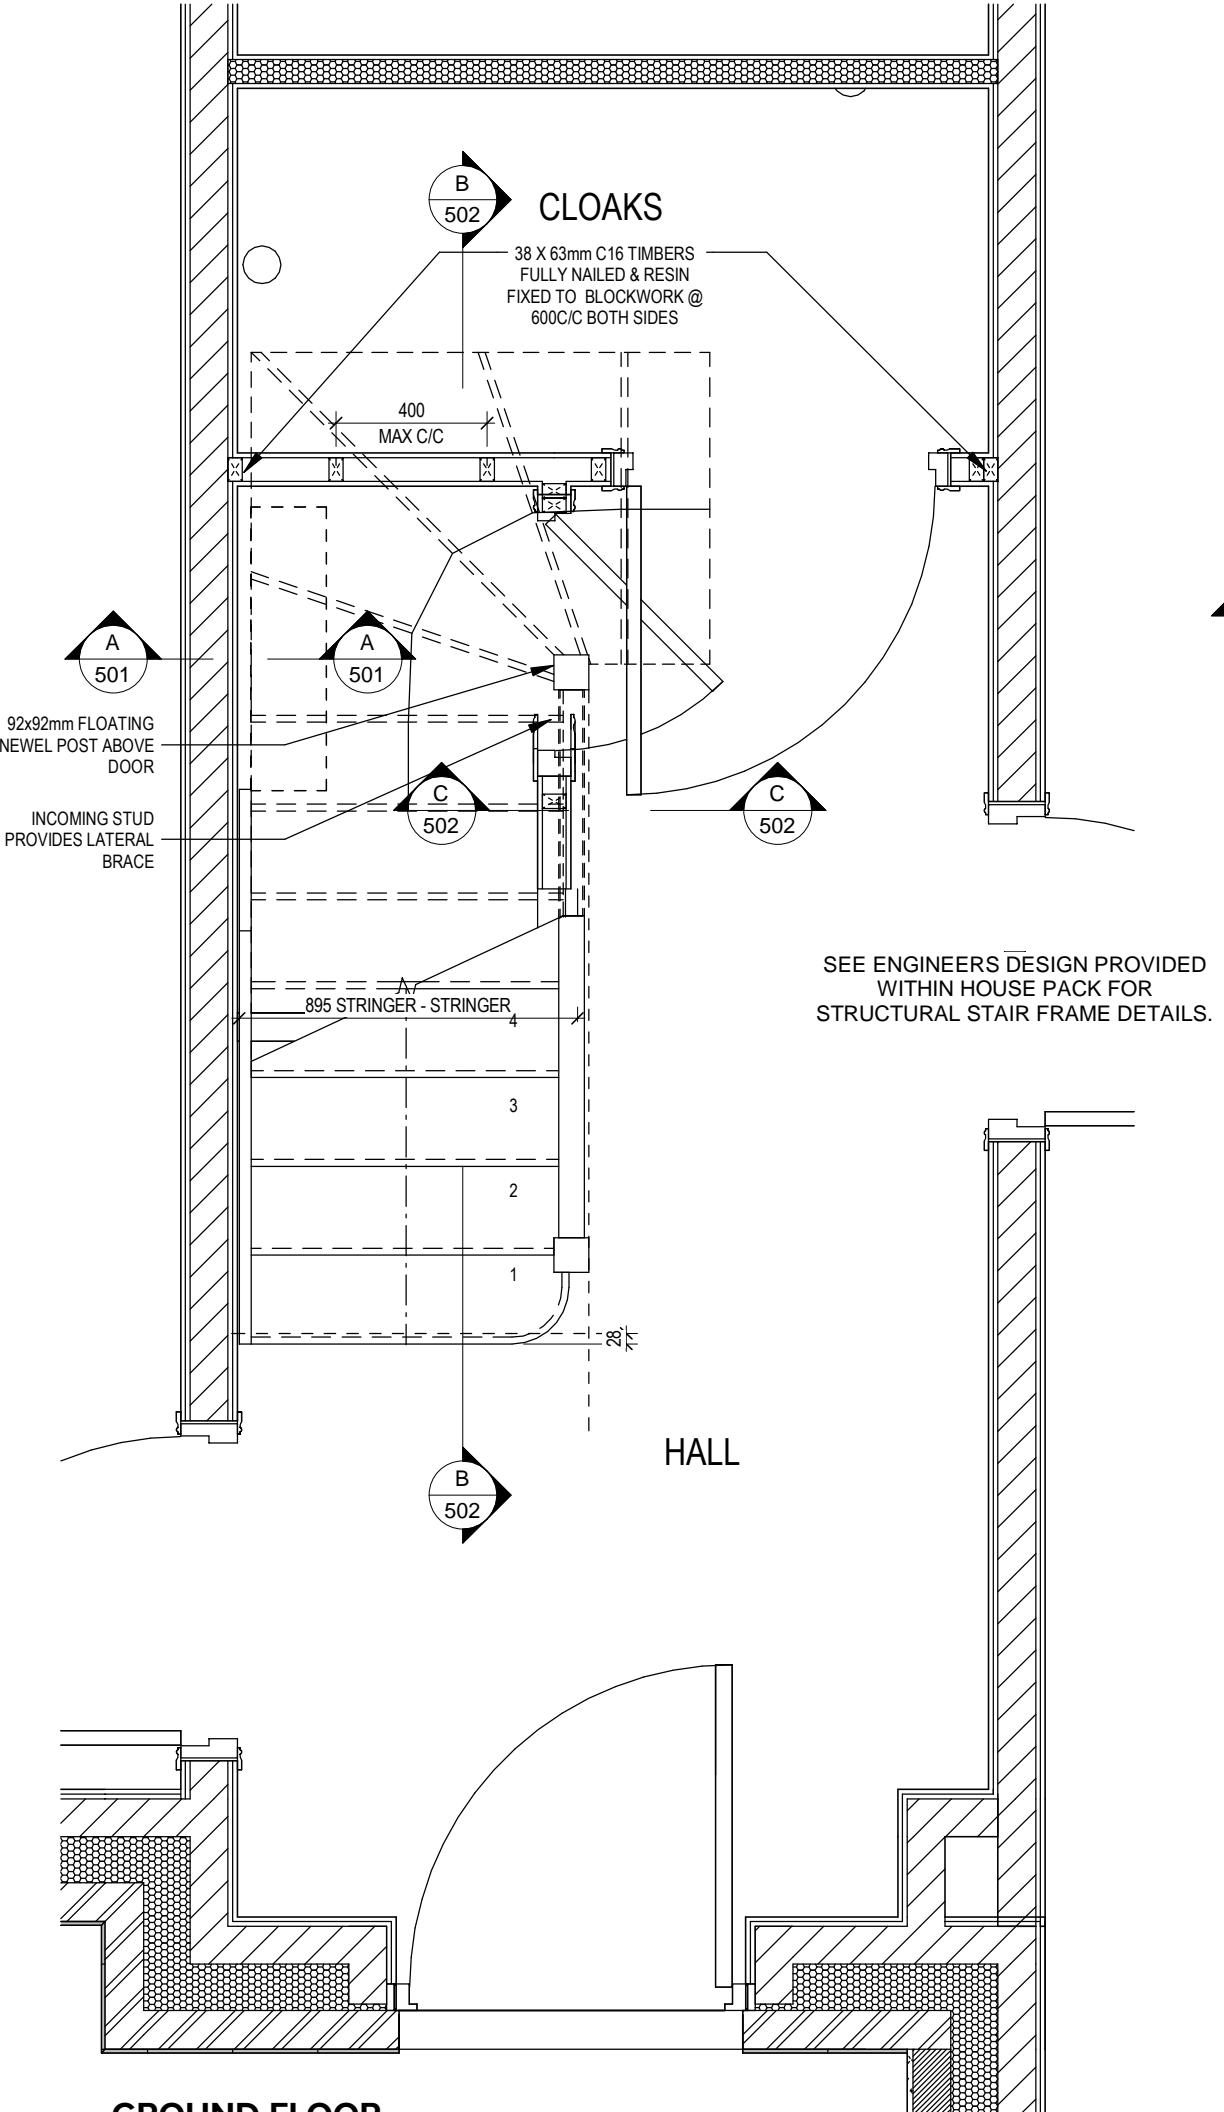

GROUND FLOOR


Scale: 1 : 20

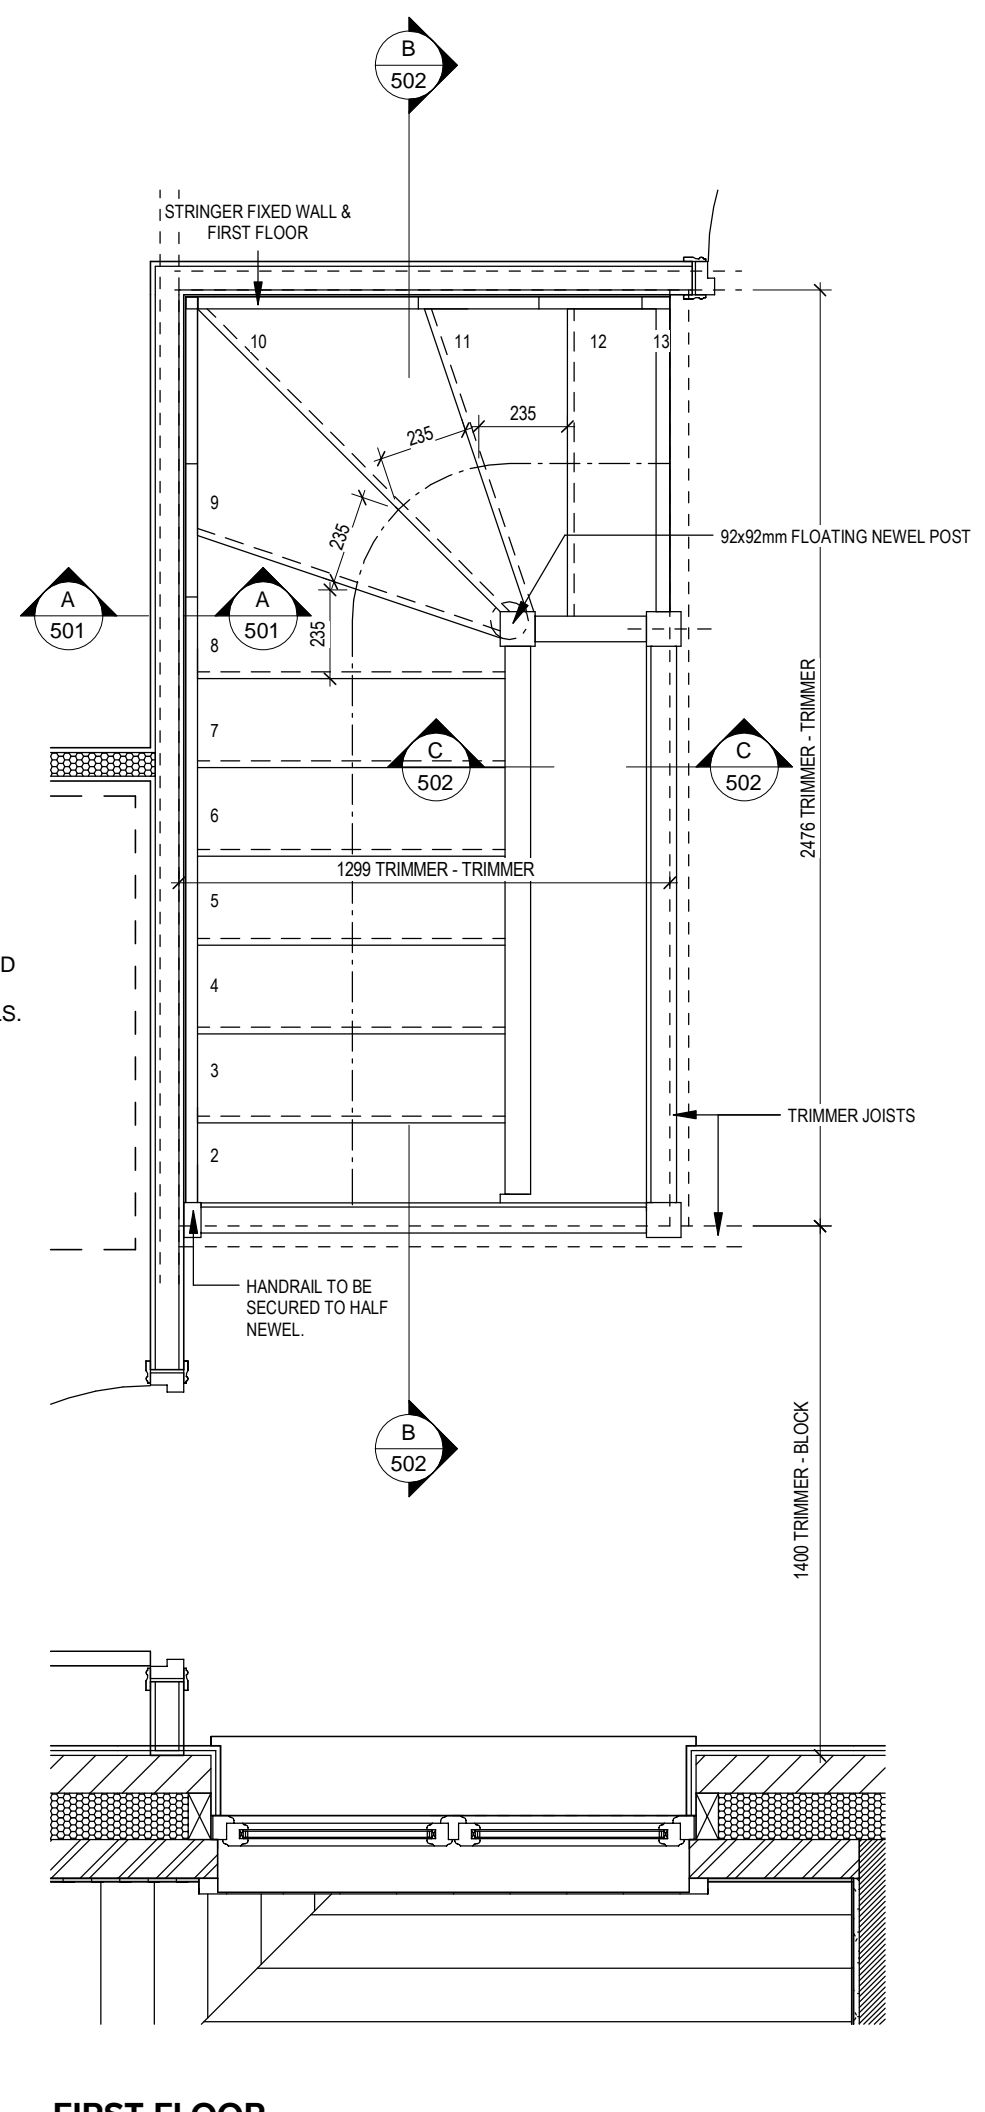

FIRST FLOOR

Scale: 1 : 20

STAIRS SPECIFICATION		
FLOOR - FLOOR	=	2742mm
RISE	=	13No. @ 210.9mm (220mm Max)
GOING	=	235mm (220mm Min)
STRING - STRING	=	SEE DWG
PITCH	=	41.9°
STRINGERS	=	32 x 250mm
NEWEL POSTS	=	92 x 92mm
HANDRAIL 900mm ABOVE NOSING LINE		
BALUSTRADE 900mm ABOVE LANDING FLOOR LEVEL		
VERTICAL BALUSTERS 99mm MAX CLEAR BETWEEN EACH		

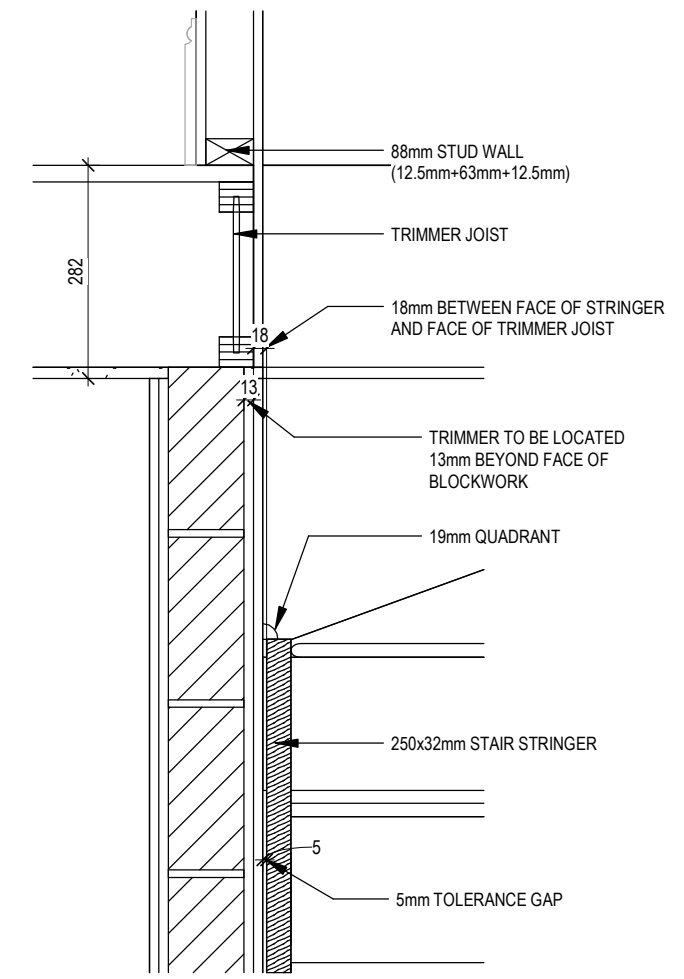


SECTION A-A

Scale: 1 : 10


02/10/23	Stairs tread depths updated, joists amended to suit, path line added	Dwg No	DCC	AS	Indicated Date	Feb 2023	Staircase Details 1 of 2	Shaftesbury	G SERIES
		501	2						
		Dwg Rev							
		A							

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

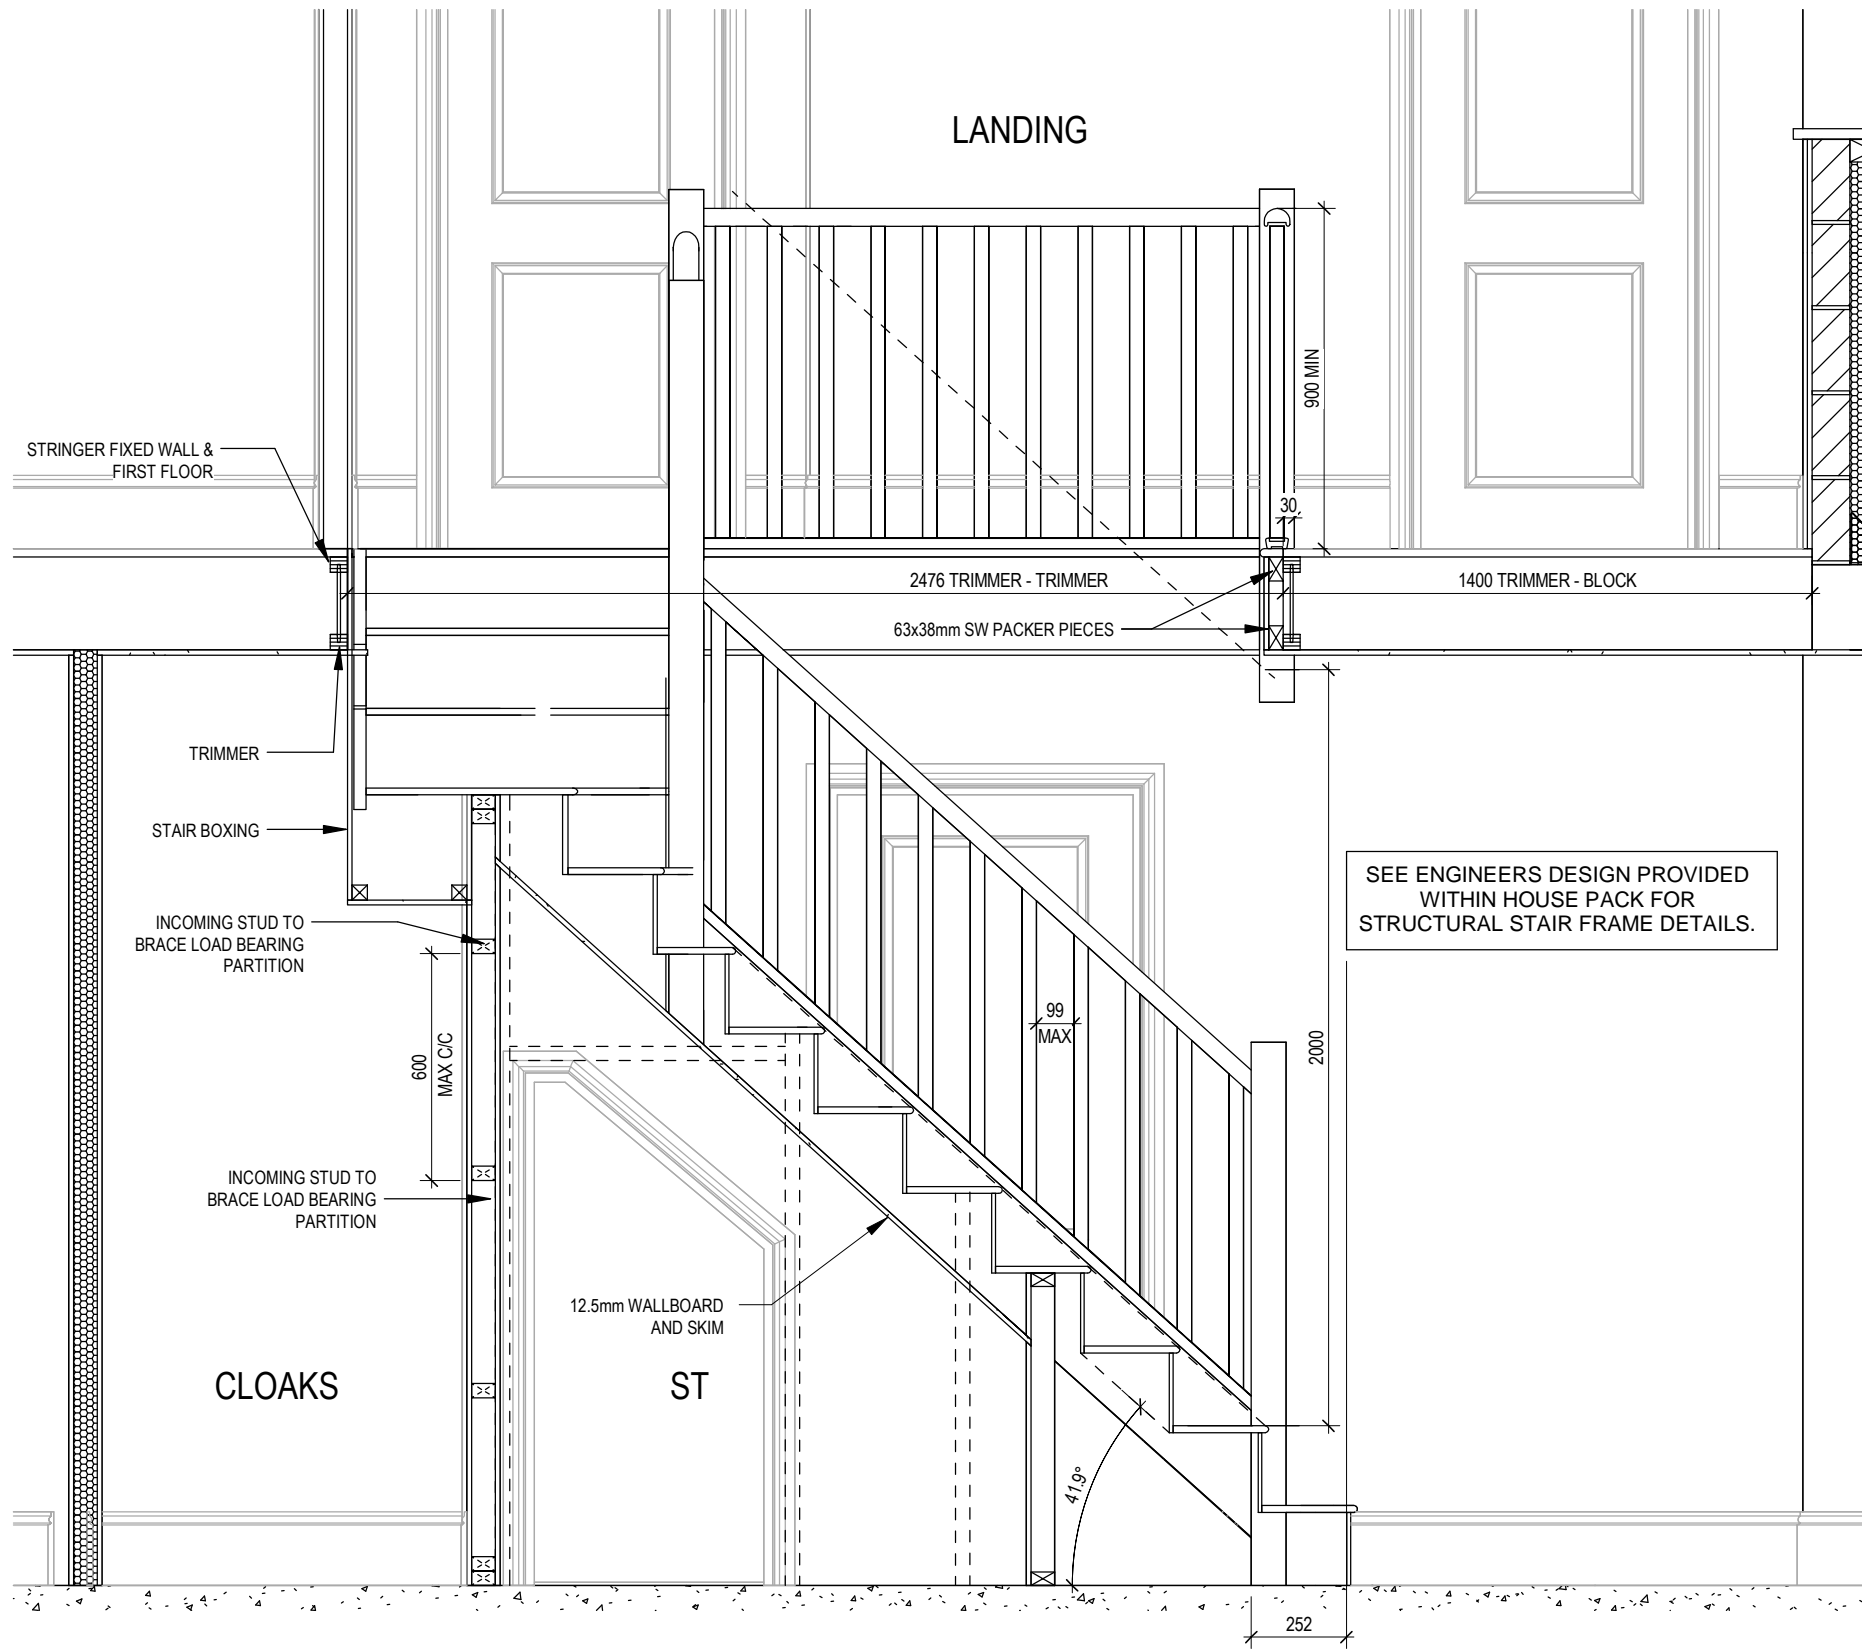
SECTION B-B
Scale: 1 : 20

STAIRS SPECIFICATION	
FLOOR - FLOOR	= 2742mm
RISE	= 13No. @ 210.9mm (220mm Max)
GOING	= 235mm (220mm Min)
STRING - STRING	= SEE DWG
PITCH	= 41.9°
STRINGERS	= 32 x 250mm
NEWEL POSTS	= 92 x 92mm
HANDRAIL 900mm ABOVE NOSING LINE	
BALUSTRADE 900mm ABOVE LANDING FLOOR LEVEL	
VERTICAL BALUSTERS 99mm MAX CLEAR BETWEEN EACH	

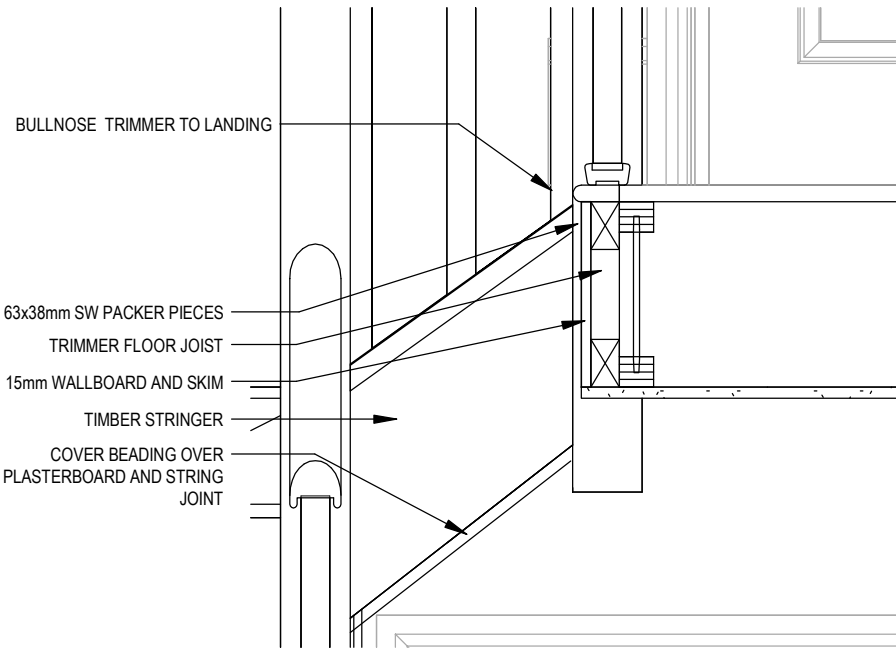

SECTION C-C
Scale: 1 : 10

**Shaftesbury**
G SERIES



Staircase details 2 of 2

Scale	DCC	Dwg No
AS	2	502
Date	Feb 2023	Dwg Rev
		A

A	Stairs tread depths updated, joists amended to suit, path line added	02/10/23
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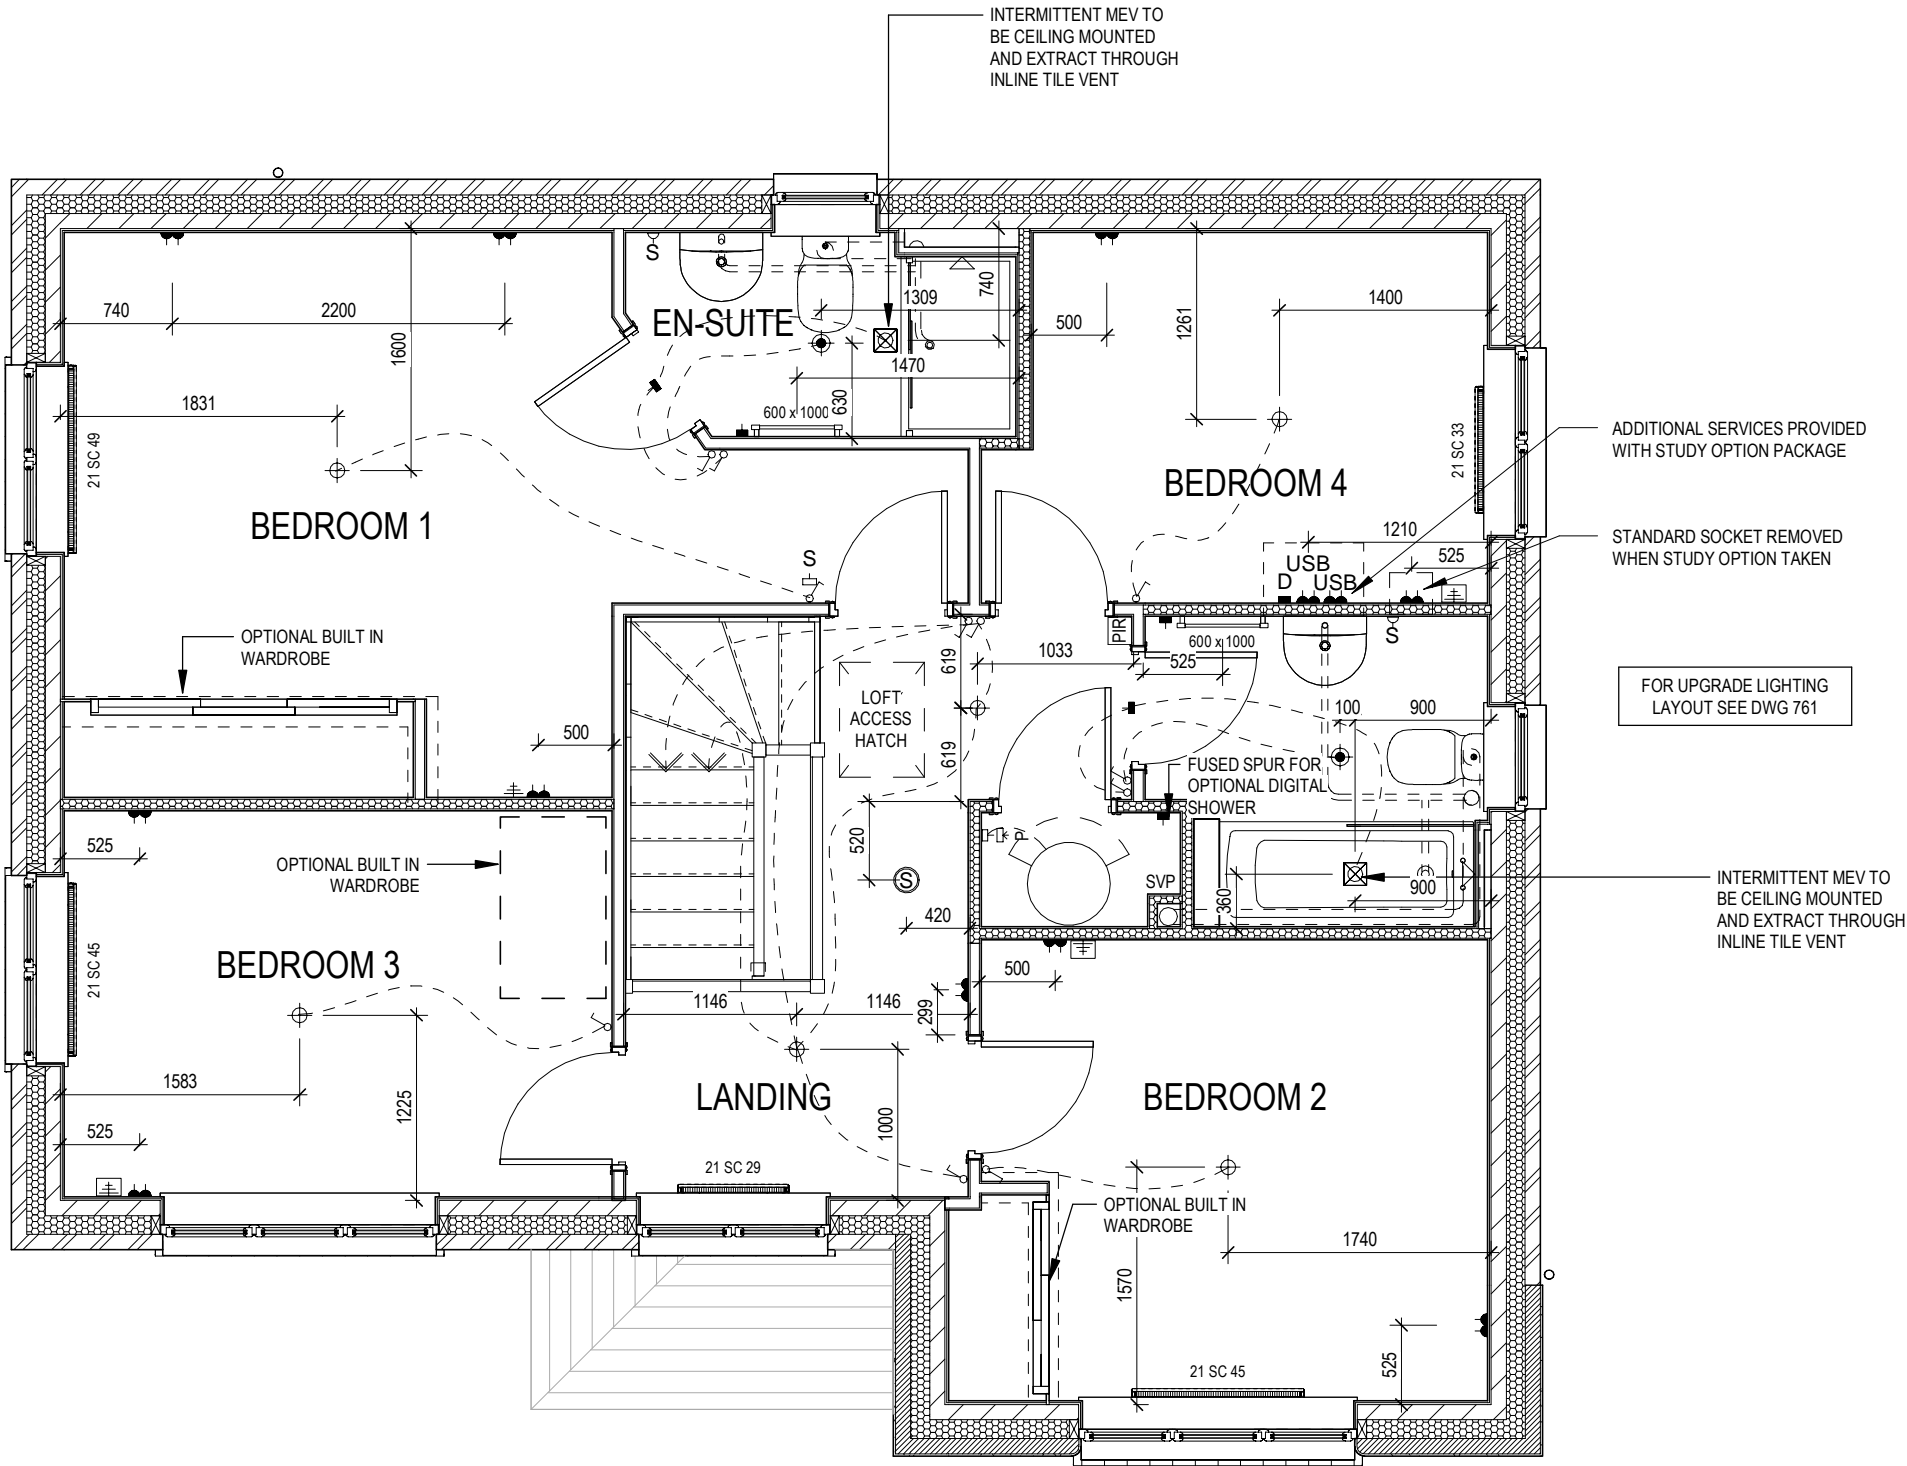
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ELECTRICAL LEGEND



ELECTRICAL LEGEND

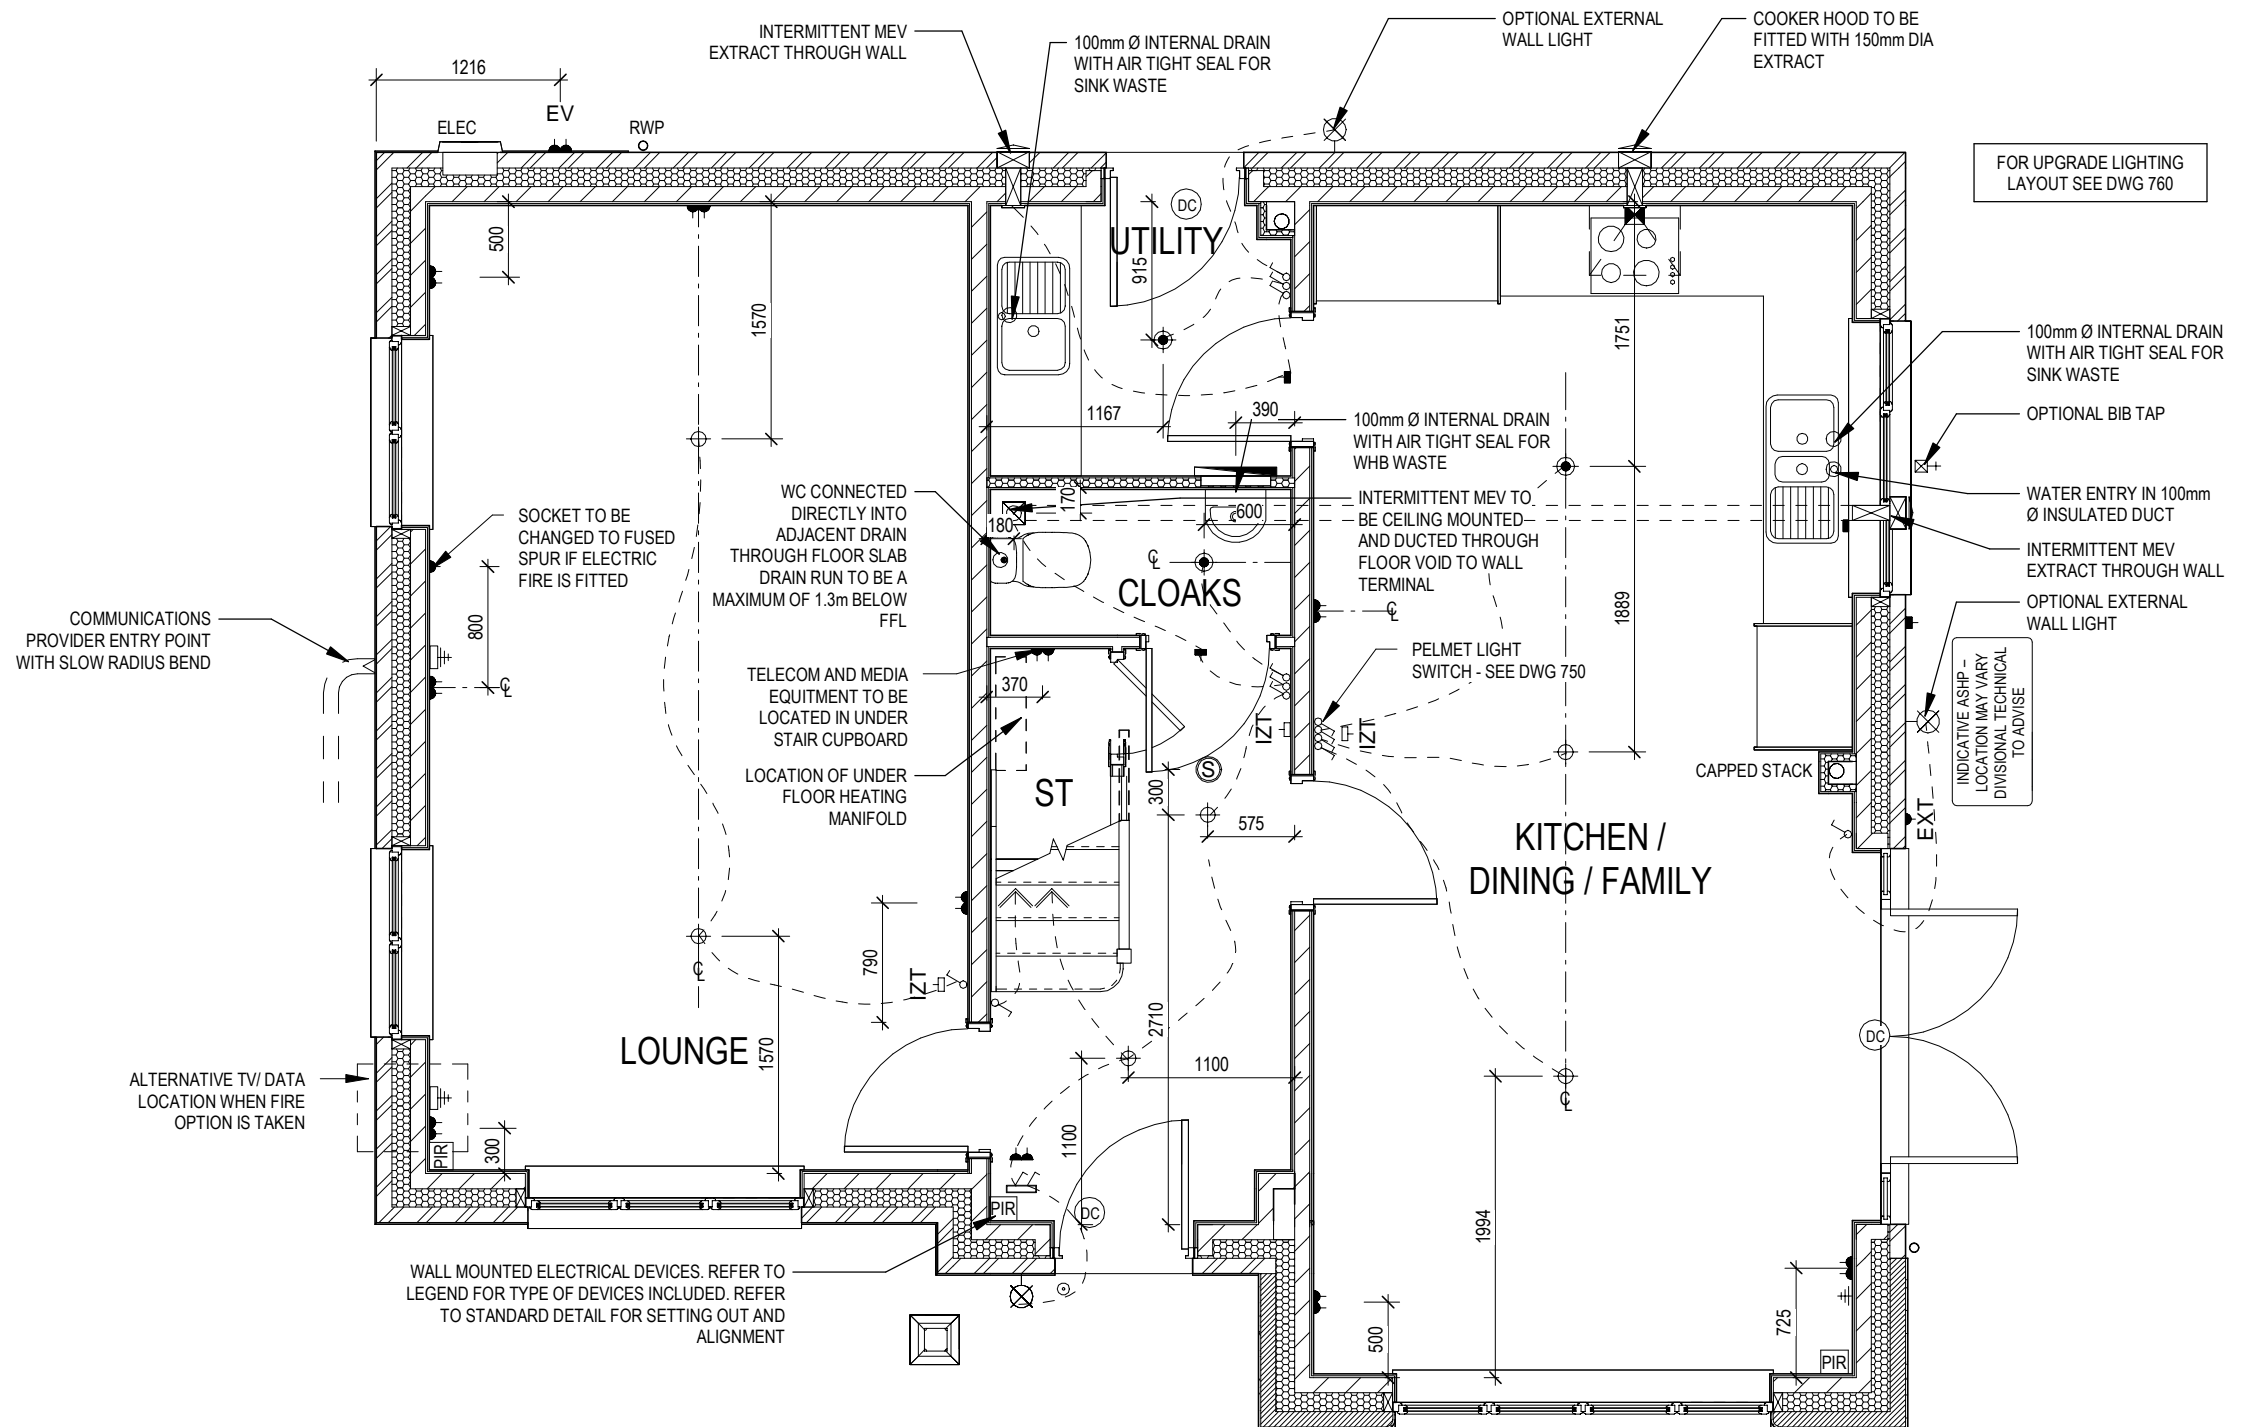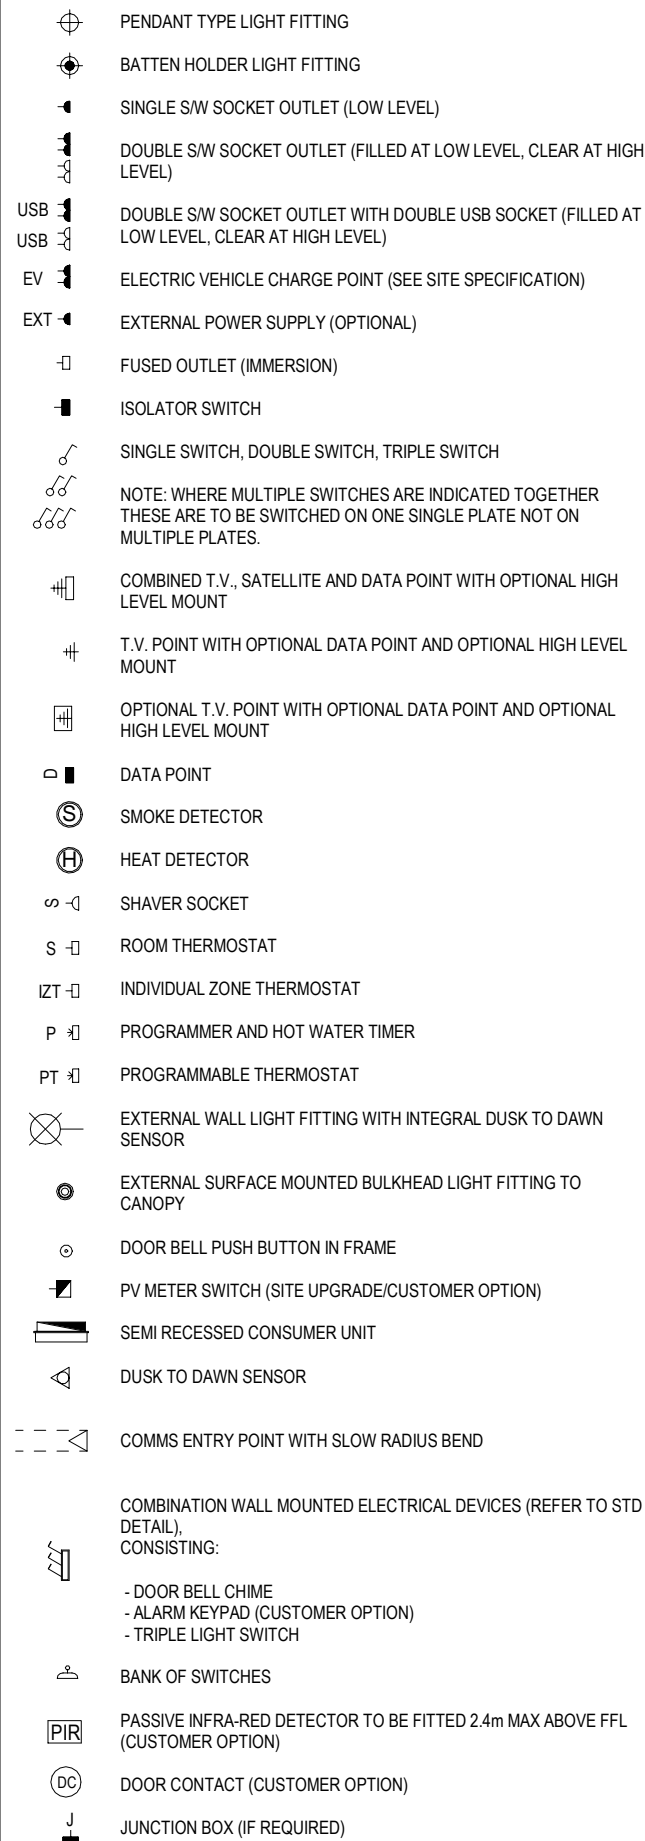	PENDANT TYPE LIGHT FITTING
	BATTEN HOLDER LIGHT FITTING
	SINGLE S/W SOCKET OUTLET (LOW LEVEL)
	DOUBLE S/W SOCKET OUTLET (FILLED AT LOW LEVEL, CLEAR AT HIGH LEVEL)
USB	DOUBLE S/W SOCKET OUTLET WITH DOUBLE USB SOCKET (FILLED AT LOW LEVEL, CLEAR AT HIGH LEVEL)
EV	ELECTRIC VEHICLE CHARGE POINT (SEE SITE SPECIFICATION)
EXT	EXTERNAL POWER SUPPLY (OPTIONAL)
	FUSED OUTLET (IMMERSION)
	ISOLATOR SWITCH
	SINGLE SWITCH, DOUBLE SWITCH, TRIPLE SWITCH
	NOTE: WHERE MULTIPLE SWITCHES ARE INDICATED TOGETHER THESE ARE TO BE SWITCHED ON ONE SINGLE PLATE NOT ON MULTIPLE PLATES.
	COMBINED T.V., SATELLITE AND DATA POINT WITH OPTIONAL HIGH LEVEL MOUNT
	T.V. POINT WITH OPTIONAL DATA POINT AND OPTIONAL HIGH LEVEL MOUNT
	OPTIONAL T.V. POINT WITH OPTIONAL DATA POINT AND OPTIONAL HIGH LEVEL MOUNT
D	DATA POINT
	SMOKE DETECTOR
H	HEAT DETECTOR
S	SHAVER SOCKET
S	ROOM THERMOSTAT
IZT	INDIVIDUAL ZONE THERMOSTAT
P	PROGRAMMER AND HOT WATER TIMER
PT	PROGRAMMABLE THERMOSTAT
	EXTERNAL WALL LIGHT FITTING WITH INTEGRAL DUSK TO DAWN SENSOR
	EXTERNAL SURFACE MOUNTED BULKHEAD LIGHT FITTING TO CANOPY
	DOOR BELL PUSH BUTTON IN FRAME
	PV METER SWITCH (SITE UPGRADE/CUSTOMER OPTION)
	SEMI RECESSED CONSUMER UNIT
	DUSK TO DAWN SENSOR
	COMMS ENTRY POINT WITH SLOW RADIUS BEND
	COMBINATION WALL MOUNTED ELECTRICAL DEVICES (REFER TO STD DETAIL), CONSISTING: - DOOR BELL CHIME - ALARM KEYPAD (CUSTOMER OPTION) - TRIPLE LIGHT SWITCH
	BANK OF SWITCHES
PIR	PASSIVE INFRA-RED DETECTOR TO BE FITTED 2.4m MAX ABOVE FFL (CUSTOMER OPTION)
DC	DOOR CONTACT (CUSTOMER OPTION)
	JUNCTION BOX (IF REQUIRED)



Shaftesbury


G SERIES

Services Layout First Floor

Dwg No	DCC	Scale	Date
602	2	1 : 50	Feb 2023
Dwg Rev			

ELECTRICAL LEGEND

- PENDANT TYPE LIGHT FITTING
- BATTEN HOLDER LIGHT FITTING
- SINGLE S/W SOCKET OUTLET (LOW LEVEL)
- DOUBLE S/W SOCKET OUTLET (FILLED AT LOW LEVEL, CLEAR AT HIGH LEVEL)
- DOUBLE S/W SOCKET OUTLET WITH DOUBLE USB SOCKET (FILLED AT LOW LEVEL, CLEAR AT HIGH LEVEL)
- ELECTRIC VEHICLE CHARGE POINT (SEE SITE SPECIFICATION)
- EXTERNAL POWER SUPPLY (OPTIONAL)
- FUSED OUTLET (IMMERSION)
- ISOLATOR SWITCH
- SINGLE SWITCH, DOUBLE SWITCH, TRIPLE SWITCH
- NOTE: WHERE MULTIPLE SWITCHES ARE INDICATED TOGETHER THESE ARE TO BE SWITCHED ON ONE SINGLE PLATE NOT ON MULTIPLE PLATES.
- COMBINED T.V., SATELLITE AND DATA POINT WITH OPTIONAL HIGH LEVEL MOUNT
- T.V. POINT WITH OPTIONAL DATA POINT AND OPTIONAL HIGH LEVEL MOUNT
- OPTIONAL T.V. POINT WITH OPTIONAL DATA POINT AND OPTIONAL HIGH LEVEL MOUNT
- DATA POINT
- SMOKE DETECTOR
- HEAT DETECTOR
- SHAVER SOCKET
- ROOM THERMOSTAT
- INDIVIDUAL ZONE THERMOSTAT
- PROGRAMMER AND HOT WATER TIMER
- EXTERNAL WALL LIGHT FITTING WITH INTEGRAL DUSK TO DAWN SENSOR
- EXTERNAL SURFACE MOUNTED BULKHEAD LIGHT FITTING TO CANOPY
- DOOR BELL PUSH BUTTON IN FRAME
- PV METER SWITCH (SITE UPGRADE/CUSTOMER OPTION)
- SEMI RECESSED CONSUMER UNIT
- DUSK TO DAWN SENSOR
- COMMS ENTRY POINT WITH SLOW RADIUS BEND
- COMBINATION WALL MOUNTED ELECTRICAL DEVICES (REFER TO STD DETAIL), CONSISTING:
- DOOR BELL CHIME
- ALARM KEYPAD (CUSTOMER OPTION)
- TRIPLE LIGHT SWITCH
- BANK OF SWITCHES
- PASSIVE INFRA-RED DETECTOR TO BE FITTED 2.4m MAX ABOVE FFL (CUSTOMER OPTION)
- DOOR CONTACT (CUSTOMER OPTION)

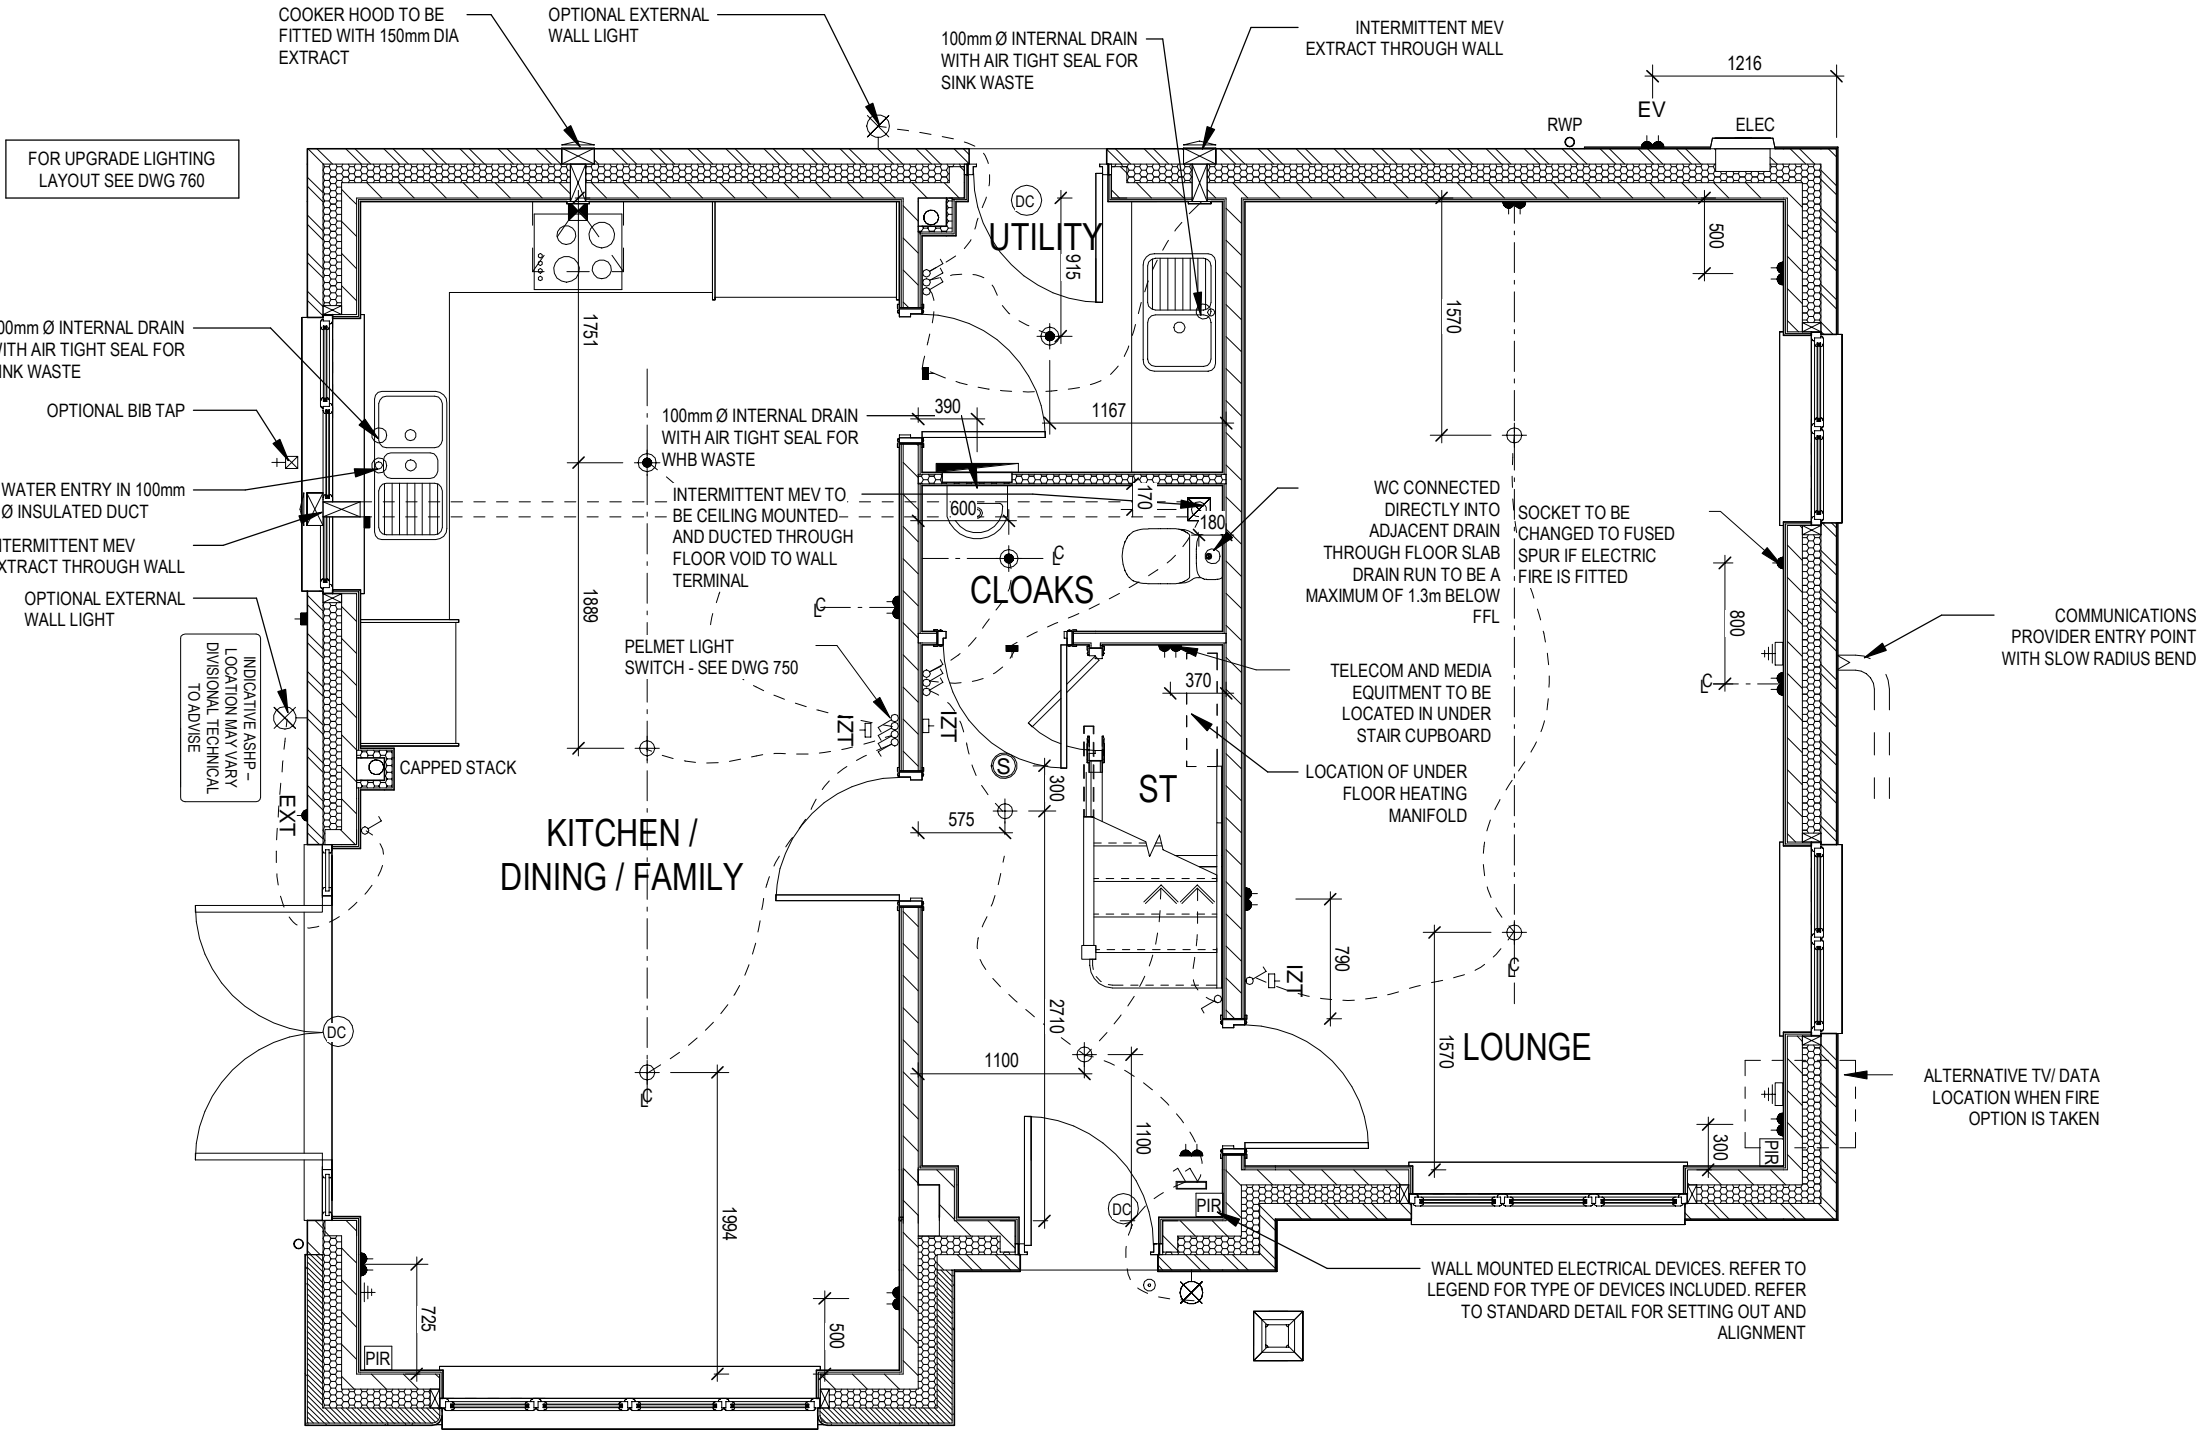

OPPOSITE


	Shaftesbury G SERIES	Services Layout Ground Floor - Opp			Dwg No 611	Date Feb 2023
					DCC 2	Dwg Rev A
		Scale 1 : 50				

Date 3

PIR added in Hall

ELECTRICAL LEGEND

- PENDANT TYPE LIGHT FITTING
- BATTEN HOLDER LIGHT FITTING
- SINGLE S/W SOCKET OUTLET (LOW LEVEL)
- DOUBLE S/W SOCKET OUTLET (FILLED AT LOW LEVEL, CLEAR AT HIGH LEVEL)
- DOUBLE S/W SOCKET OUTLET WITH DOUBLE USB SOCKET (FILLED AT LOW LEVEL, CLEAR AT HIGH LEVEL)
- ELECTRIC VEHICLE CHARGE POINT (SEE SITE SPECIFICATION)
- EXTERNAL POWER SUPPLY (OPTIONAL)
- FUSED OUTLET (IMMERSSION)
- ISOLATOR SWITCH
- SINGLE SWITCH, DOUBLE SWITCH, TRIPLE SWITCH
- NOTE: WHERE MULTIPLE SWITCHES ARE INDICATED TOGETHER THESE ARE TO BE SWITCHED ON ONE SINGLE PLATE NOT ON MULTIPLE PLATES.
- COMBINED T.V., SATELLITE AND DATA POINT WITH OPTIONAL HIGH LEVEL MOUNT
- T.V. POINT WITH OPTIONAL DATA POINT AND OPTIONAL HIGH LEVEL MOUNT
- OPTIONAL T.V. POINT WITH OPTIONAL DATA POINT AND OPTIONAL HIGH LEVEL MOUNT
- DATA POINT
- SMOKE DETECTOR
- HEAT DETECTOR
- SHAVER SOCKET
- ROOM THERMOSTAT
- INDIVIDUAL ZONE THERMOSTAT
- PROGRAMMER AND HOT WATER TIMER
- EXTERNAL WALL LIGHT FITTING WITH INTEGRAL DUSK TO DAWN SENSOR
- EXTERNAL SURFACE MOUNTED BULKHEAD LIGHT FITTING TO CANOPY
- DOOR BELL PUSH BUTTON IN FRAME
- PV METER SWITCH (SITE UPGRADE/CUSTOMER OPTION)
- SEMI RECESSED CONSUMER UNIT
- DUSK TO DAWN SENSOR
- COMMS ENTRY POINT WITH SLOW RADIUS BEND
- COMBINATION WALL MOUNTED ELECTRICAL DEVICES (REFER TO STD DETAIL), CONSISTING:
- DOOR BELL CHIME
- ALARM KEYPAD (CUSTOMER OPTION)
- TRIPLE LIGHT SWITCH
- BANK OF SWITCHES
- PASSIVE INFRA-RED DETECTOR TO BE FITTED 2.4m MAX ABOVE FFL (CUSTOMER OPTION)
- DOOR CONTACT (CUSTOMER OPTION)

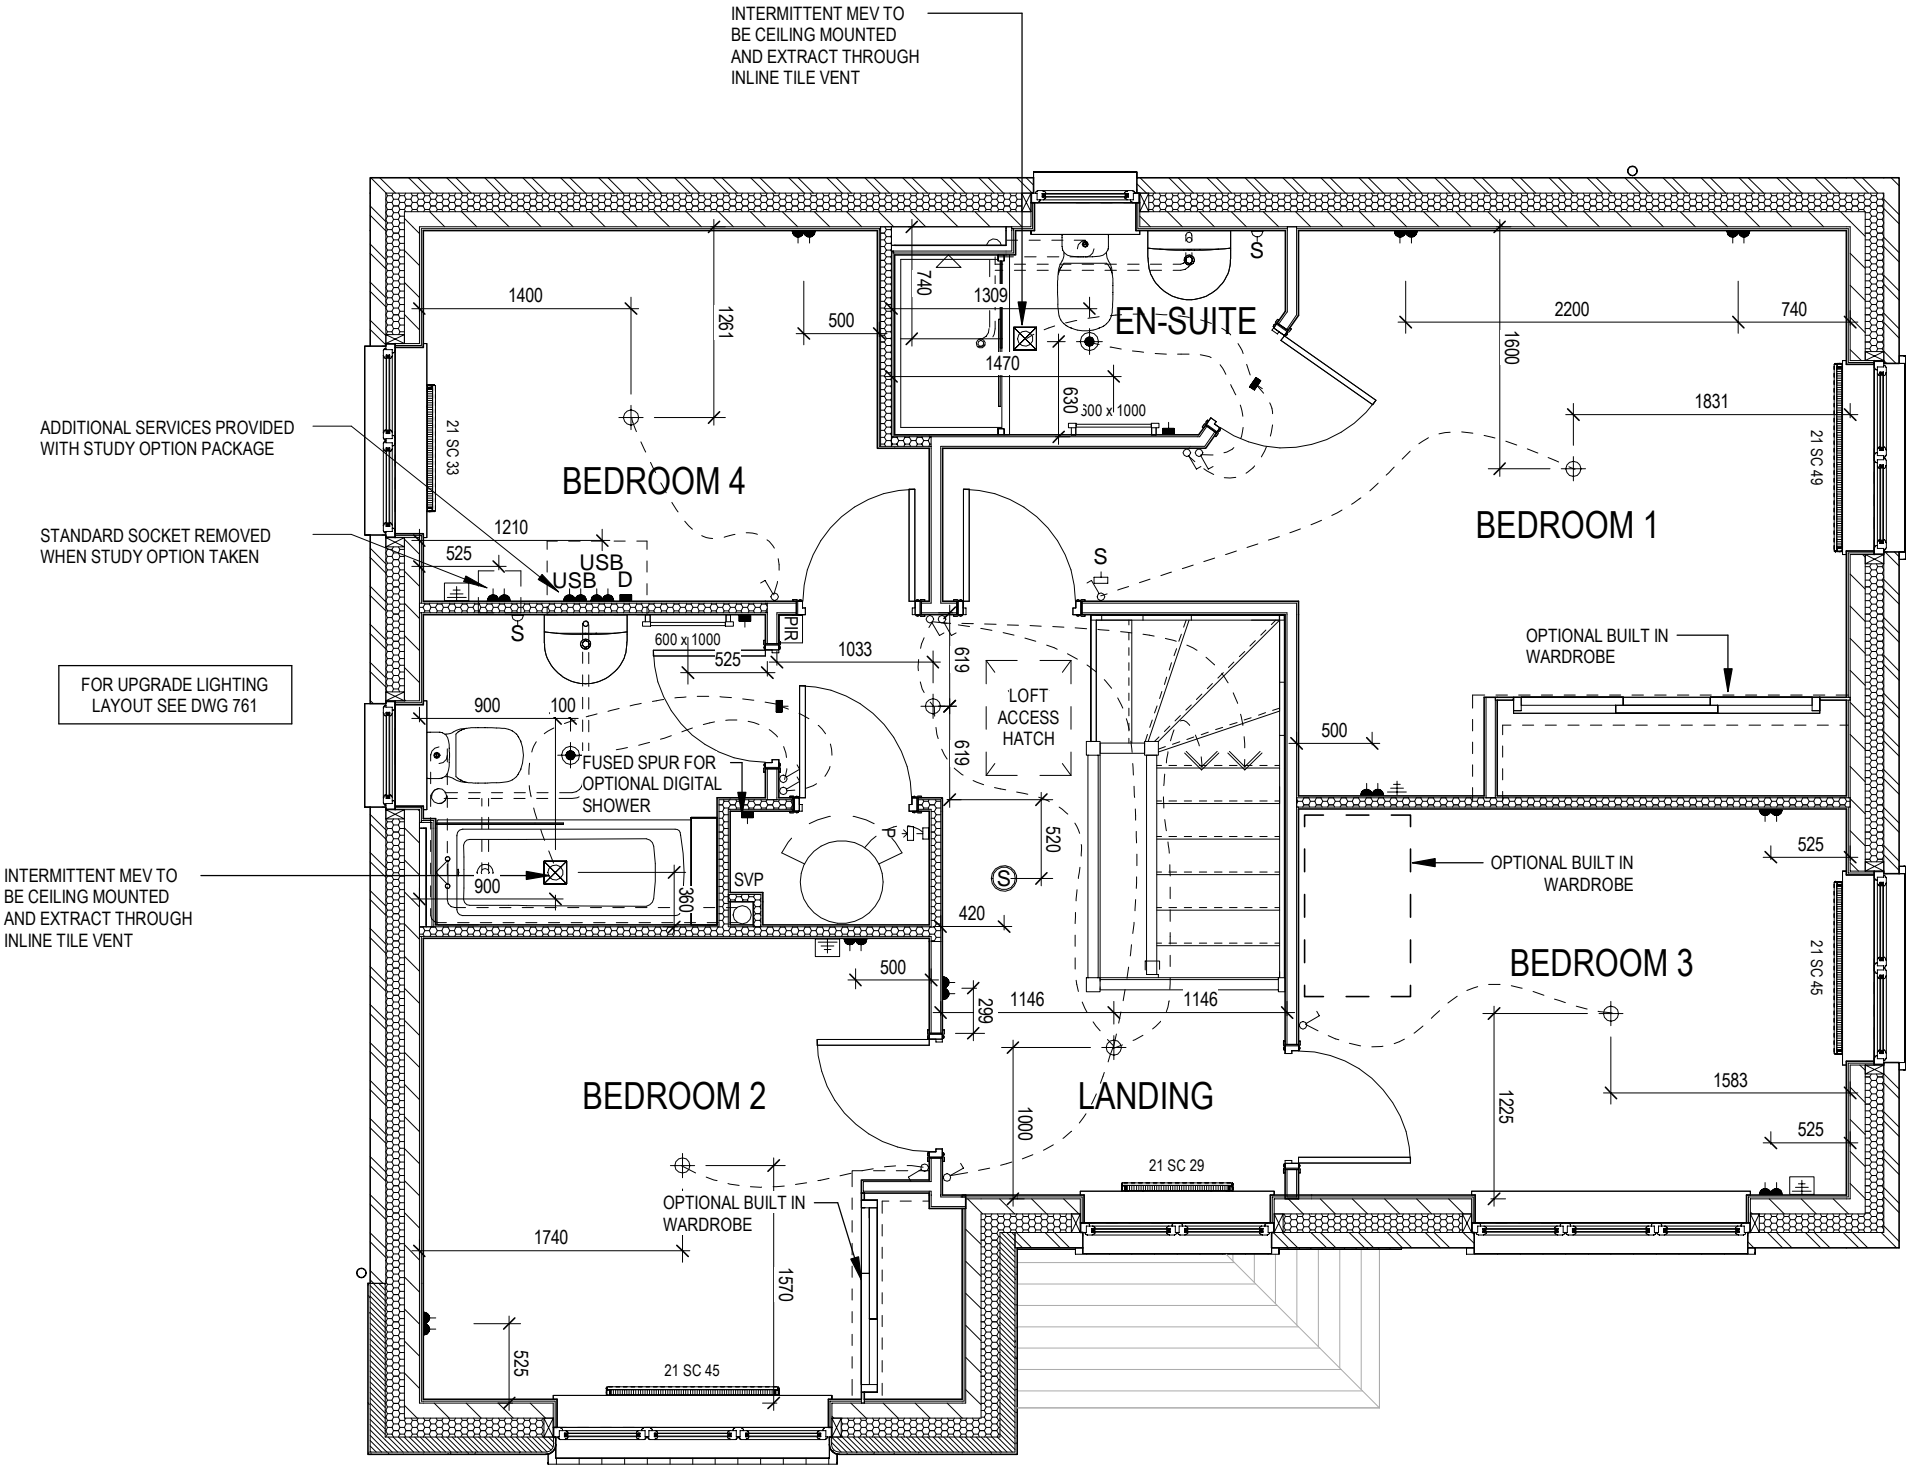

OPPOSITE

Shaftesbury

G SERIES

Services Layout First Floor - Opp

DCC

Scale 1 : 50



Dwg No 612


Dwg Rev





Date Feb 2023


This drawing must be read in conjunction with relevant Redrow specifications, standard details & structural calculations. All dimension are taken from face of Brick/Block & Studwork. This drawing is subject to copyright law. Do Not Scale Off This Drawing.

ELECTRICAL LEGEND


-  FUSED OUTLET (IMMERSION)
-  ISOLATOR SWITCH
- UFH

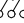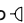


OPTIONAL ELECTRIC UNDER FLOOR HEATING WITH CONTROLLER AND STAT
-  SINGLE SWITCH
-  DOUBLE SWITCH
-  TRIPLE SWITCH
- NOTE: WHERE MULTIPLE SWITCHES ARE INDICATED TOGETHER THESE ARE TO BE SWITCHED ON ONE SINGLE PLATE NOT ON MULTIPLE PLATES.
-  SHAVER SOCKET


 OPTIONAL DIGITAL SHOWER SWITCH

IZT

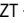


INDIVIDUAL ZONE THERMOSTAT

 JUNCTION BOX (IF REQUIRED)

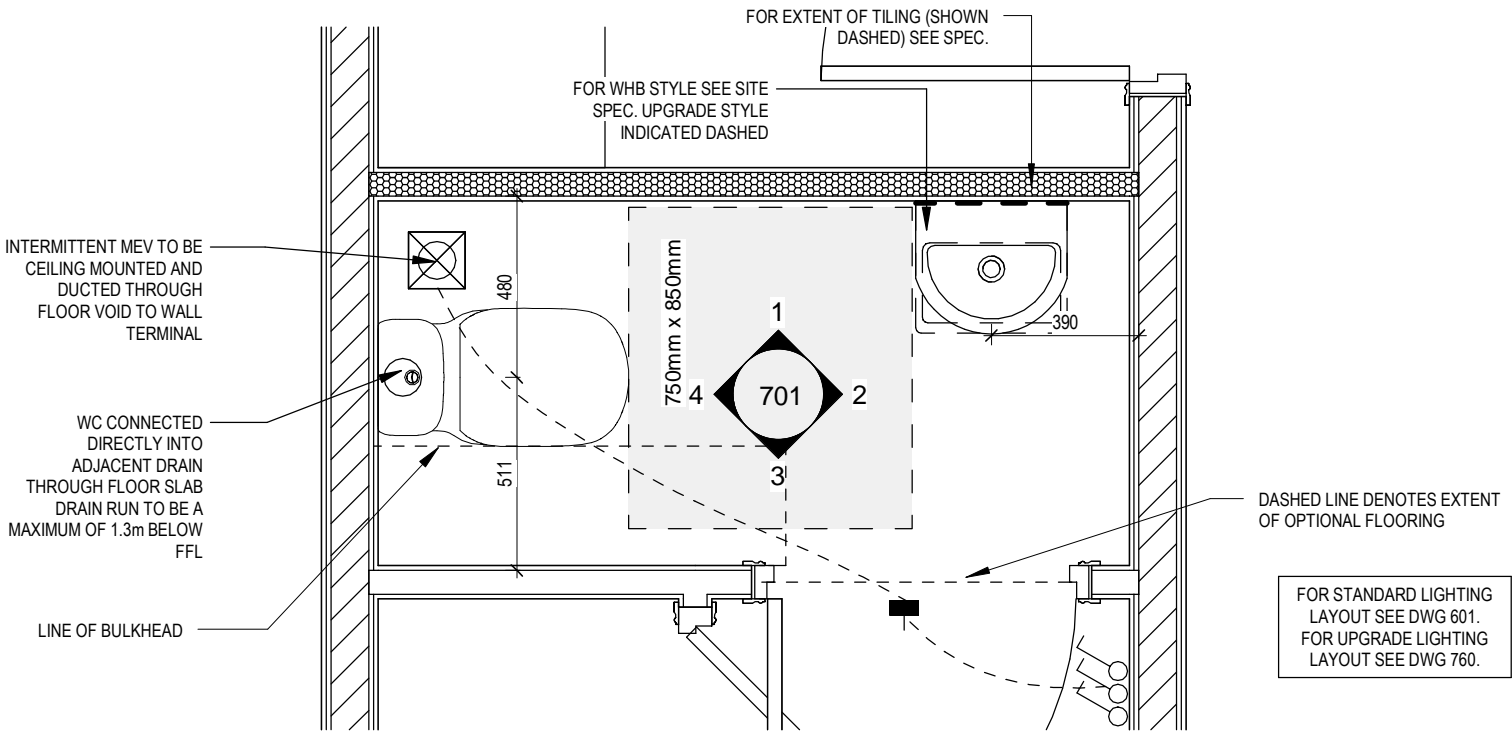


CLOAKS LAYOUT

Scale: 1 : 20

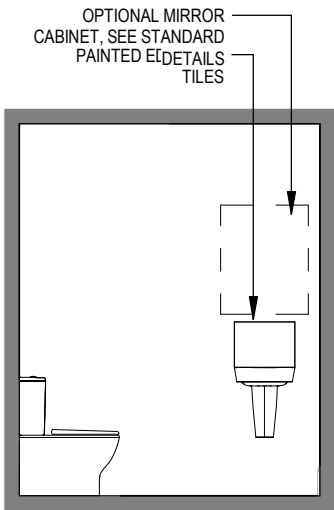


VIEW 1


Scale: 1 : 50

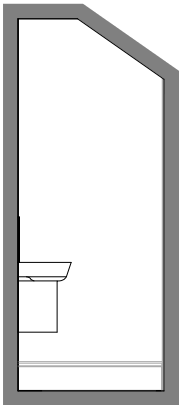

VIEW 2

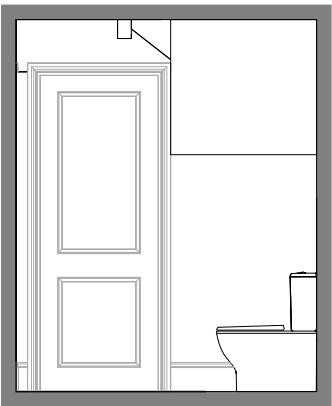

VIEW 3

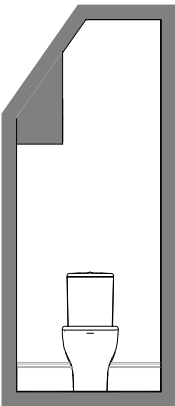

VIEW 4



Shaftesbury

G SERIES

Cloaks Details

Scale	DCC	Dwg No
As indicated	2	701
Date		Dwg Rev
Feb 2023		

ELECTRICAL LEGEND

- ⏏

FUSED OUTLET (IMMERSION)
- ISOLATOR SWITCH
- UFH

OPTIONAL ELECTRIC UNDER FLOOR HEATING WITH CONTROLLER AND STAT
- ⏏

SINGLE SWITCH
- ⏏

DOUBLE SWITCH
- ⏏

TRIPLE SWITCH
- NOTE: WHERE MULTIPLE SWITCHES ARE INDICATED TOGETHER THESE ARE TO BE SWITCHED ON ONE SINGLE PLATE NOT ON MULTIPLE PLATES.
- ⏏

SHAVER SOCKET
- Di

OPTIONAL DIGITAL SHOWER SWITCH
- IZT

INDIVIDUAL ZONE THERMOSTAT
- J

JUNCTION BOX (IF REQUIRED)


DASHED LINE INDICATES EXTENT OF OPTIONAL FLOORING

FOR STANDARD LIGHTING LAYOUT SEE DWG 602.
FOR UPGRADE LIGHTING LAYOUT SEE DWG 761.

FULLY TILED BOXING 150mm ABOVE BATH


BATHROOM LAYOUT

Scale: 1 : 20

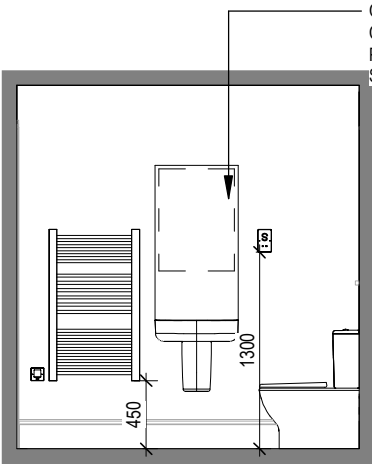


VIEW 1


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VIEW 2

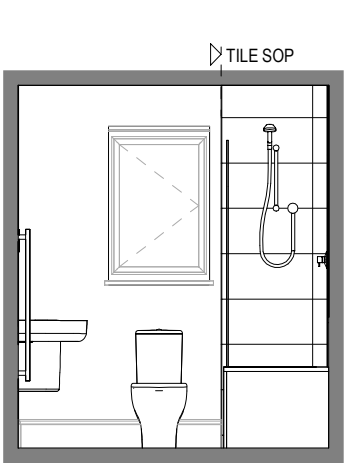

VIEW 3

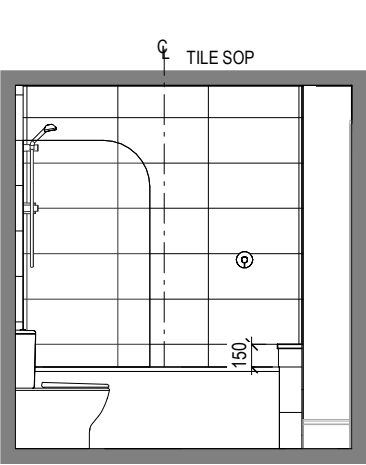

VIEW 4

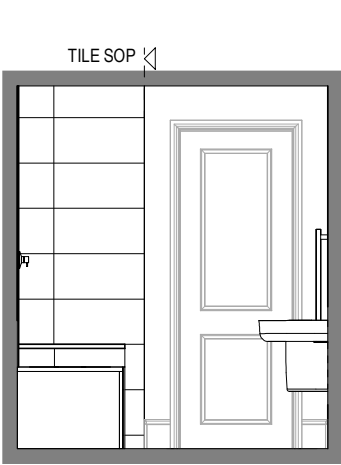Shaftesbury

G SERIES

Bathroom Details

DCC

Scale

As indicated

Date

Feb 2023

Dwg No



702


Dwg Rev




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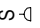
REDROW

ELECTRICAL LEGEND


-  FUSED OUTLET (IMMERSION)
-  ISOLATOR SWITCH
- UFH

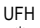


OPTIONAL ELECTRIC UNDER FLOOR HEATING WITH CONTROLLER AND STAT
-  SINGLE SWITCH
-  DOUBLE SWITCH
-  TRIPLE SWITCH
- NOTE: WHERE MULTIPLE SWITCHES ARE INDICATED TOGETHER THESE ARE TO BE SWITCHED ON ONE SINGLE PLATE NOT ON MULTIPLE PLATES.
- S

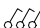


SHAVER SOCKET
- Di

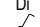


OPTIONAL DIGITAL SHOWER SWITCH
- IZT

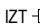

INDIVIDUAL ZONE THERMOSTAT
- J




JUNCTION BOX (IF REQUIRED)

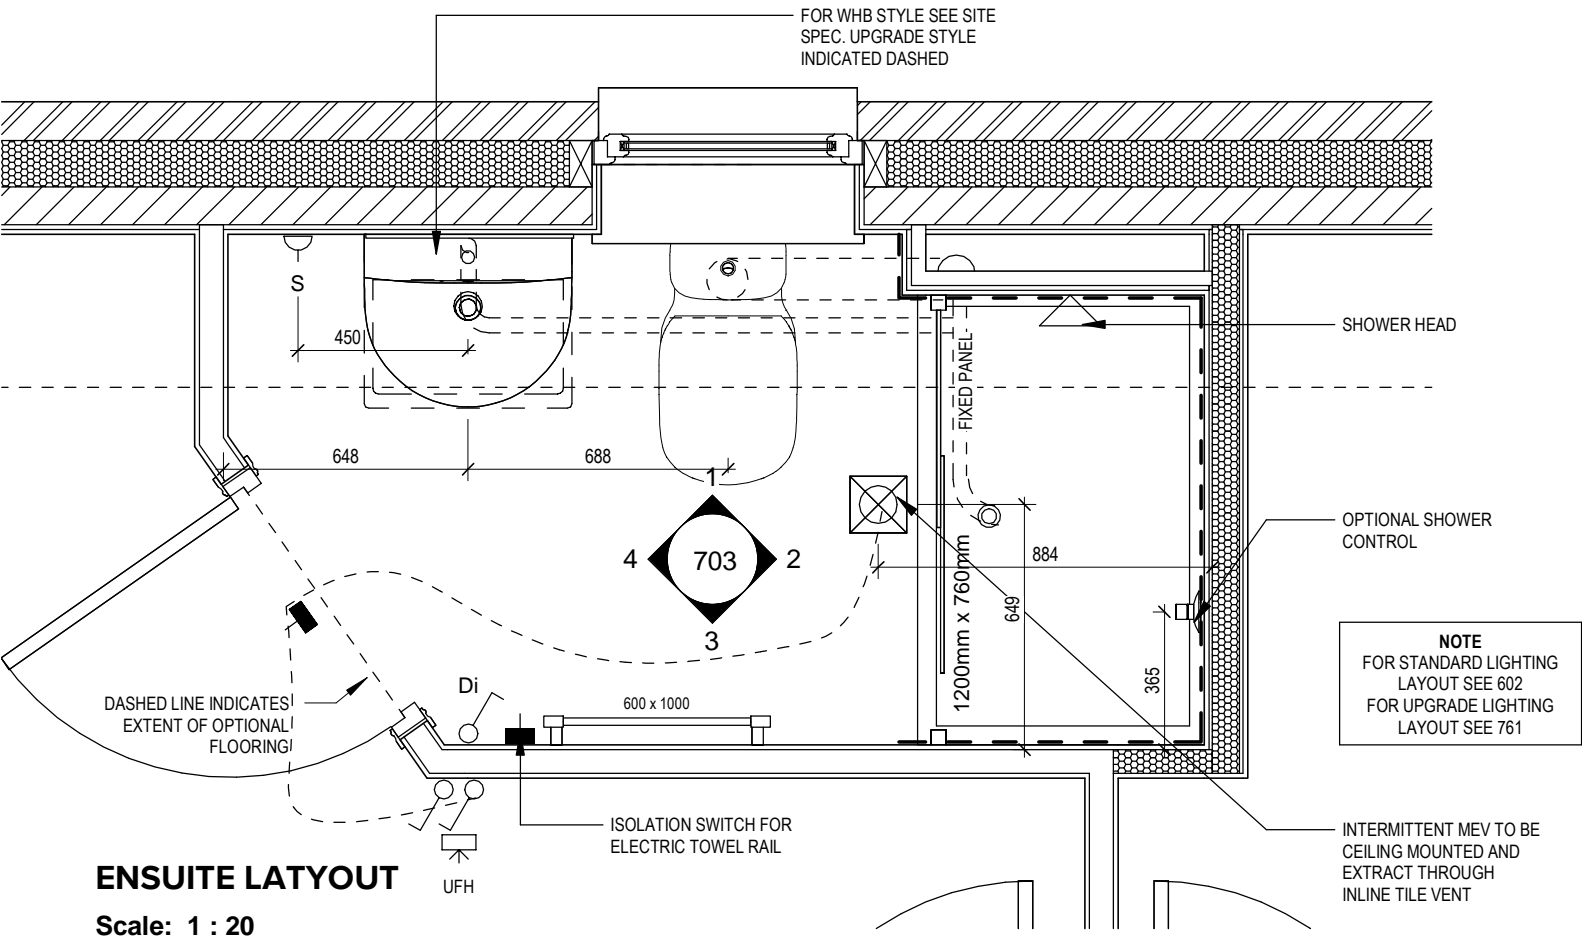


ENSUITE LATYOUT

Scale: 1 : 20

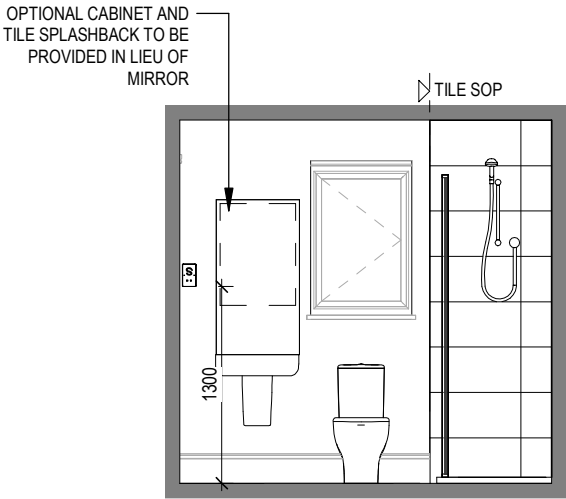


VIEW 1


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
VIEW 2

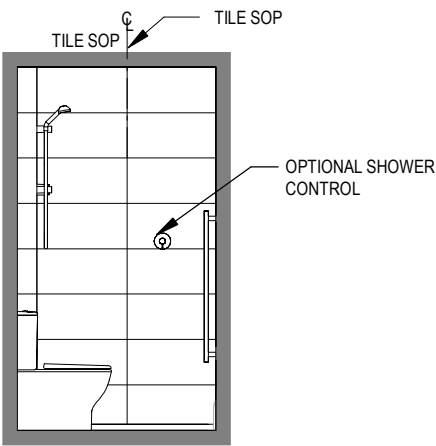

VIEW 3

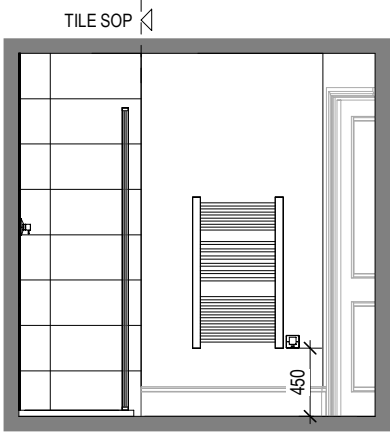

VIEW 4

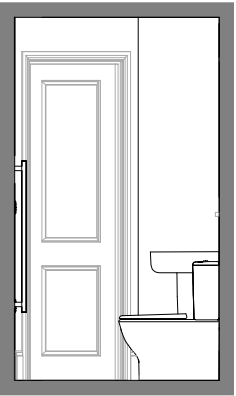

Shaftesbury

G SERIES

Ensuite Details

Scale	DCC	Dwg No	Dwg Rev
AS	2	703	
Date			
Feb 2023			


This drawing must be read in conjunction with relevant Redrow specifications, standard details & structural calculations. All dimension are taken from face of Brick/Block & Studwork. This drawing is subject to copyright law. Do Not Scale Off This Drawing.

ELECTRICAL LEGEND

- PELMET LIGHT FITTING
- FUSED OUTLET (IMMERSION)
- ISOLATOR SWITCH
- SINGLE SWITCH
- DOUBLE SWITCH
- TRIPLE SWITCH

NOTE: WHERE MULTIPLE SWITCHES ARE INDICATED TOGETHER THESE ARE TO BE SWITCHED ON ONE SINGLE PLATE NOT ON MULTIPLE PLATES.

- BANK OF SWITCHES TO ISOLATE HOB, EXTRACTOR HOOD, WASHING MACHINE, DISHWASHER, TUMBLE DRYER, FRIDGE/FREEZER, MICROWAVE OVEN, OPTIONAL WATER HEATER WITH NEON INDICATOR, ALL IN ACCORDANCE WITH THE APPLIANCE/SPACE PROVIDED ON LAYOUT.
- UNSWITCHED SOCKET / FUSED SPUR, TO BE CEILING MOUNTED, SEE STANDARD DETAILS
- SINGLE UNSWITCHED SOCKET (HIGH LEVEL)
- SINGLE UNSWITCHED SOCKET (LOW LEVEL)
- SINGLE UNSWITCHED FUSED SPUR (LOW LEVEL)
- DOUBLE S/W SOCKET OUTLET (HIGH LEVEL)
- DOUBLE S/W SOCKET OUTLET (LOW LEVEL)
- HEAT DETECTOR TO BS EN 14604: 2005, TO BE PERMANENTLY WIRED TO A SEPARATELY FUSED CIRCUIT AT THE DISTRIBUTION BOARD. WHERE MORE THAN ONE ARE INSTALLED THEY WILL BE INTER-CONNECTED. WIRING SHALL CONFORM TO IEE WIRING REGULATIONS. HEAT DETECTOR TO HAVE BATTERY BACKUP AND TO BE LOCATED A MIN. OF 300mm AWAY FROM ANY WALL AND LIGHT FITTING.
- DOUBLE S/W SOCKET OUTLET WITH USB (HIGH LEVEL)
- COOKER CONNECTION UNIT

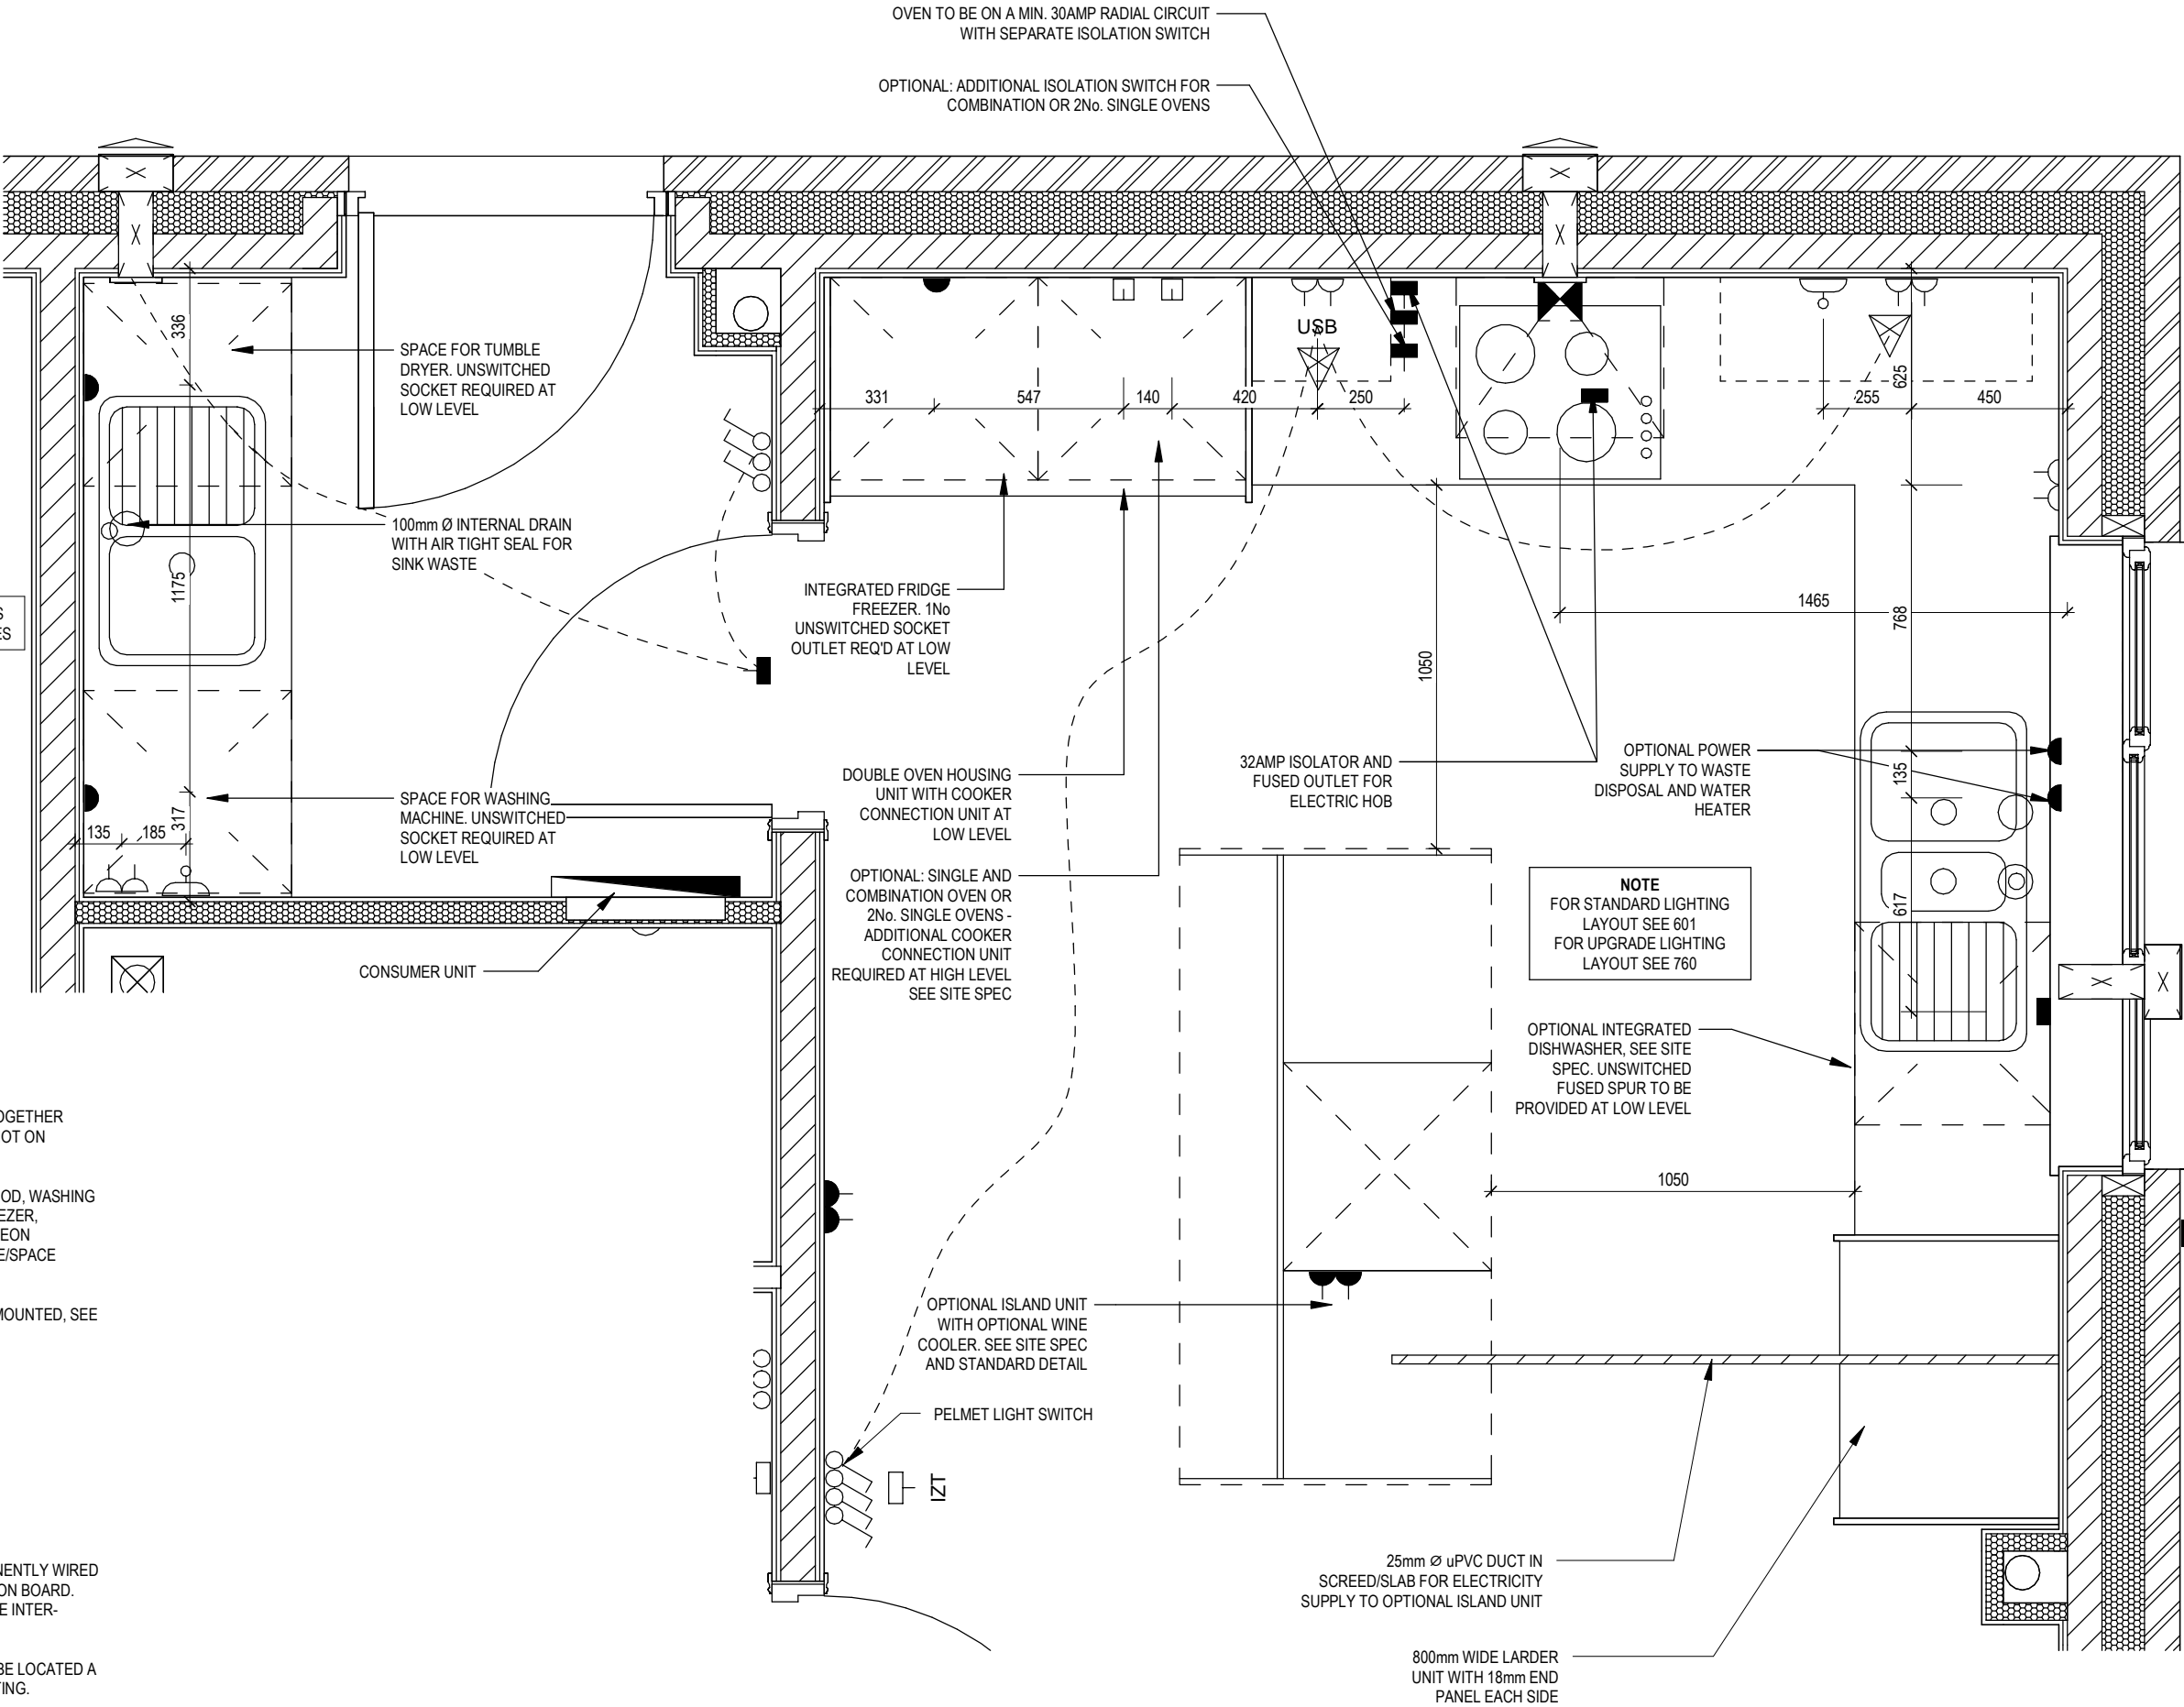

Dwg No

750

DCC

2

Dwg Rev

Scale

As Indicated

Date


Feb 2023

Kitchen Layout

Shaftesbury

G SERIES

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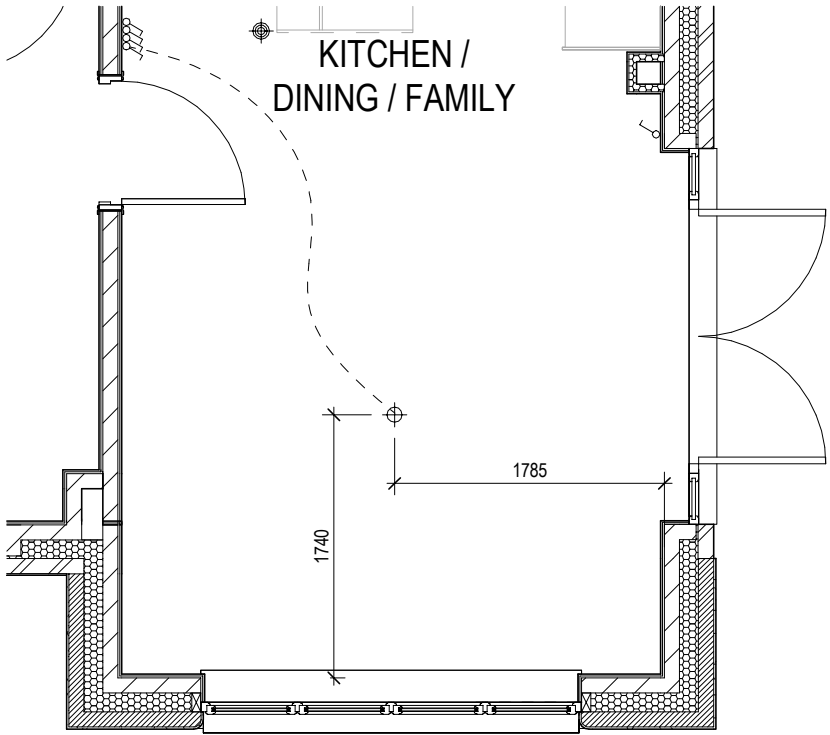


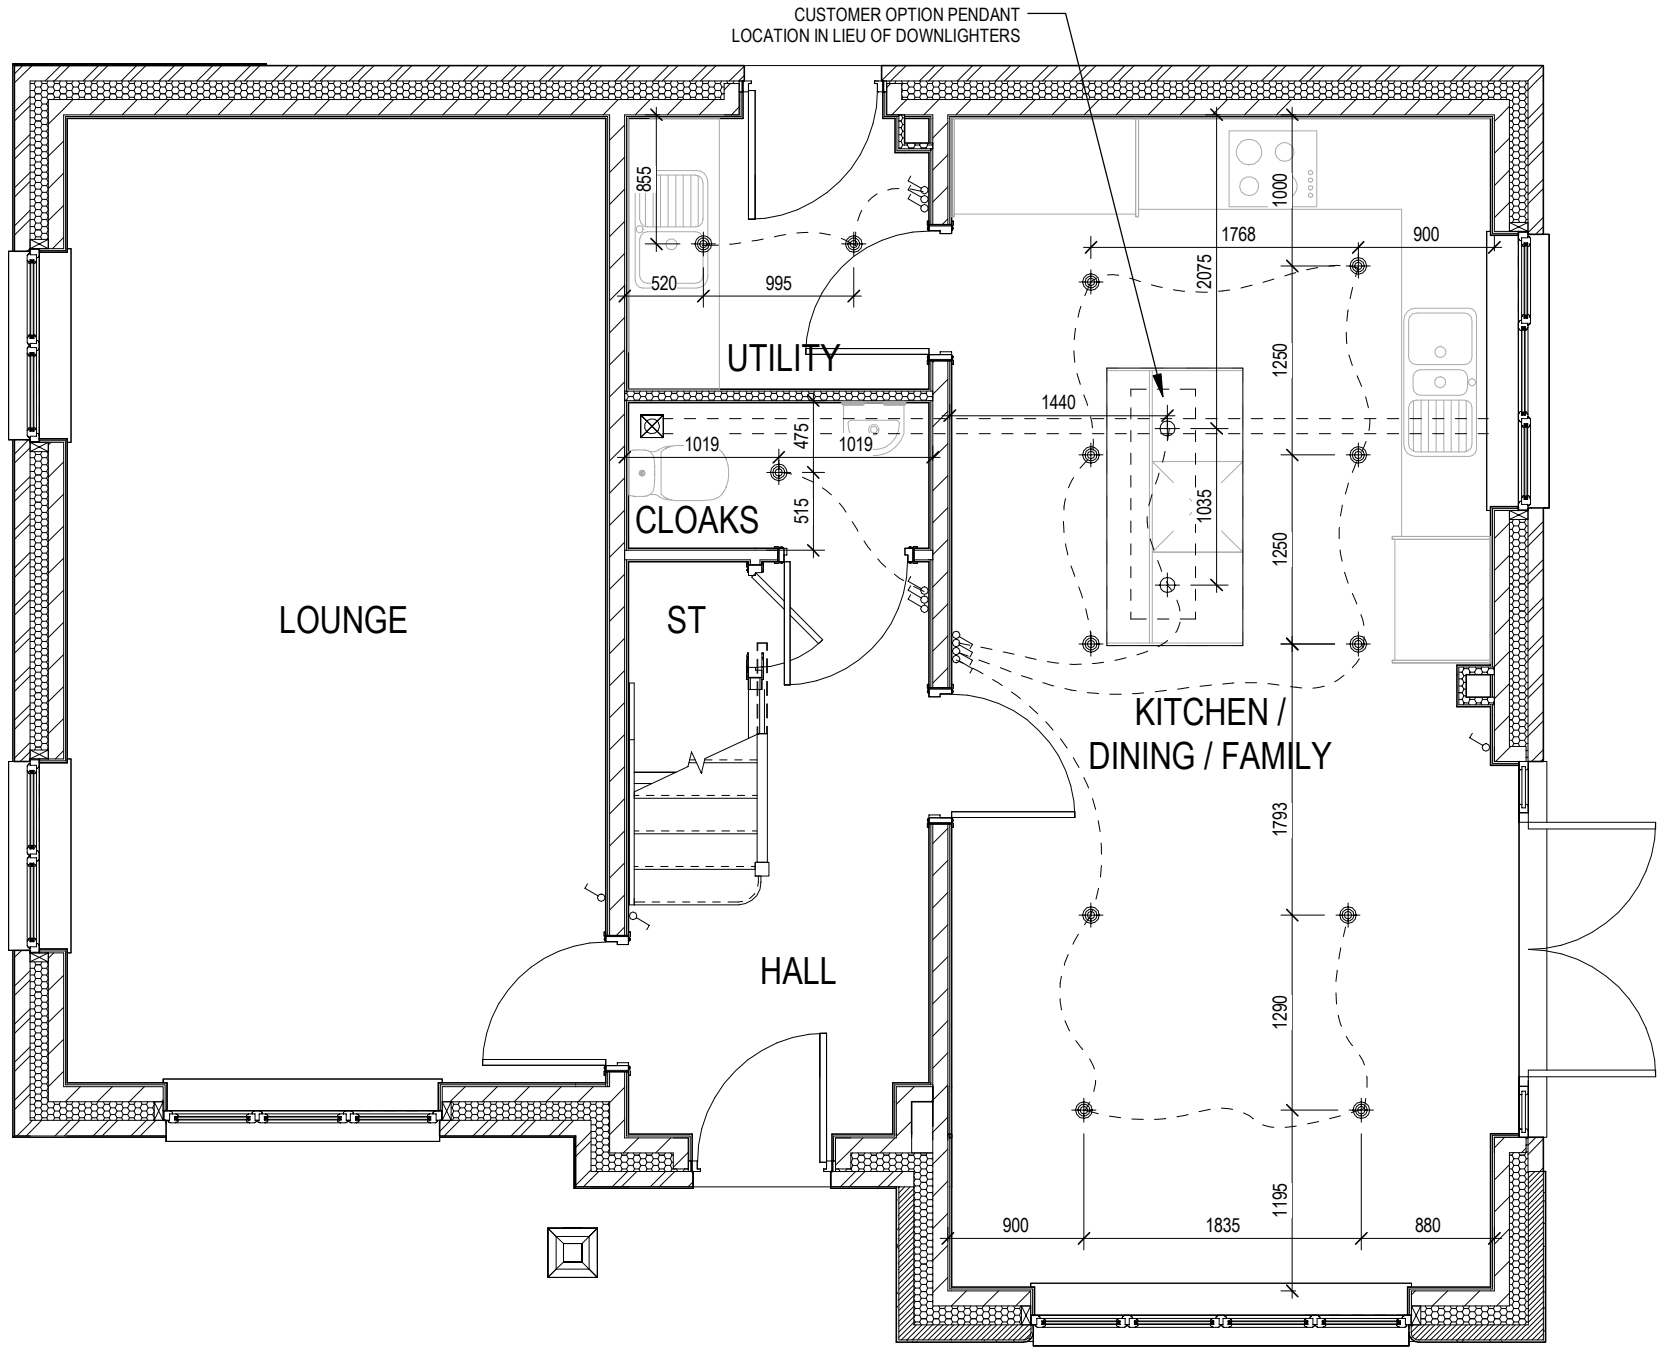UPGRADE / CUSTOMER OPTION LIGHTING LAYOUT

ELECTRICAL LEGEND

- OPTIONAL LOW VOLTAGE DOWNLIGHTER FITTING
- OPTIONAL PENDANT TYPE LIGHT FITTING
- INTERMITTENT MEV CEILING MOUNTED
- SINGLE SWITCH
- DOUBLE SWITCH
- TRIPLE SWITCH

NOTE: WHERE MULTIPLE SWITCHES ARE INDICATED TOGETHER THESE ARE TO BE SWITCHED ON ONE SINGLE PLATE NOT ON MULTIPLE PLATES.



SHOWHOME LIGHTING LAYOUT



Shaftesbury

G SERIES

Optional Lighting Layout
Ground Floor


Scale
1 : 50

Date
Feb 2023

DCC
2

Dwg No
760

Dwg Rev

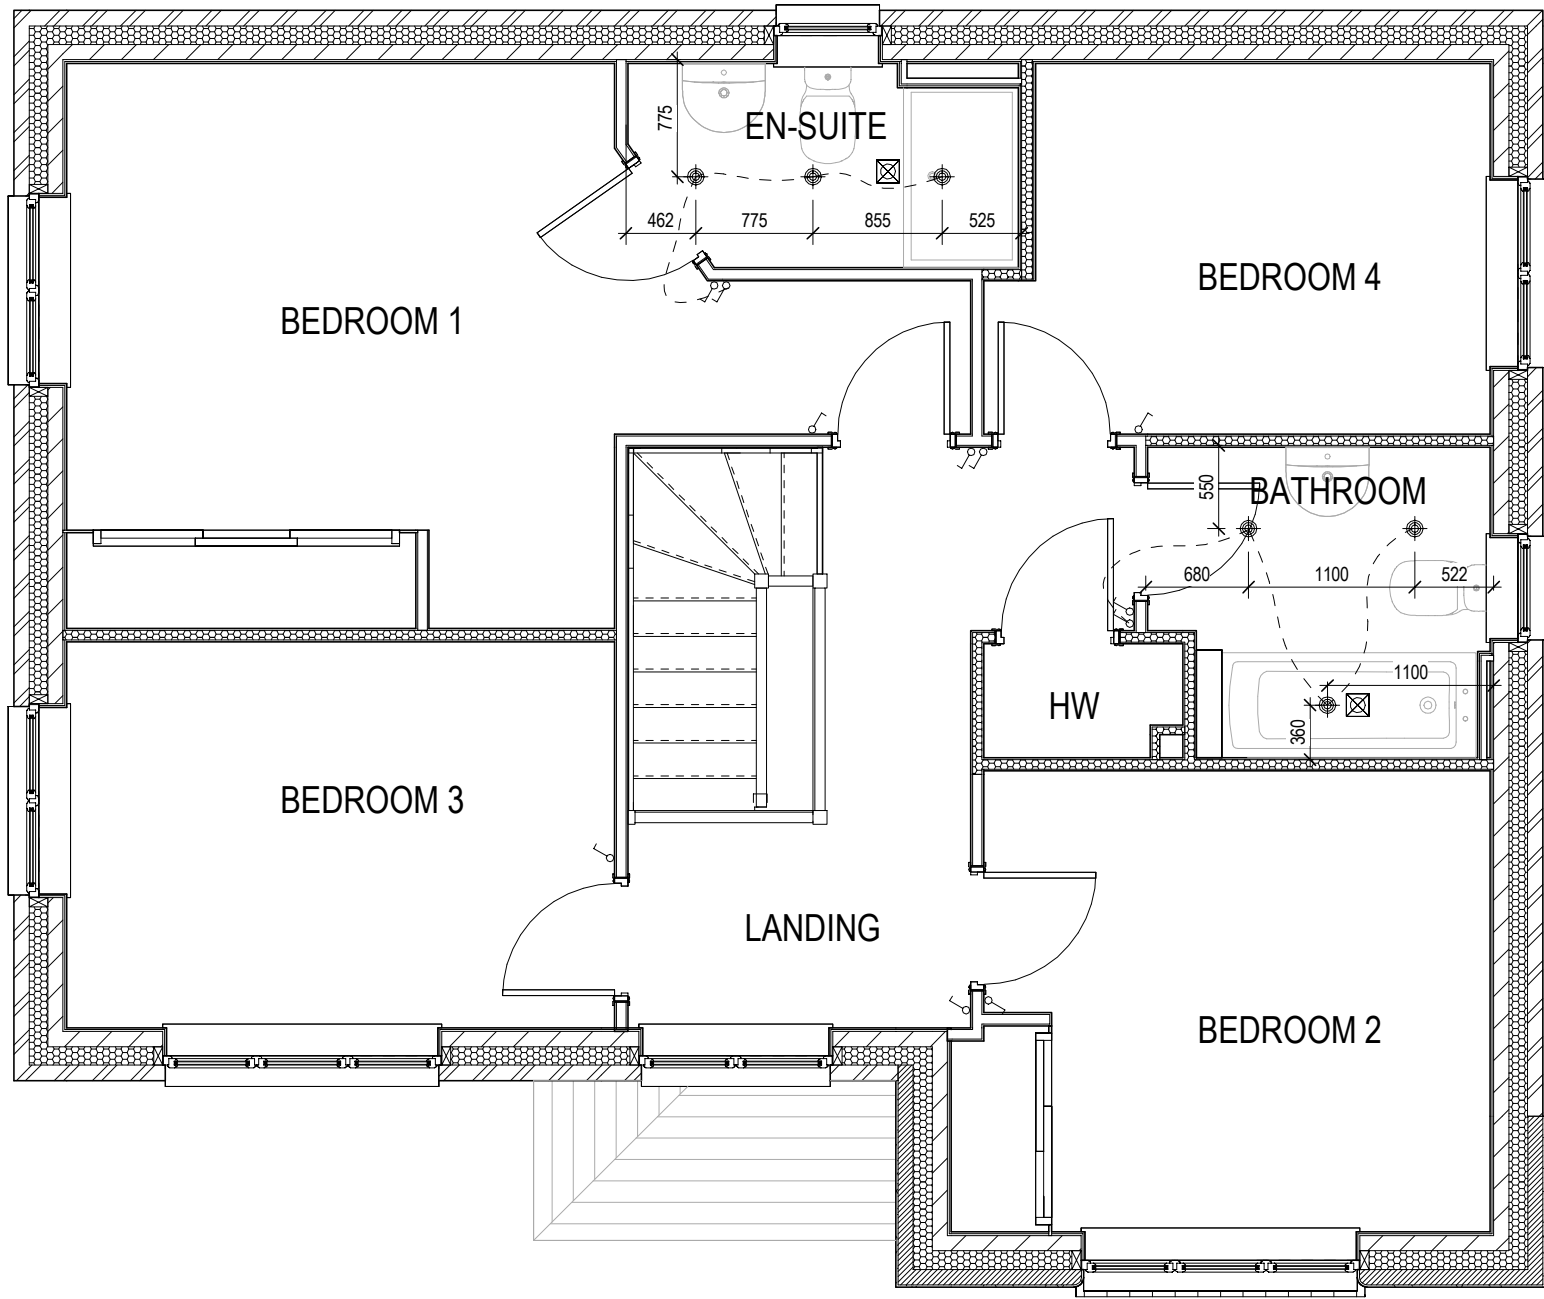

ELECTRICAL LEGEND

- OPTIONAL LOW VOLTAGE DOWNLIGHTER FITTING
 - OPTIONAL PENDANT TYPE LIGHT FITTING
 - INTERMITTENT MEV CEILING MOUNTED
 - SINGLE SWITCH
 - DOUBLE SWITCH
 - TRIPLE SWITCH
- NOTE: WHERE MULTIPLE SWITCHES ARE INDICATED TOGETHER THESE ARE TO BE SWITCHED ON ONE SINGLE PLATE NOT ON MULTIPLE PLATES.



Shaftesbury

G SERIES

Optional Lighting Layout
First Floor


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Date
Feb 2023


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2

Dwg No
761


Dwg Rev

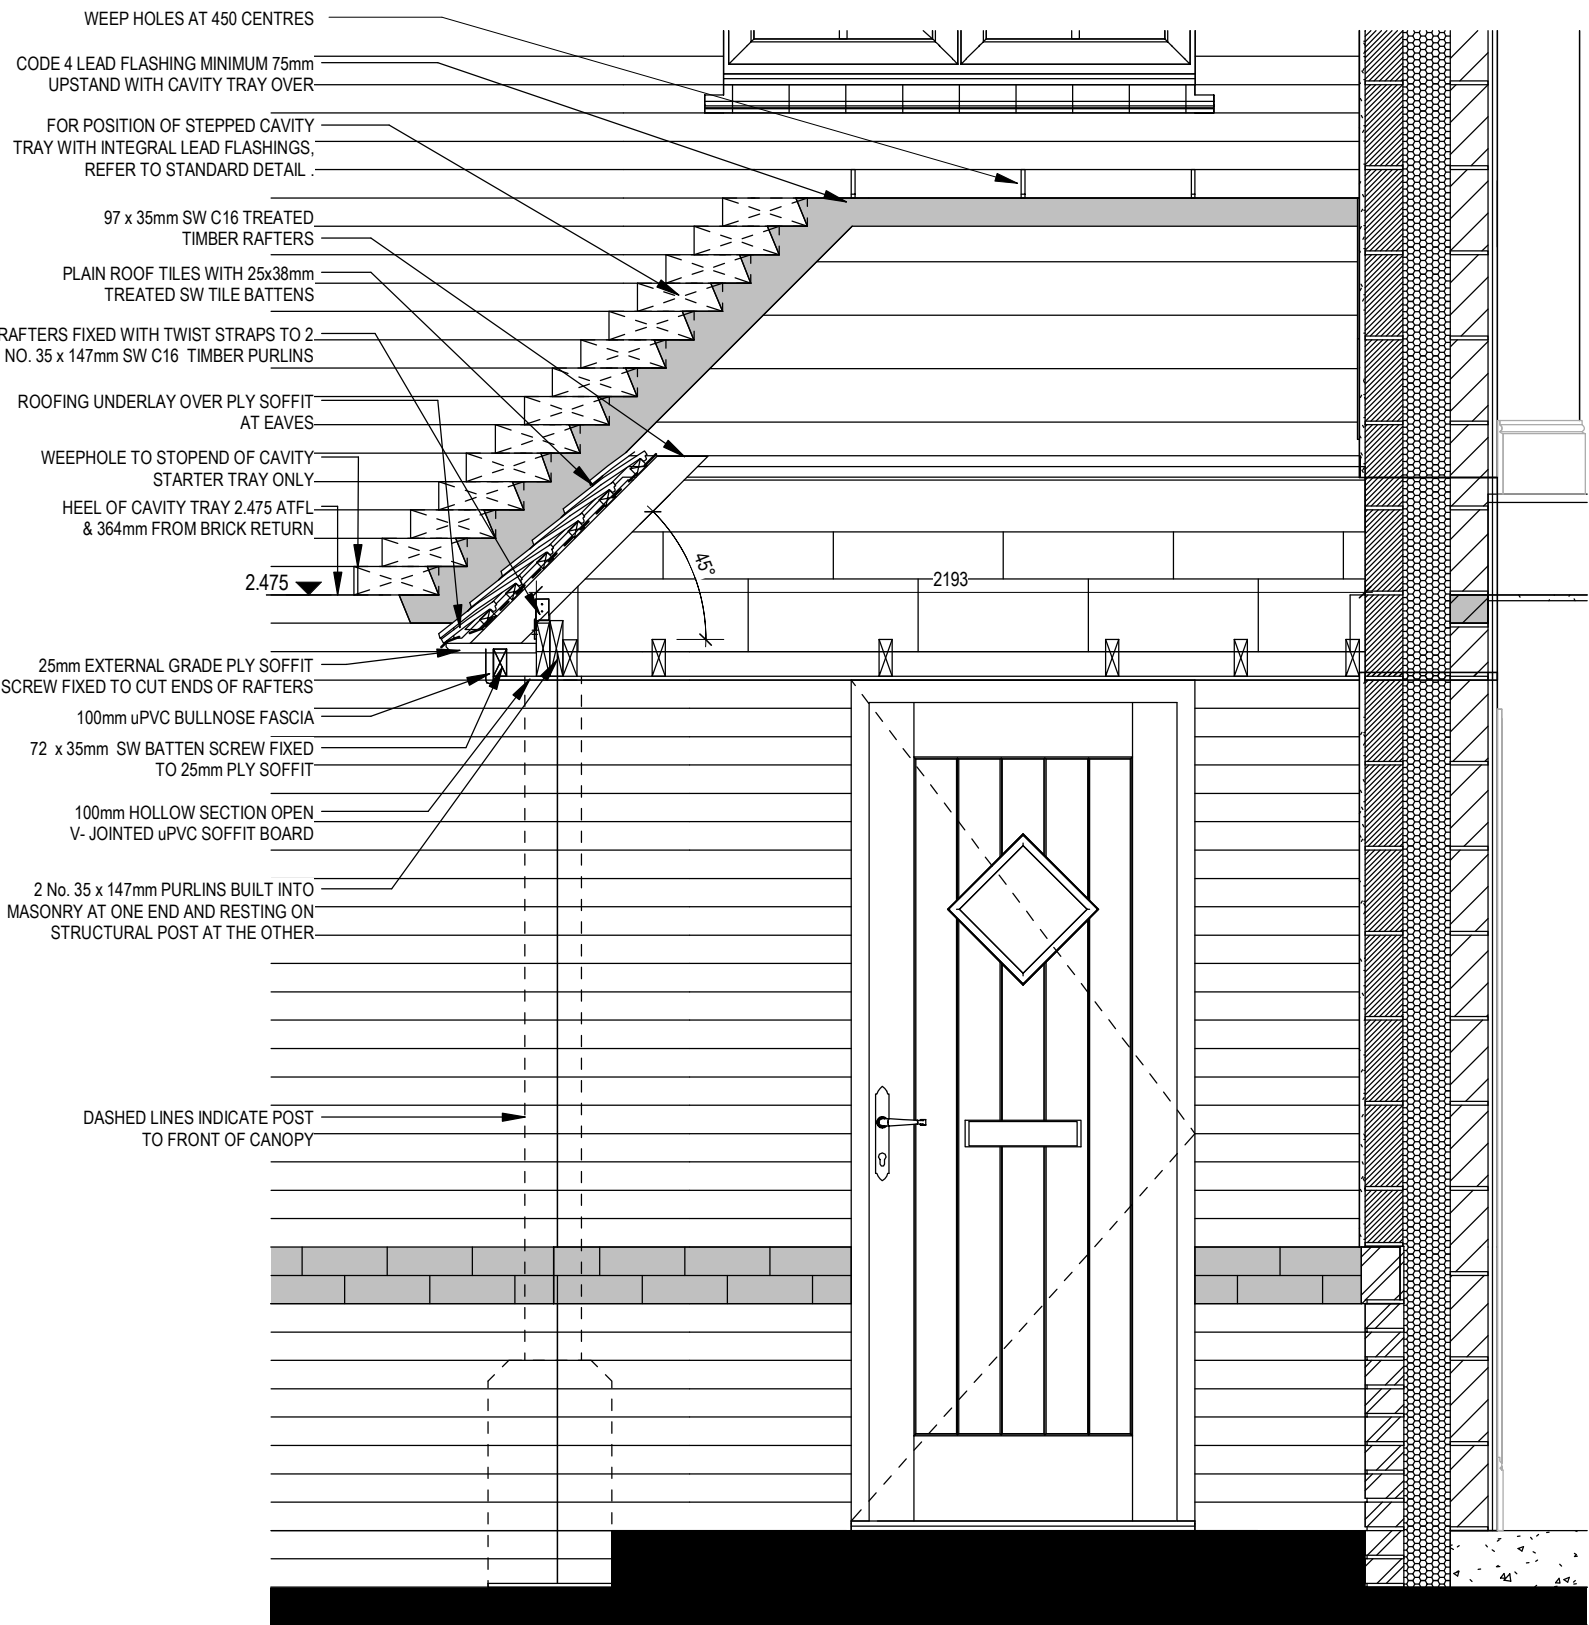

SECTION C-C

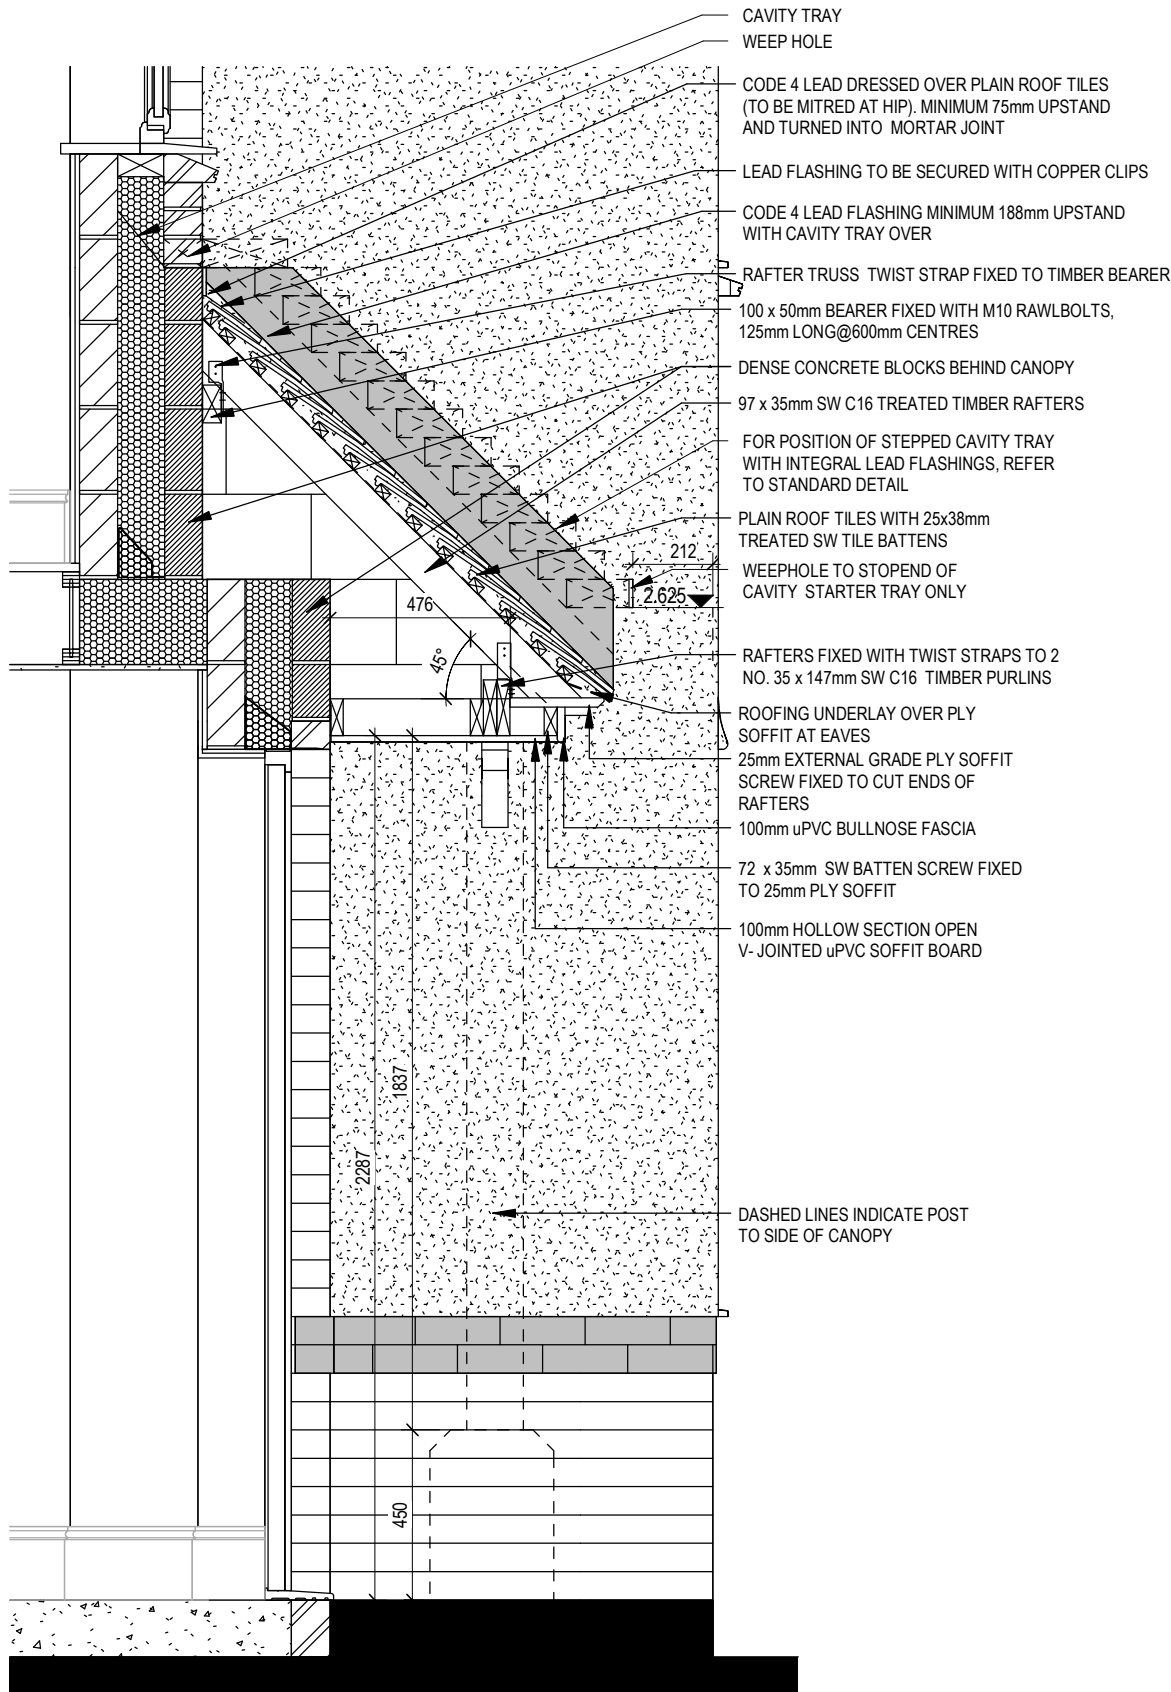

SECTION D-D

	Shaftesbury G SERIES	Canopy Details				Scale 1 : 20 Date Feb 2023	DCC 2	Dwg No 801	Dwg Rev A	02/10/23 A Weep holes added, Section D-D handed cavity trays added
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